



1  
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SCALE: NTS

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REPUBLIC OF THE PHILIPPINES  
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ENGINEER/BUILDING OFFICIAL

DISTRICT/CITY/MUNICIPALITY

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




ELECTRICAL

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ELECTRICAL


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




MECHANICAL
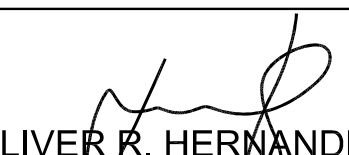
<div>REPUBLIC OF THE PHILIPPINES</div> <div></div> <div>DEPARTMENT OF EDUCATION</div> <div>PHYSICAL FACILITIES AND SCHOOLS ENGINEERING DIVISION</div> <div>MERALCO AVENUE, PASIG CITY</div>	PREPARED BY :	CHECKED BY :	RECOMMENDING APPROVAL :	APPROVED BY :	PROJECT TITLE :	PROJECT NO: 00200511	OWNER :	SHEET NO:
	<div></div> <div>MAXIMO M. CALBANG</div> <div>PDO - III</div> <div>PFSED-DepED</div>	<div></div> <div>NATHANIEL Q. MENDOZA</div> <div>ARCHITECT III</div> <div>PFSED-DepED</div>	<div></div> <div>LUIS G. PURISIMA JR.</div> <div>HEAD, PLANNING AND DESIGN UNIT</div> <div>PFSED-DepED</div>	<div></div> <div>OLIVER R. HERNANDEZ</div> <div>CHIEF, PFSED-OPS</div> <div>DepED</div>	ONE STOREY TWO CLASSROOM 7x9m (MODIFIED)	DESIGNED BY: NQM	DEPARTMENT OF EDUCATION DepED	PERSPECTIVE VIEW TABLE OF CONTENTS
						ENCODED BY: Max C.		
					LOCATION :	CHECKED BY: LGP		
						DATE : 01 01 2005		<div>A - 1</div> <div>3</div>

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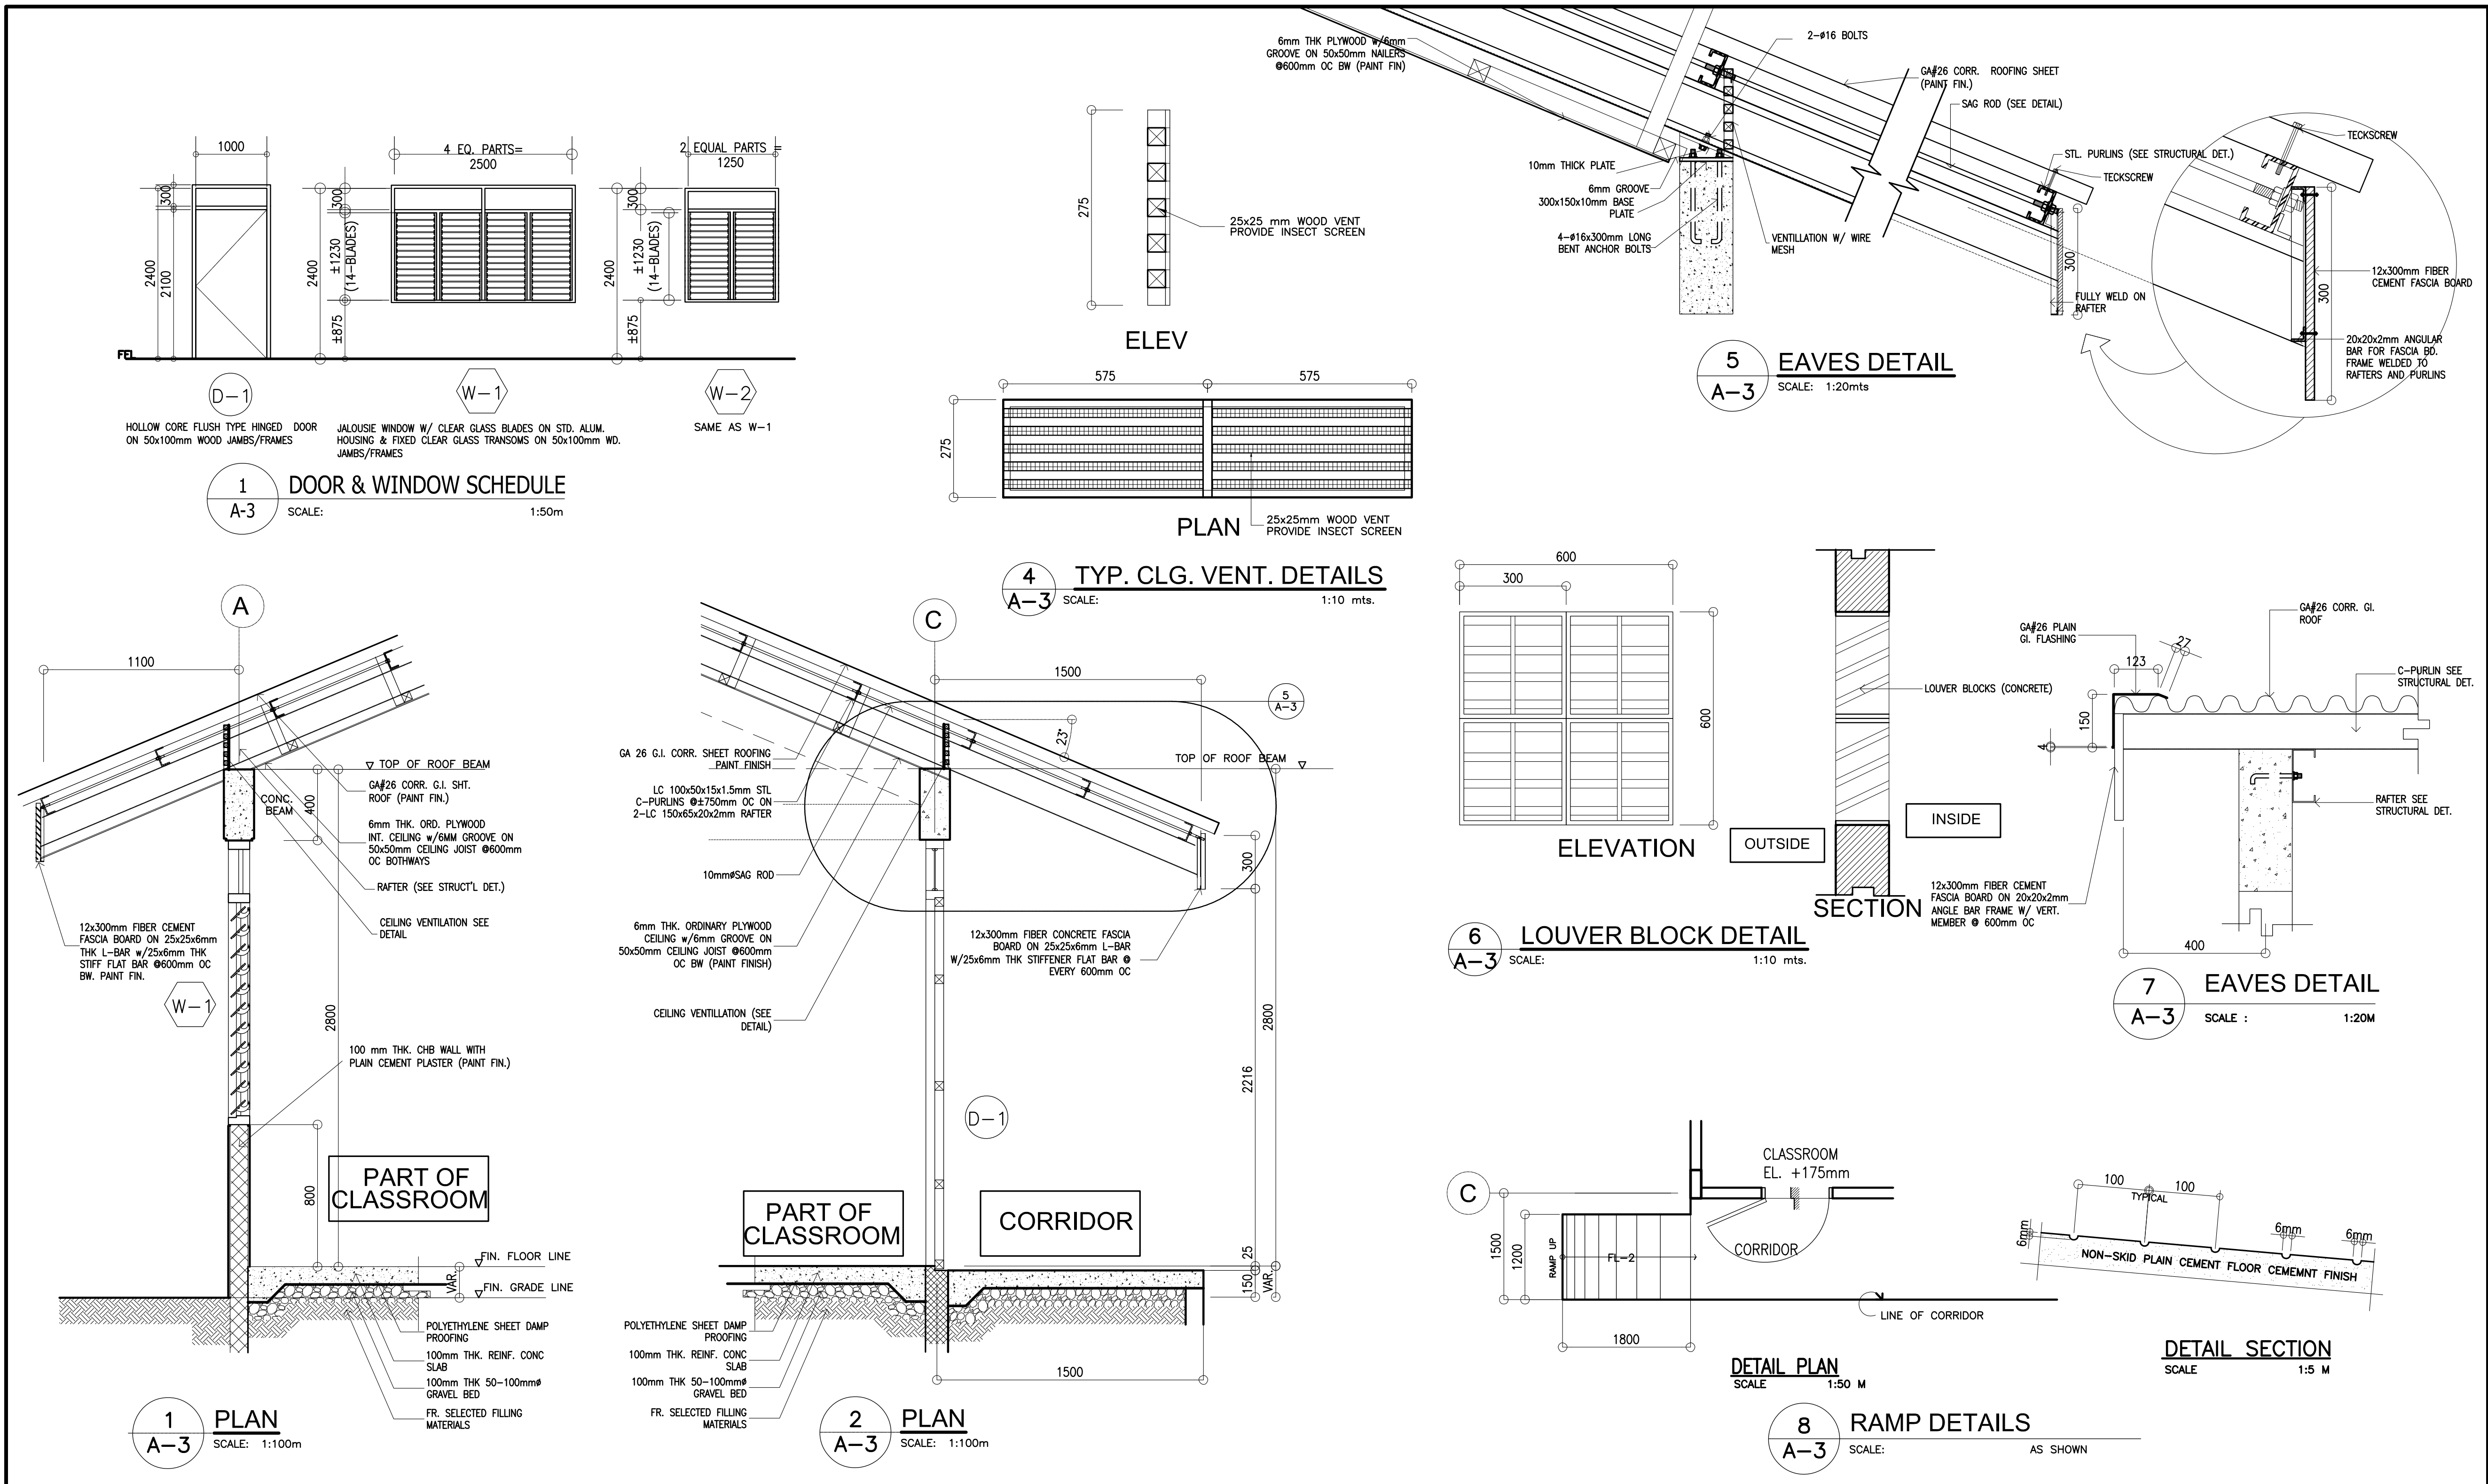


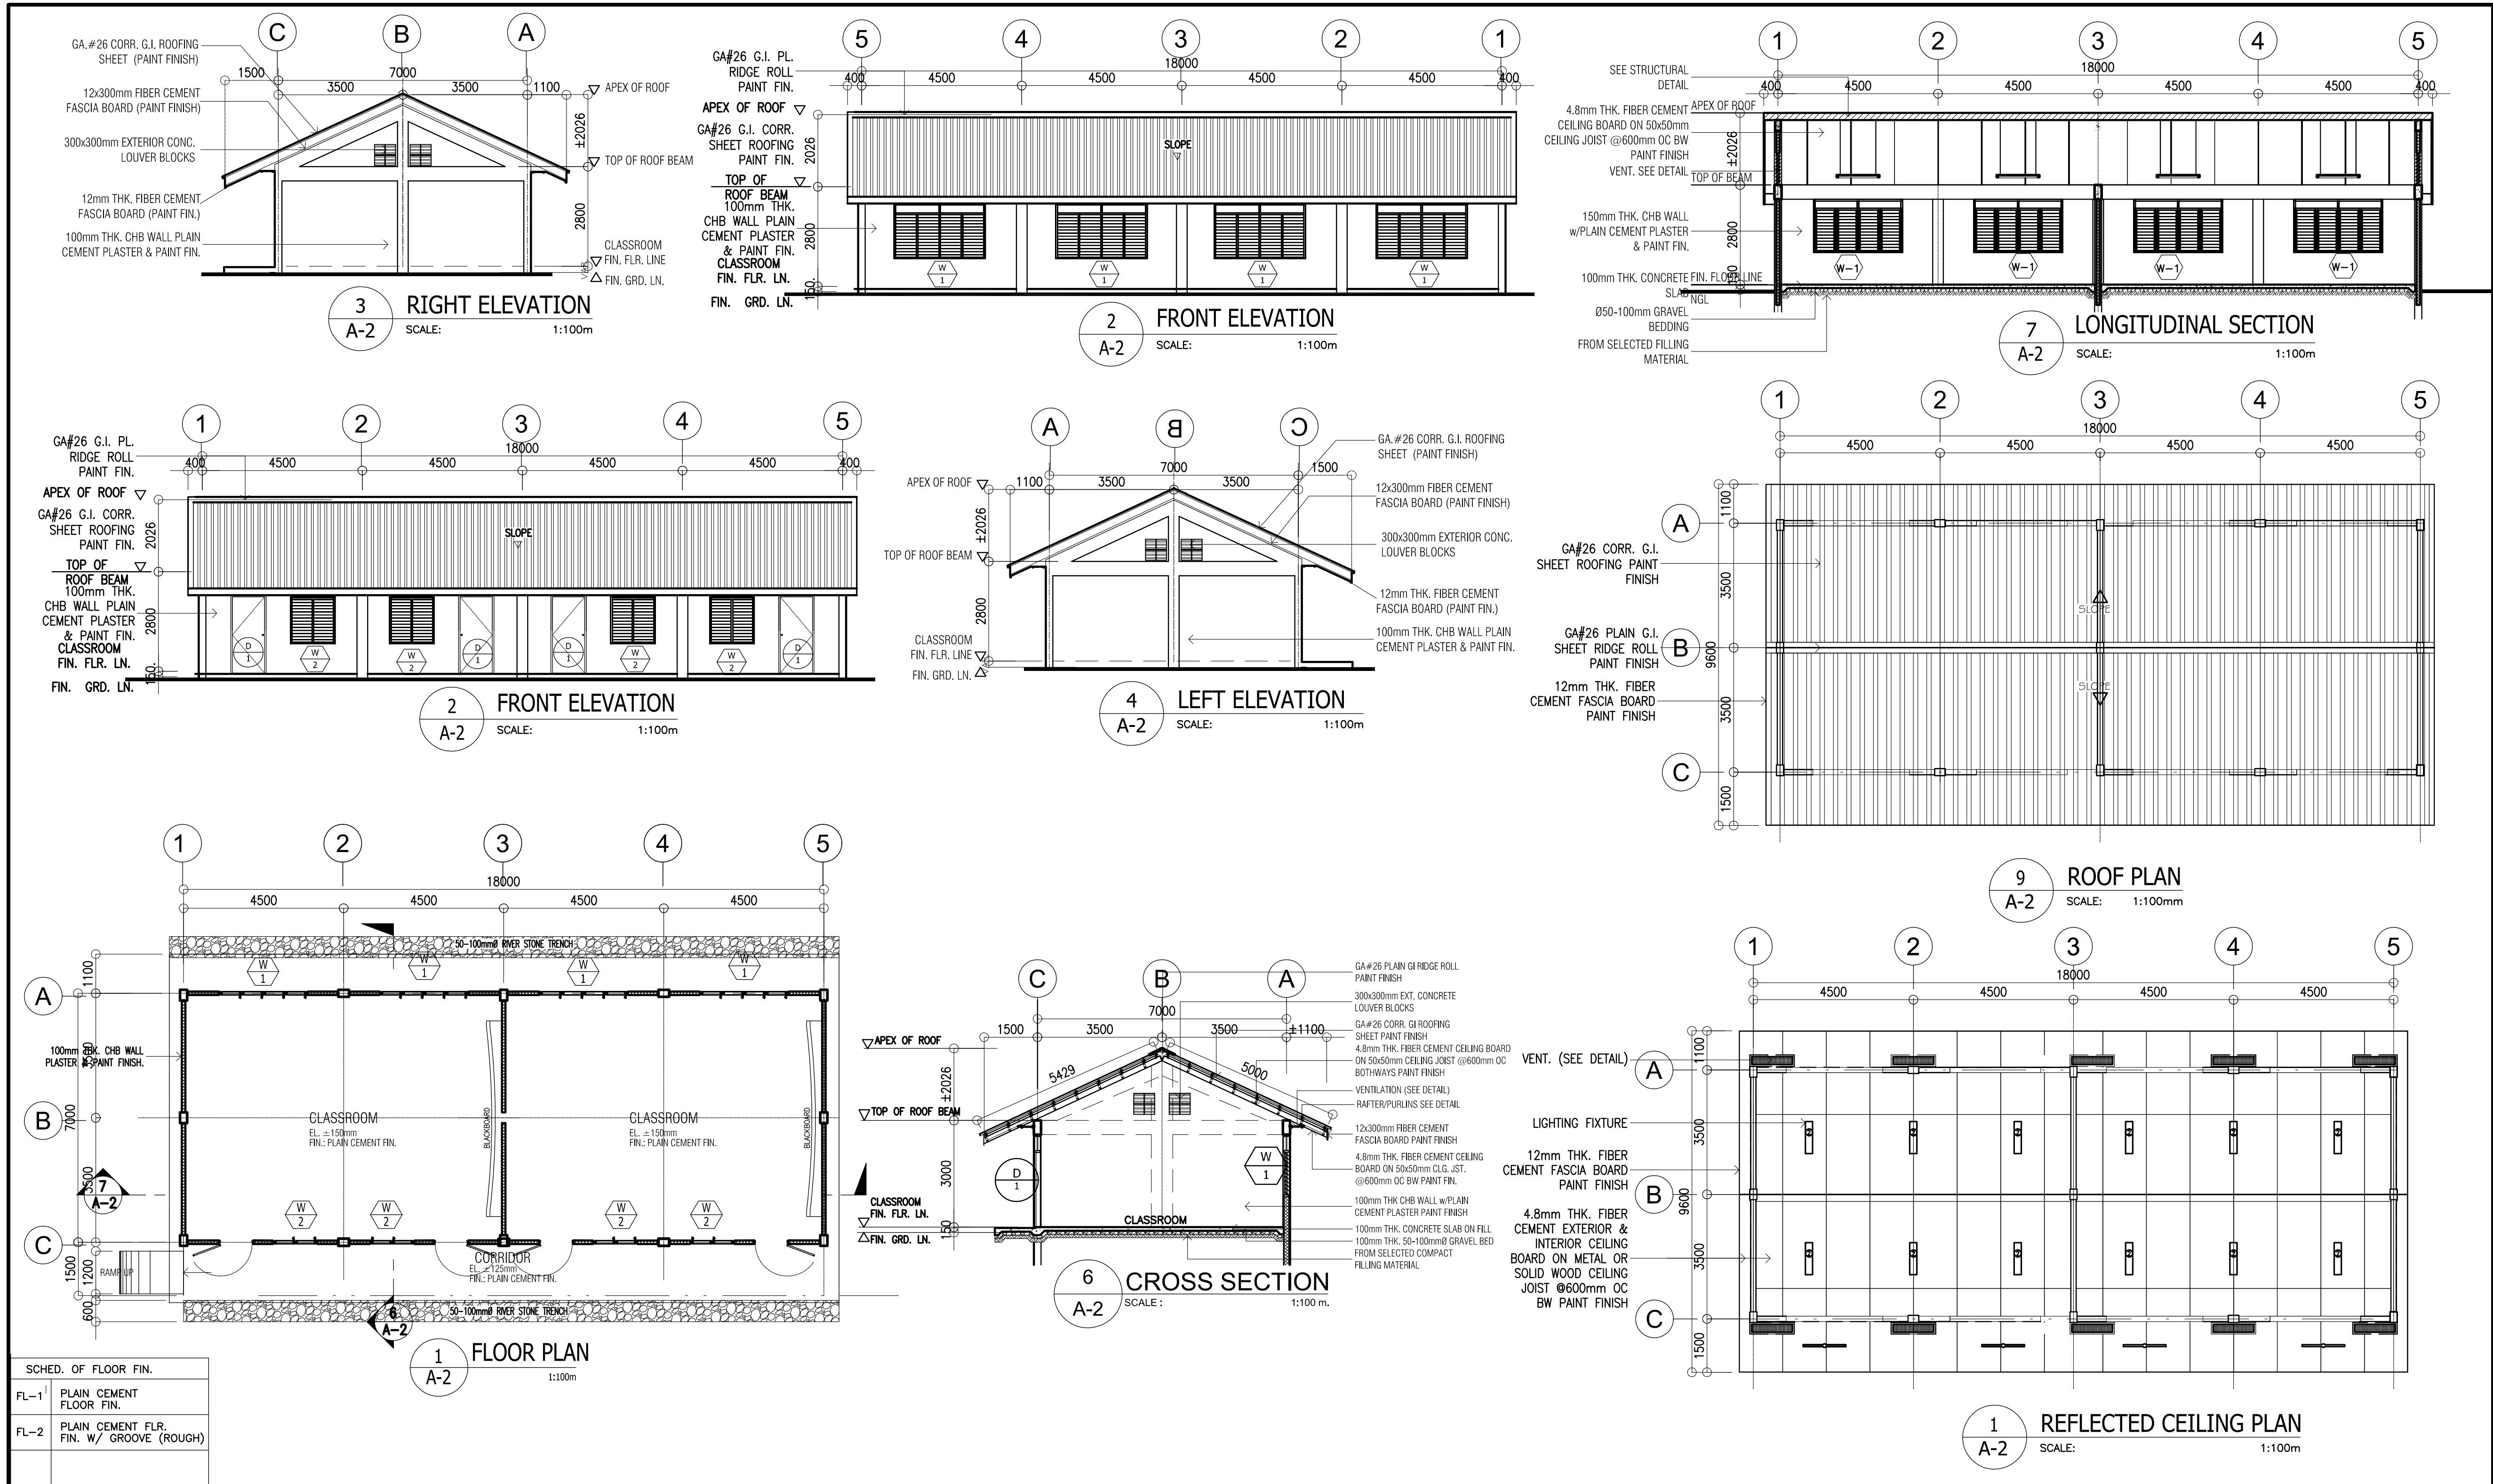REPUBLIC OF THE PHILIPPINES		PREPARED BY :	CHECKED BY :	RECOMMENDING APPROVAL :	APPROVED BY :	PROJECT TITLE :	PROJECT NO: 00200511	OWNER :	SHEET NO:
		 MAXIMINO M. CALBANG PDO - III PFSED-DepEd	 NATHANIEL Q. MENDOZA ARCHITECT III PFSED-DepEd	 LUIS G. PURISIMA JR. HEAD, PLANNING AND DESIGN UNIT PFSED-DepEd	 OLIVER R. HERNANDEZ CHIEF, PFSED-OPS DepEd	ONE STOREY TWO CLASSROOM 7x9m (MODIFIED)	DESIGNED BY: NQM ENCODED BY: Max C. CHECKED BY: LGP DATE: 01 01 2005	DEPARTMENT OF EDUCATION DepEd SHEET CONTENTS : FLOOR, REFLECTED CLG., ROOF PLANS, FRONT, RIGHT, REAR, LEFT ELEVATIONS, CROSS, LONGITUDINAL SECTIONS	A - 2 3

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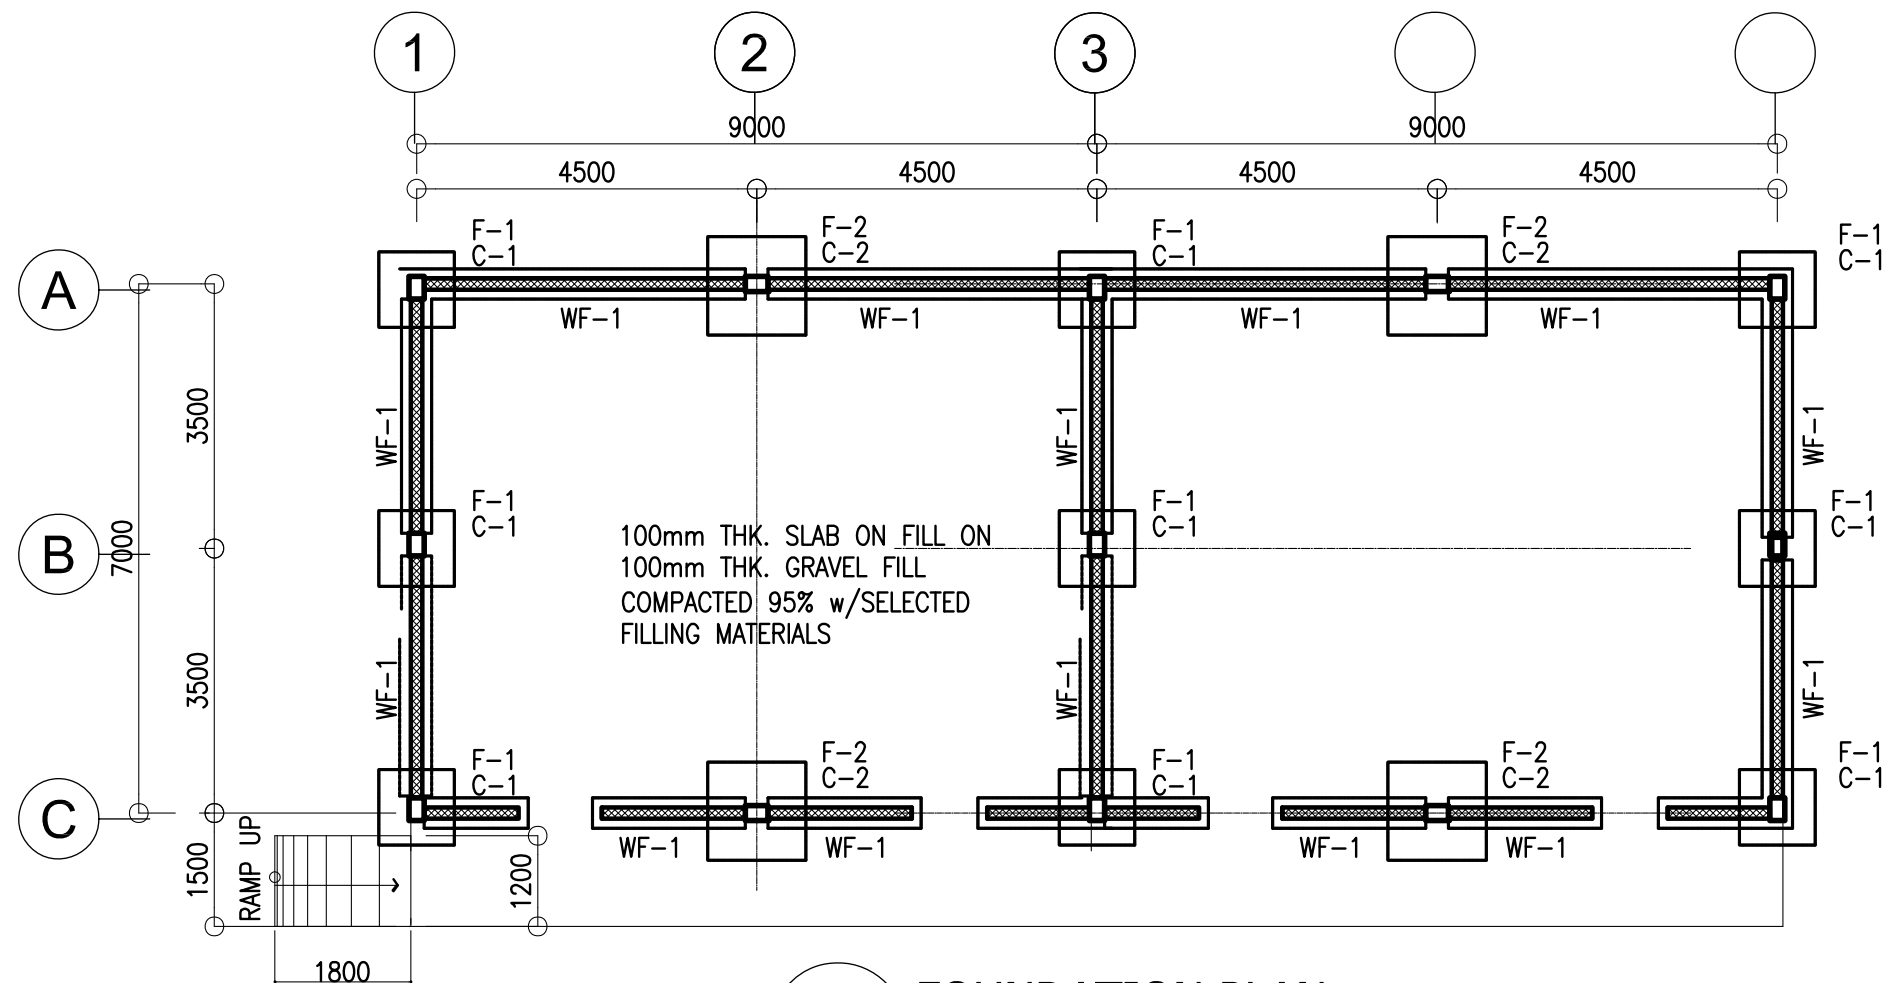
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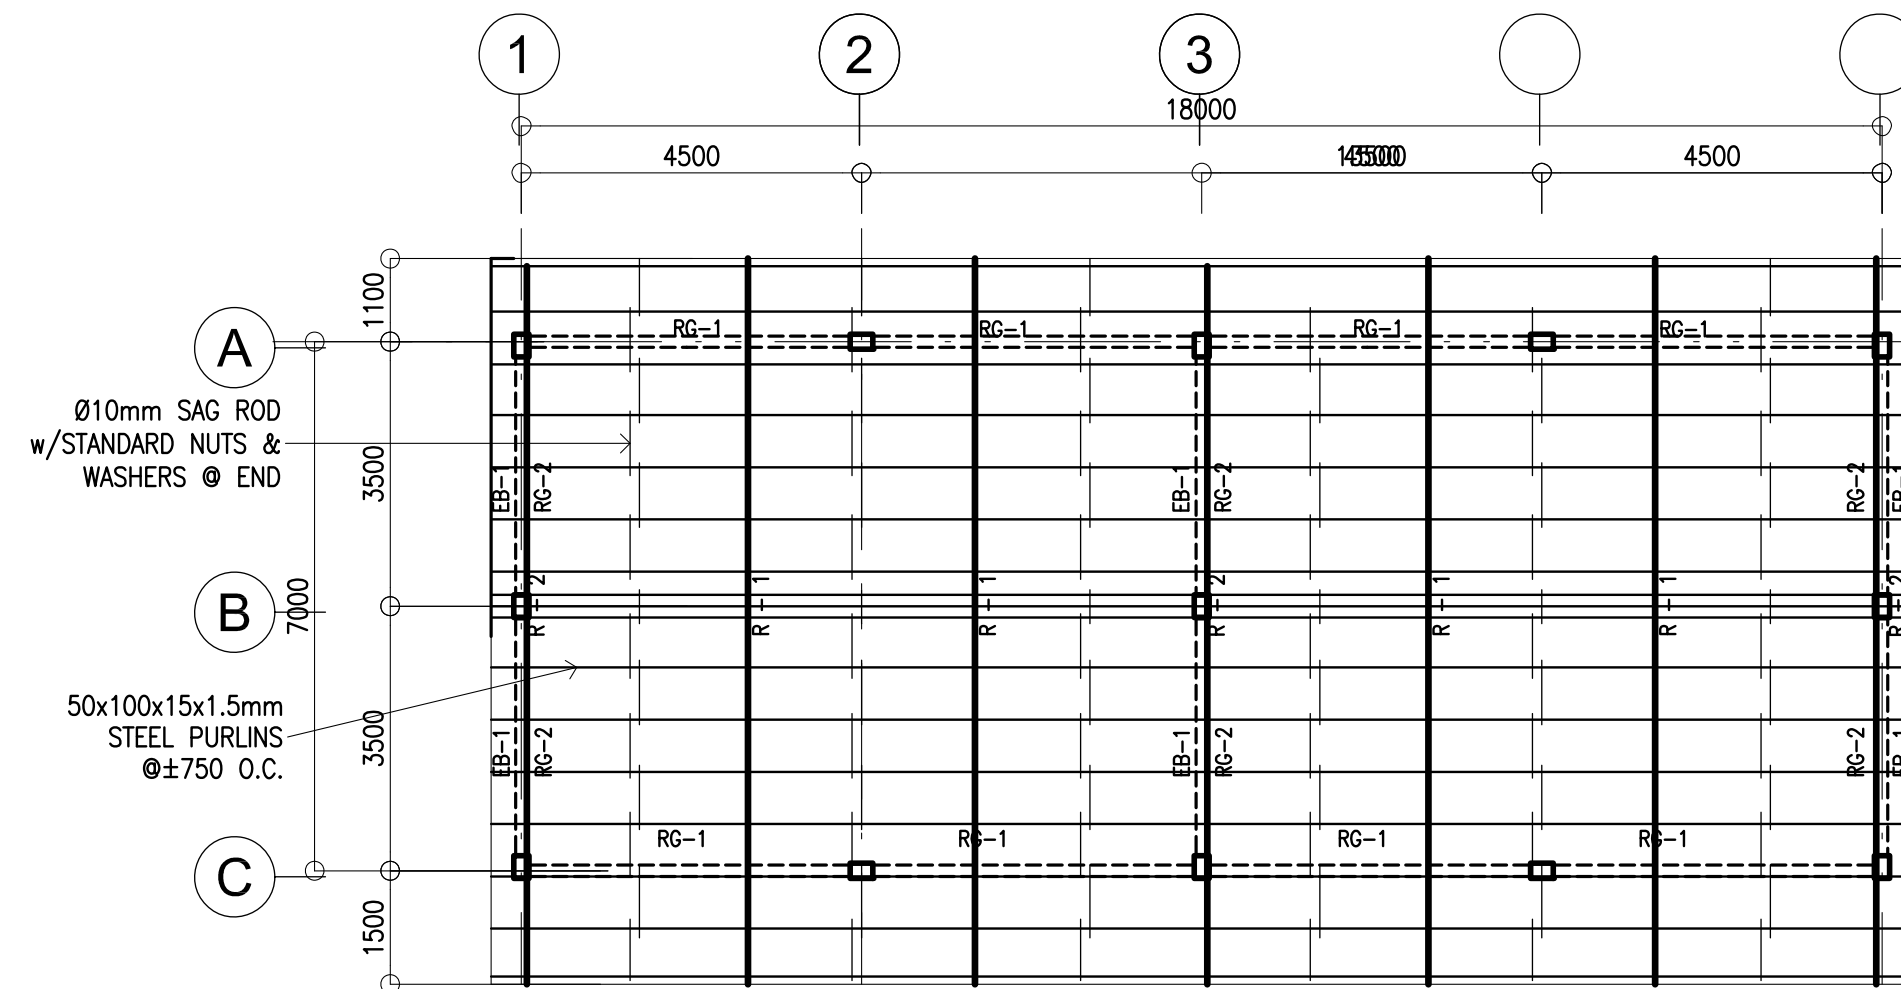


<p>REPUBLIC OF THE PHILIPPINES</p> <p><b>DepED</b></p> <p>DEPARTMENT OF EDUCATION</p> <p>PHYSICAL FACILITIES AND SCHOOLS ENGINEERING DIVISION</p> <p>MERALCO AVENUE, PASIG CITY</p>	<p>PREPARED BY :</p> <p><i>Maximo M. Calbang</i></p> <p>MAXIMO M. CALBANG</p> <p>PDO - III</p> <p>PFSED-DepED</p>	<p>CHECKED BY :</p> <p><i>Nathaniel Q. Mendoza</i></p> <p>NATHANIEL Q. MENDOZA</p> <p>ARCHITECT III</p> <p>PFSED-DepED</p>	<p>RECOMMENDING APPROVAL :</p> <p><i>Luis G. Purisima Jr.</i></p> <p>LUIS G. PURISIMA JR.</p> <p>HEAD, PLANNING AND DESIGN UNIT</p> <p>PFSED-DepED</p>	<p>APPROVED BY :</p> <p><i>Oliver R. Hernandez</i></p> <p>OLIVER R. HERNANDEZ</p> <p>CHIEF, PFSED-OPS</p> <p>DepED</p>	<p>PROJECT TITLE :</p> <p>ONE STOREY TWO CLASSROOM 7x9m (MODIFIED)</p> <p>LOCATION :</p>	<p>PROJECT NO: 00200511</p> <p>DESIGNED BY: NQM</p> <p>ENCODED BY: Max C.</p> <p>CHECKED BY: LGP</p> <p>DATE: 01 01 2005</p>	<p>OWNER :</p> <p>DEPARTMENT OF EDUCATION DepED</p> <p>SHEET CONTENTS : DOOR &amp; WINDOW SCHEDULE DETAILS</p>	<p>SHEET NO:</p> <p>A - 3</p> <p>3</p>
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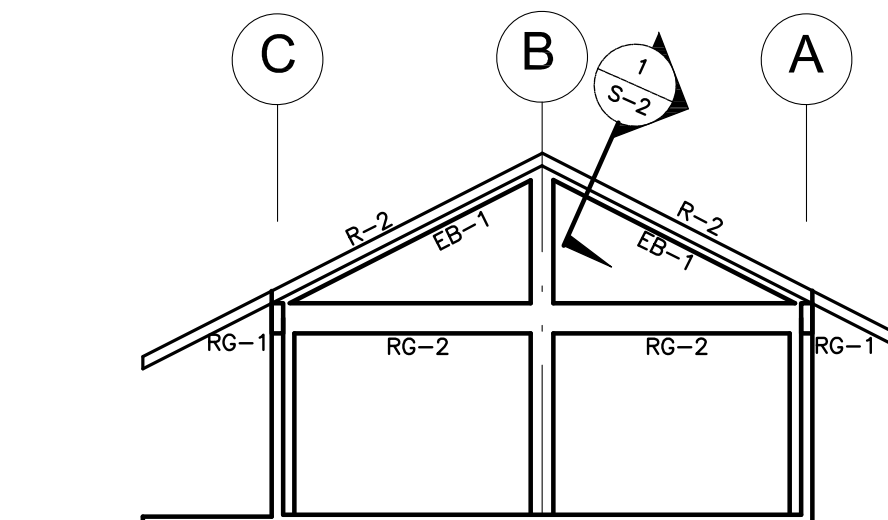
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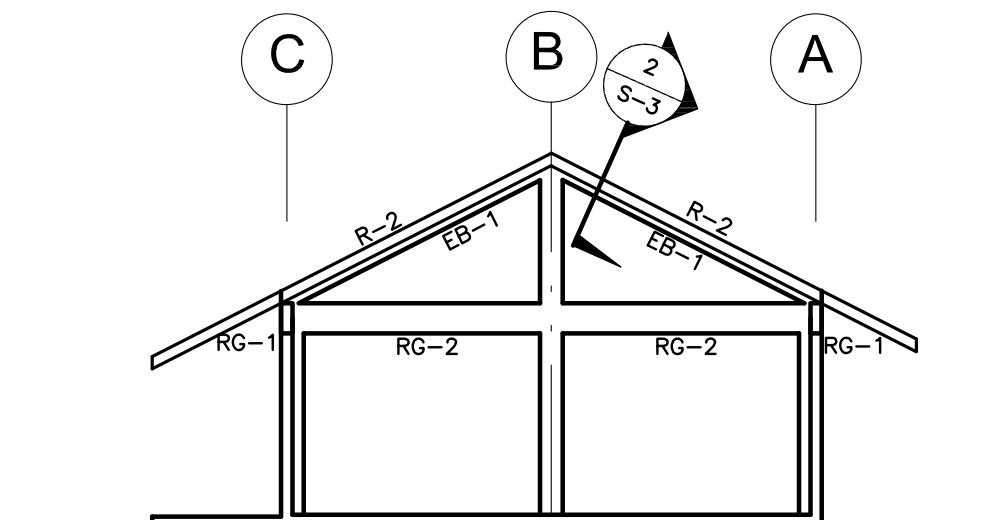
**A**  
**S-1**  
**FOUNDATION PLAN**  
SCALE: 1:100m




**B**  
**S-1**  
**ROOF FRAMING PLAN**  
SCALE: 1:100m



**C**  
**S-1**  
**ELEV END GRID**  
SCALE: 1:100m



**D**  
**S-1**  
**ELEV PARTITION GRID**  
SCALE: 1:100m

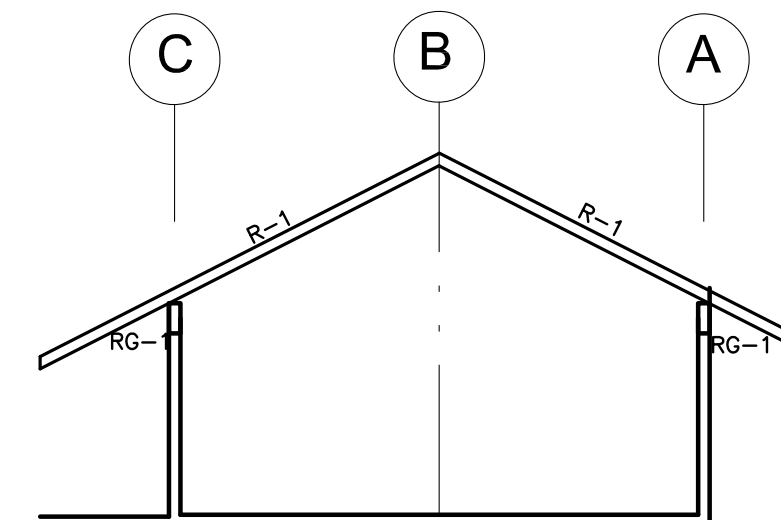

**E**  
**S-1**  
**ELEV BETWEEN GRID**  
SCALE: 1:100m

COLUMN SCHEDULE		
LEVEL	C-1	C-2
FOUNDATION LEVEL TO ROOF LEVEL	<p>MAIN BAR: 4-Ø16mm</p> <p>TIES : Ø10 mm 1@50, 8@75, REST @ 150mm TO CENTER</p>	<p>MAIN BAR: 6-Ø16mm</p> <p>TIES : Ø10 mm 1@50, 8@75, REST @ 150mm TO CENTER</p>

SCHEDULE OF FOOTINGS							
FOOTING MARK	FOOTING DIMENSIONS (mm)				REINFORCEMENT		REMARKS
	LENGTH (L)	WIDTH (W)	DEPTH (D)	THICKNESS (t)	BAR X	BAR Y	
F-1	800	800	1200	250	4 - 16mmØ	4 - 16mmØ	SQUARE FOOTING
F-2	1000	1000	1200	250	4 - 16mmØ	4 - 16mmØ	SQUARE FOOTING

#### DESIGN CRITERIA :

##### A. CONCRETE

$f_c' = 20.685 \text{ Mpa ( 3,000 Psi )}$ , minimum compressive strength of concrete a 28 days unless otherwise specified.

##### B. REBAR

$f_y = 275.8 \text{ Mpa ( 40,000 Psi )}$ , minimum yield strength of reinforcing bars unless otherwise specified.

##### C. STRUCTURAL STEEL

$F_y = 248 \text{ Mpa ( 36 Kai )}$ , specified minimum yield strength unless otherwise specified.


##### D. FOUNDATION

$SBP = 95.706 \text{ Kpa ( 2,000 Psf )}$ , was used in the design for all footings. No footing shall rest on fill.


<p>REPUBLIC OF THE PHILIPPINES <b>DepED</b> DEPARTMENT OF EDUCATION PHYSICAL FACILITIES AND SCHOOLS ENGINEERING DIVISION MERALCO AVENUE, PASIG CITY</p>	PREPARED BY :  <b>MAXIMINO M. CALBANG</b> PDO - III PFSED-DepED	CHECKED BY :  <b>ANTONIA M. ALHAMBRA</b> CIVIL ENGINEER/MASTER PLUMBER PFSED-DepED	RECOMMENDING APPROVAL :  <b>LUIS C. PURISIMA JR.</b> HEAD, PLANNING AND DESIGN UNIT PFSED-DepED	APPROVED BY :  <b>OLIVER R. HERNANDEZ</b> CHIEF, PFSED-OPS DepED	PROJECT TITLE :  <b>ONE STOREY TWO CLASSROOM 7x9m (MODIFIED)</b>	PROJECT NO: 00200511	OWNER :  <b>DEPARTMENT OF EDUCATION DepED</b>	SHEET NO:  <b>S - 1</b>
					LOCATION :	DESIGNED BY: AMA	SHEET CONTENTS : <b>FOUNDATION PLAN, ROOF FRAMING PLAN FOOTING DETAIL, COLUMN DETAIL, WF-1, RAMP DET.</b>	
						ENCODED BY: Max C.		
						CHECKED BY: LGP		
						DATE : 01 01 2005		<b>2</b>

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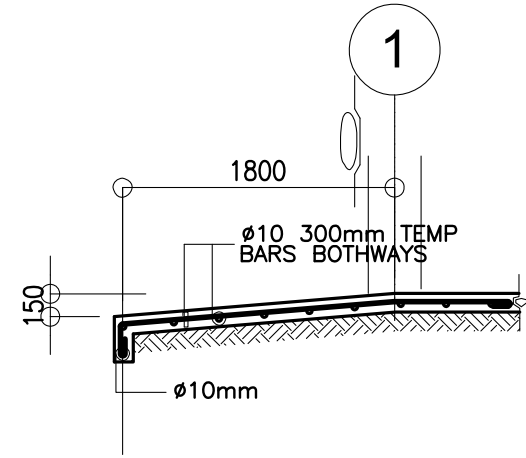


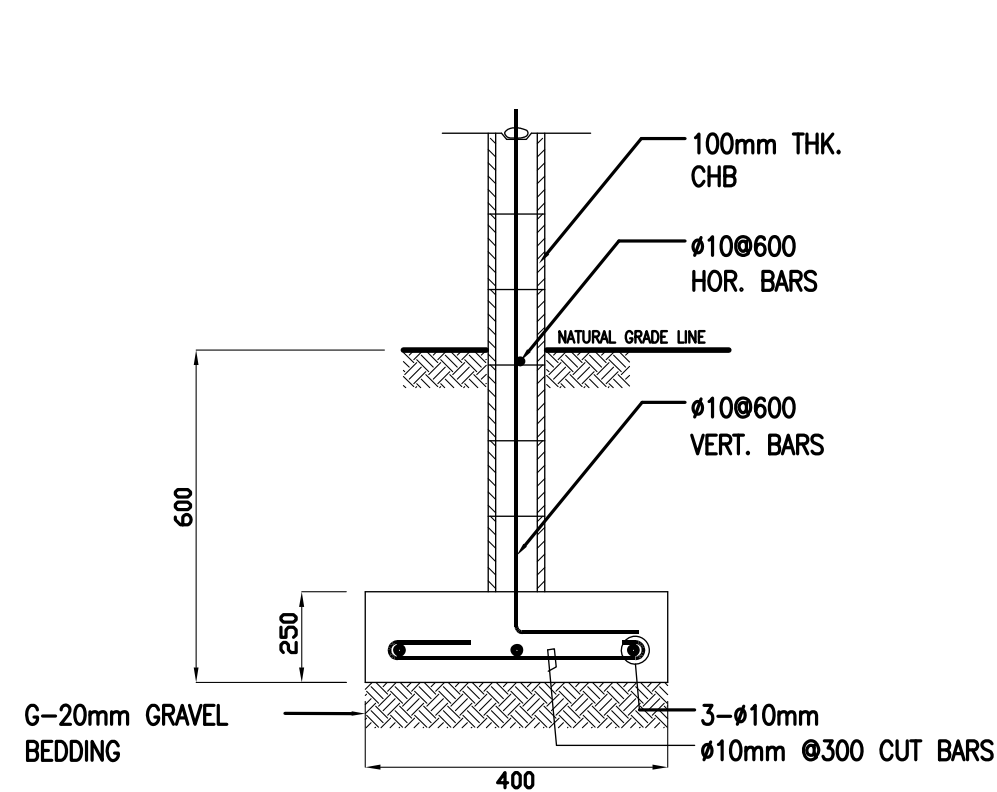


**D**  
S-1  
DETAIL OF WF-1  
SCALE : NTS.

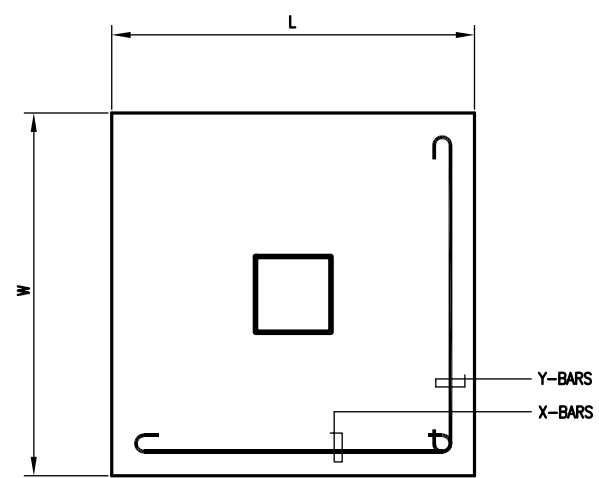


PLAN




**E**  
S-1  
DETAIL OF RAMP  
SCALE 1 : 50M

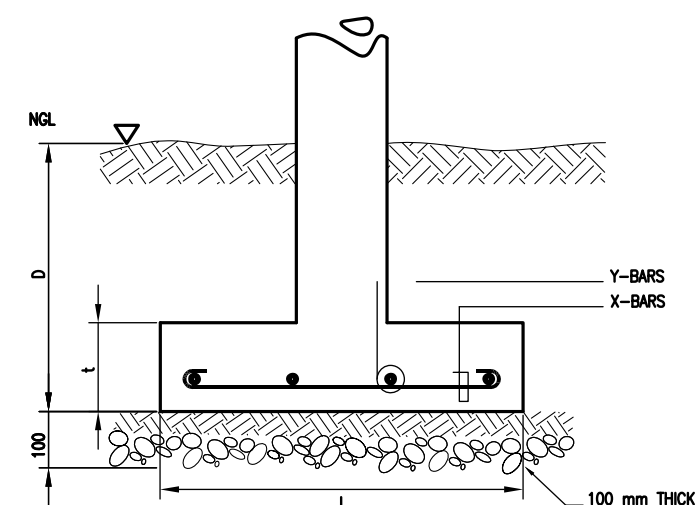


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PLAN

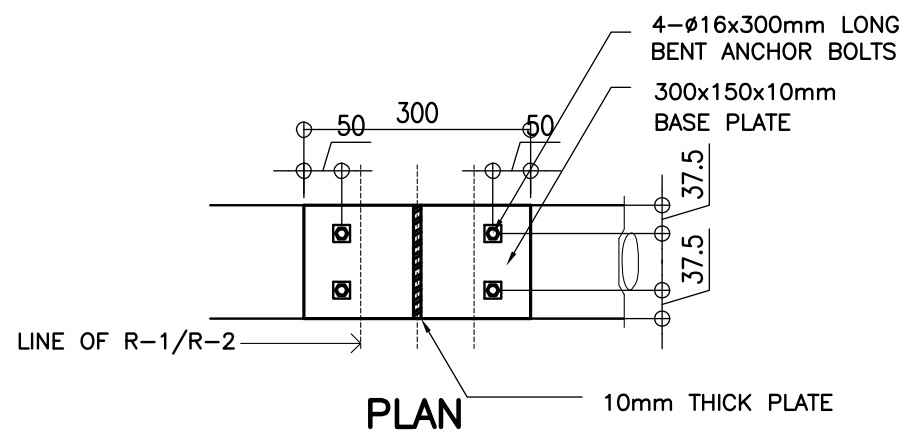


2LC-150x65x20x3  
R-1

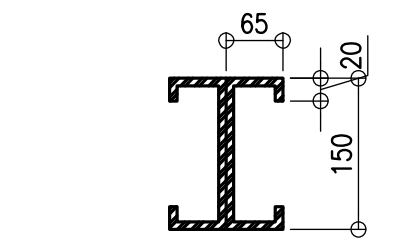


LC-150x65x20x3  
R-2

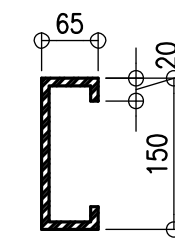**E**  
S-2  
DETAIL OF RAFTER  
SCALE NTS

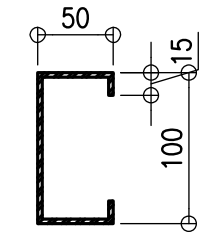


LC-100x50x15x1.5

**F**  
S-2  
DETAIL OF PURLINS  
SCALE NTS

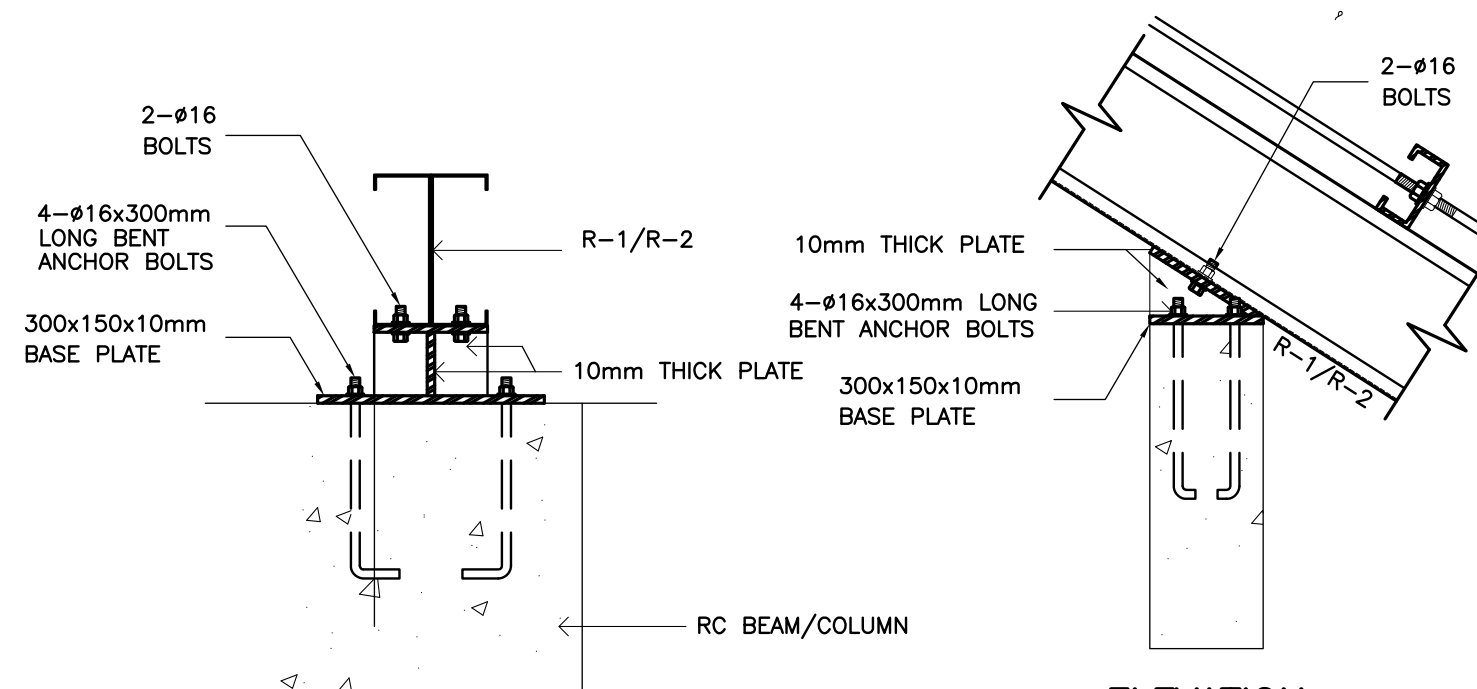


ELEVATION


ELEVATION

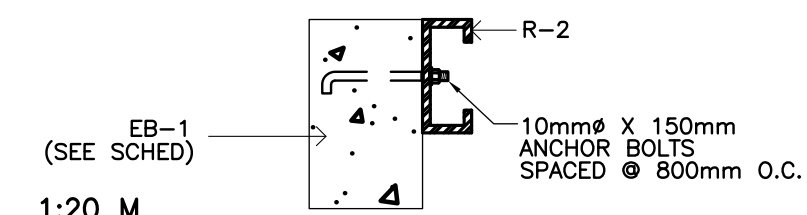

**1**  
S-2  
SECTION DETAIL  
SCALE NTS

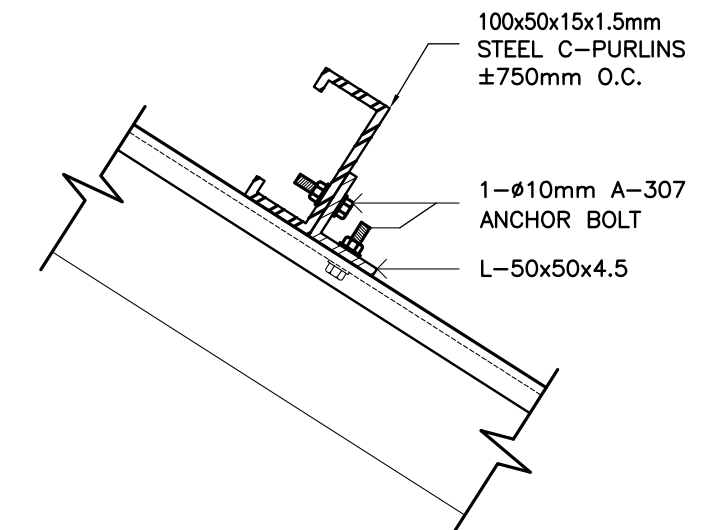


**G**  
S-2  
PURLIN CONNECTION DET  
SCALE 1 : 5 M

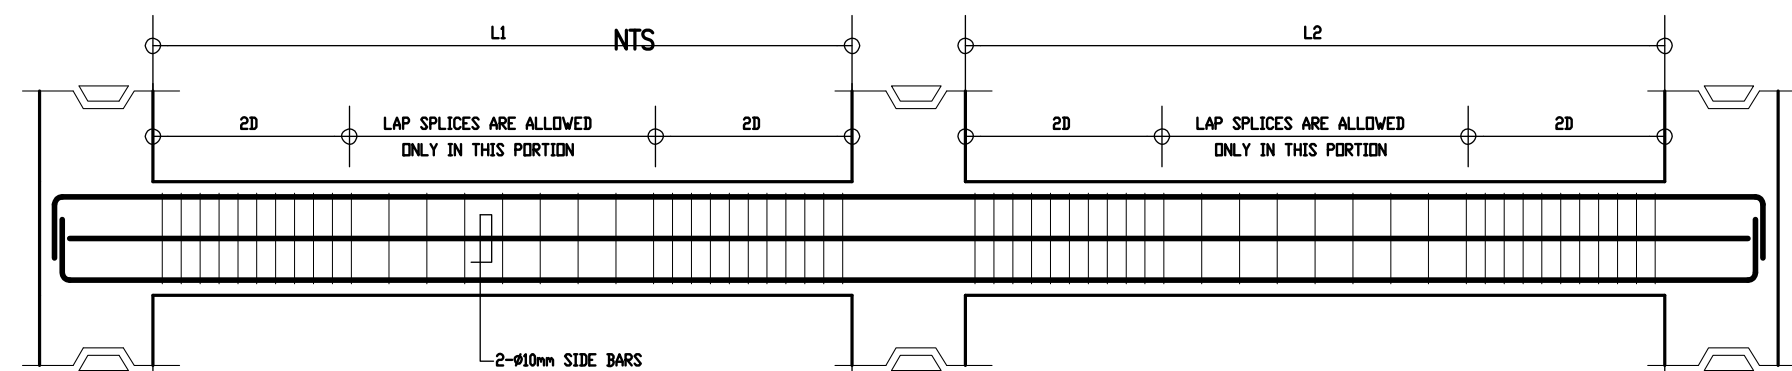


**C**  
S-2  
TYPICAL BEAM ELEVATION

B E A M S C H E D U L E											
FLOOR LEVEL	BEAM MARK	BEAM DIMENSIONS ( in / mm )		STEEL REINFORCEMENTS						STIRRUPS Ø10mm (UNLESS NOTED OTHERWISE)	
				REBAR (mm Ø)	LEFT		MID SPAN		RIGHT		
		b	h		TOP	BOTTOM	TOP	BOTTOM	TOP		BOTTOM
ROOF LEVEL	RG-1	150	400	Ø12mm	2	2	2	2	2	2	1Ø50, 8Ø100, REST@200
	RG-2	150	400	Ø12mm	2	2	2	2	2	2	1Ø50, 6Ø100, REST@200
	EB-1	150	250	Ø10mm	2	2	2	2	2	2	1Ø50, REST@200

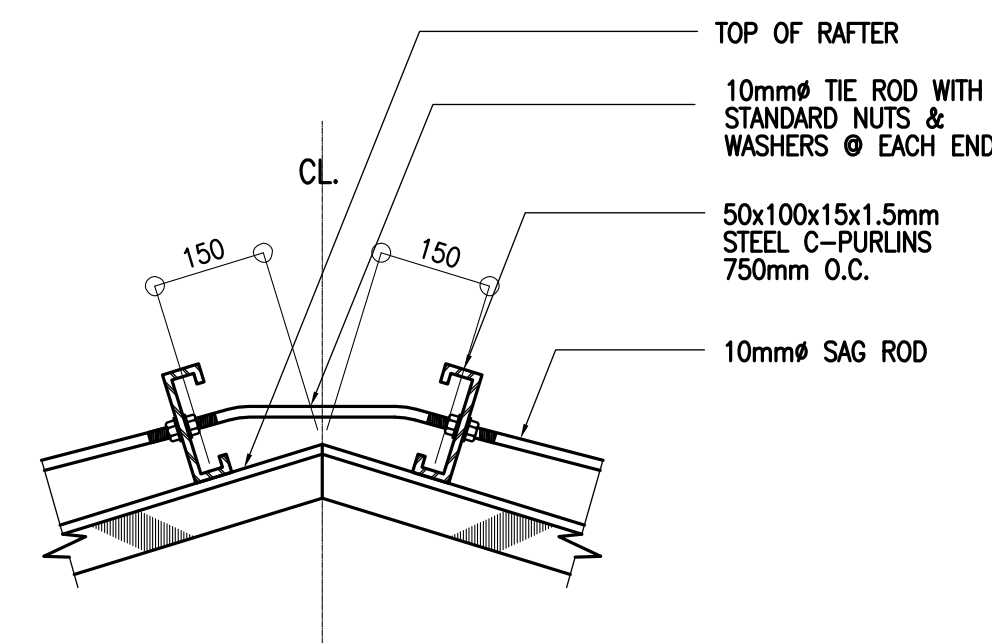

**H**  
S-2  
TIE ROD CONNECTION DET.  
SCALE 1 : 10 M

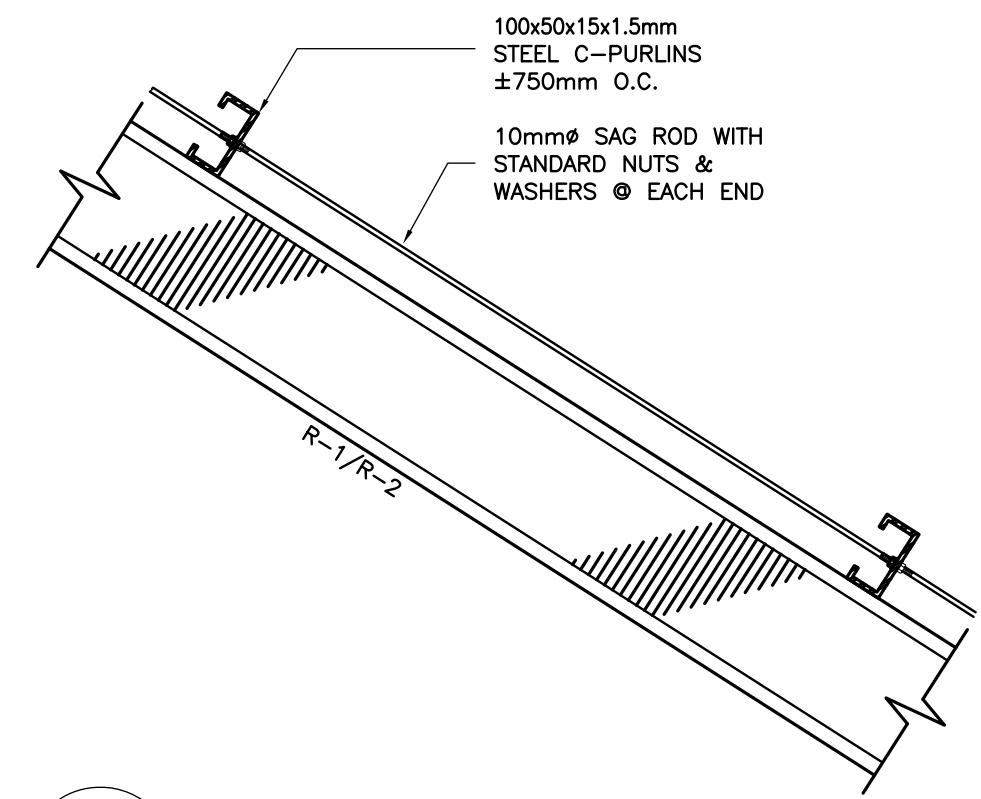

**I**  
S-2  
SAG ROD CONNECTION DET.  
SCALE 1 : 10 M

REPUBLIC OF THE PHILIPPINES <b>DepED</b> DEPARTMENT OF EDUCATION PHYSICAL FACILITIES AND SCHOOLS ENGINEERING DIVISION MERALCO AVENUE, PASIG CITY		PREPARED BY :  MAXIMINO M. CALBANG PDO - III PFSED-DepED	CHECKED BY :  ANTONIA M. ALHAMBRA CIVIL ENGINEER/MASTER PLUMBER PFSED-DepED	RECOMMENDING APPROVAL :  LUIS C. PURISIMA JR. HEAD, PLANNING AND DESIGN UNIT PFSED-DepED	APPROVED BY :  OLIVER R. HERNANDEZ CHIEF, PFSED-OPS DepED	PROJECT TITLE : ONE STOREY TWO CLASSROOM 7x9m (MODIFIED) LOCATION :	PROJECT NO: 00200511 DESIGNED BY: AMA ENCODED BY: Max C. CHECKED BY: LGP DATE: 01 01 2005	OWNER : DEPARTMENT OF EDUCATION DepED SHEET CONTENTS : ELEVATIONS, BEAM DETAIL & SCHED. TYPICAL CONNECTION DETAIL	SHEET NO: <b>S - 2</b> <b>2</b>
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GENERAL NOTES

1. ALL ELECTRICAL WORKS SHALL COMPLY IN ACCORDANCE WITH THESE PLANS AND SPECIFICATIONS. THE APPLICABLE PROVISIONS OF THE LATEST EDITION OF THE PHILIPPINE ELECTRICAL CODE (PEC). THE RULES AND REGULATION OF THE LOCAL ENFORCING AUTHORITY AND THE REQUIREMENTS OF THE LOCAL POWER COMPANY. THE ELECTRICAL WORKS SHALL BE UNDER IMMEDIATE SUPERVISION OF A DULY REGISTERED ELECTRICAL ENGINEER.
2. THE ELECTRICAL SERVICE POWER IS 1–PHASE, 2–WIRE, 230 V AC, 60 Hz.
3. WIRING METHOD SHALL BE AS FOLLOWS :

a. FEEDERS AND RISERS – INTERMEDIATE METALLIC CONDUIT

b. LIGHTING, POWER RECEPTACLE – POLYVINYL CHLORIDE CONDUIT BRANCH CKT., & AUXILIARY SCH. 40
4. ALL WIRES SHALL BE COPPER AND THERMOPLASTIC INSULATED TYPE "THW" UNLESS OTHERWISE INDICATED IN THE PLAN. THE MINIMUM SIZE OF WIRE FOR POWER AND LIGHTING CIRCUIT HOMERUN SHALL BE 3.5mm² AND INSULATED FOR 600 VOLTS. SMALLEST RACEWAY SHALL BE 15mmø TRADE/NOMINAL SIZE.
5. ALL OUTLET BOXES SHALL BE GALVANIZED GAUGE NO. 16 DEEP TYPE WITH FACTORY KNOCKOUTS.
6. ALL MATERIALS TO BE USED SHALL BE BRAND NEW AND APPROVED TYPE FOR THE PARTICULAR LOCATION AND PURPOSE OF USAGE.
7. GROUNDING SYSTEM SHALL BE PROVIDED TO ALL LIGHTING AND POWER CIRCUIT AS PER PHILIPPINE ELECTRICAL CODE REQUIREMENT.
8. MOUNTING HEIGHT OF WIRING DEVICES SHALL BE AS FOLLOWS :


a. LIGHT SWITCH – 1.20 M ABOVE FINISH FLOOR

b. CONVENIENCE OUTLET – 0.30 M ABOVE FINISH FLOOR.

c. PANELBOARD – 1.80 M ABOVE FINISH FLOOR

LEGEND

SYMBOL	DESCRIPTION
	- CEILING LIGHT OUTLET
	- 2 x 40 WATTS FLUORESCENT LAMP
	- CEILING FAN OUTLET
S/Sa	- ONE GANG DEVICE SWITCH
Sab	- TWO GANG DEVICE SWITCH
Scde	- THREE GANG DEVICE SWITCH
S3W	- THREE WAY DEVICE SWITCH
Sf	- FAN CONTROL SWITCH
	- RACEWAY CONDUIT CONCEALED IN CEILING
	- RACEWAY CONDUIT CONCEALED UNDER FLOOR
	- PANELBOARD
	- DUPLEX CONVENIENCE OUTLET, GROUNDING TYPE 10 AMPS, 250 VOLT WITH MODERN PLATE COVER
	- WEATHERPROOF TYPE DUPLEX CONVENIENCE OUTLET, GROUNDING TYPE 10 AMPS, 250 VOLT WITH MODERN PLATE COVER
	- HOMERUN DIRECT TO PANELBOARD
	- CIRCUIT BREAKER, RATING AS INDICATED
	- ELECTRIC SERVICE METER
	- SERVICE ENTRANCE

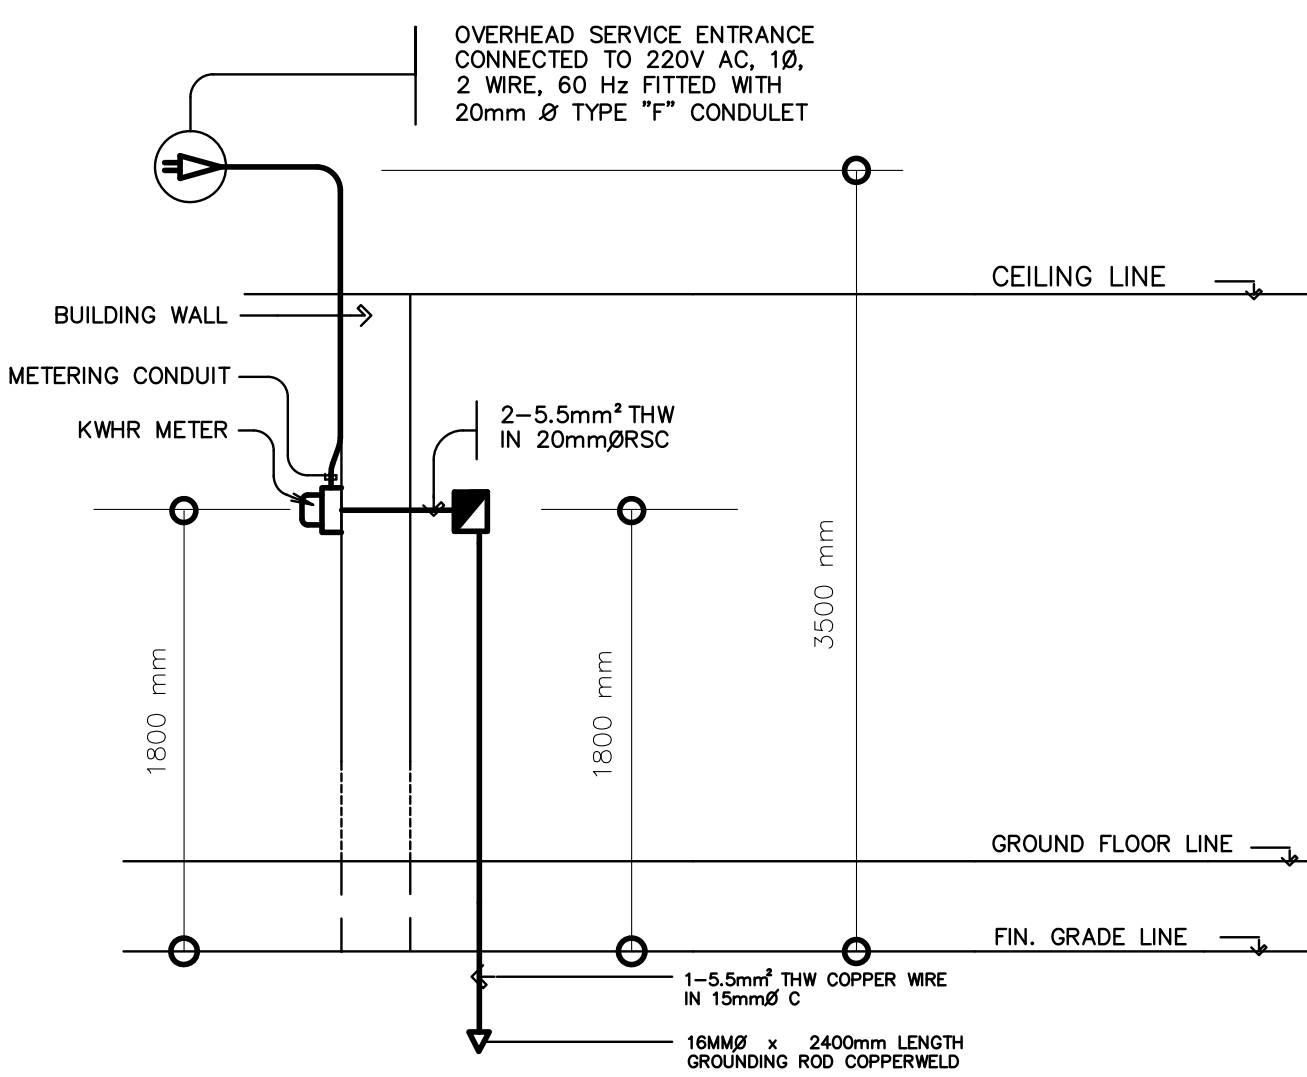


ELECTRICAL RISER DIAGRAM

NOT TO SCALE

LOAD SCHEDULE

PANELBOARD: LP								MAIN : 40AT, 100AF, 2P, 240V			
CKT. NO.	DESCRIPTION	VA LOAD	CIRCUIT BREAKER				WIRE & CONDUIT SIZE				
			VOLT	POLE	A T	A F					
1	CONVENIENCE OUTLET	720	230	2	20	50	3–3.5mm² THW IN 15mm ØC				
2	LIGHTS & FAN	1200	230	2	20	50	3–3.5mm² THW IN 15mm ØC				
3	SPARE	1500	230	2	20	50					
	TOTAL	3420									
IL = $\frac{3420}{230\text{ V}}$ = 15 A								FEEDER: 2–5.5mm² THW IN 20mmØ RSC			
								PROTECTION: 40 AT, 50 AF, 2P, 240 V			

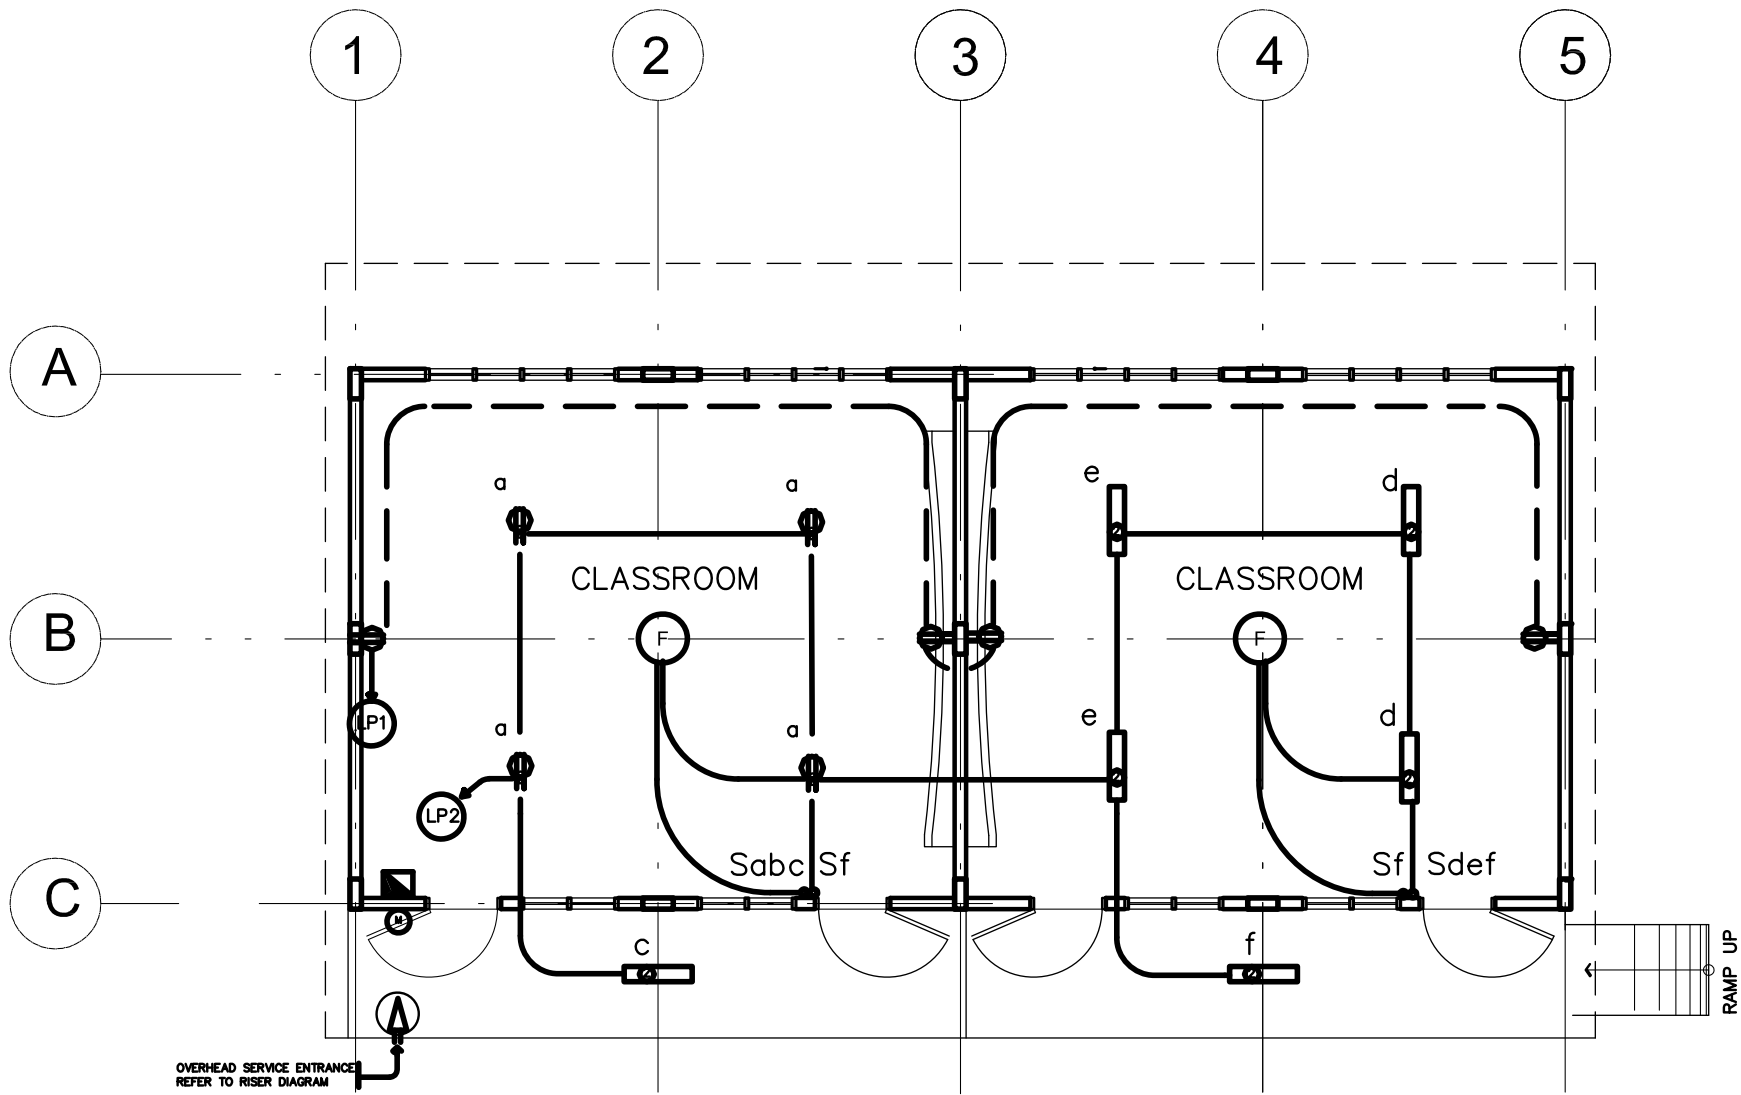

ELECTRICAL LAYOUT

SCALE 1:100 M

<div>REPUBLIC OF THE PHILIPPINES</div> <div>DepED</div> <div>DEPARTMENT OF EDUCATION</div> <div>PHYSICAL FACILITIES AND SCHOOLS ENGINEERING DIVISION</div> <div>MERALCO AVENUE, PASIG CITY</div>	PREPARED BY :	CHECKED BY :	RECOMMENDING APPROVAL :	APPROVED BY :	PROJECT TITLE :	PROJECT NO: 00200511 PROJECT NOWBRR005	SHEET NO:
					ONE STOREY TWO CLASSROOM 7x9m (MODIFIED)	DESIGNED BY: VDS	DEPARTMENT OF EDUCATION DepED
	MAXIMINO M. CALBANG PDO - III PFSED-DepED	VENERANDO D. SAHAGUN ENGINEER III PFSED-DepED	LUIS O. PURISIMA JR. HEAD, PLANNING AND DESIGN UNIT PFSED-DepED	OLIVER R. HERNANDEZ CHIEF, PFSED-OPS DepED	LOCATION :	ENCODED BY: Max C.	
						CHECKED BY: LGP	
						DATE : 01 01 2005	SHEET CONTENTS : GENERAL NOTES ELECTRICAL LAYOUT
							CALCULATIONS LEGEND RISER DIAGRAM
							E - 1 1

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