
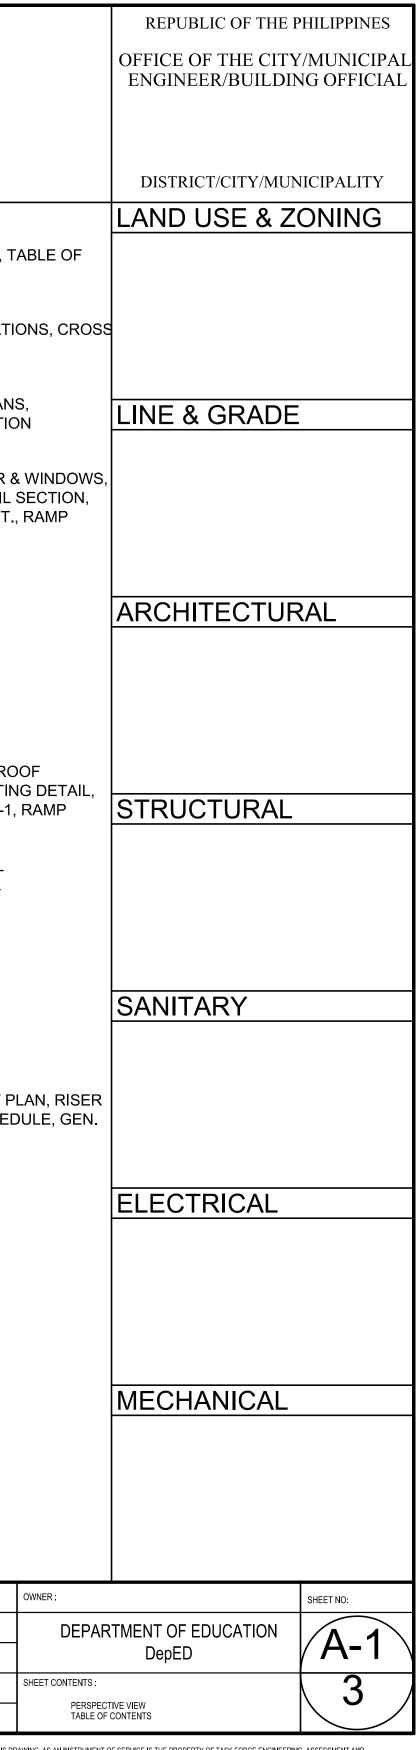



				A-2 FLOOR SECTIC A-3 CEILING LONGIT A-4 SCHED BAY SE	ECTIVE VIEW, T INTS PLAN, ELEVATI N G & ROOF PLAN UDINAL SECTIO ULE OF DOOR & ICTION, DETAIL R BLOCK VENT.	00 18, 01 8, 1 8, 1
PECTIVE VIEW       NTS				FRAMIN COLUMI DETAIL S-2 ELEVAT	ATION PLAN, RC IG PLAN FOOTIN N DETAIL, WF-1, IONS TYPICAL CTION DETAIL	10
				ELECTRICAL E-1 ELECTR DIAGRA NOTES	ICAL LAYOUT P M, LOAD SCHEE	
				<u>SANITARY</u>		
COMMENDING APPROVAL :	APPROVED FOR ACCREDITATION :	CONCURRED :	PROJECT TITLE :		PROJECT NO: 01-002	Ţ
SEFIAT: SANTIAGO OIC, DIRECTOR III BUREAU OF DESIGN, DPWH	GILBERTO S. REVES	RAMON C. BACANI UNDERSECRETARY DEPATMENT OF EDUCATION (DepED)	ON	E STOREY CLASSROOM STANDARD)	DESIGNED BY: AZB ENCODED BY: Max C CHECKED BY: DATE : 01 03	
		l V			NOTE: 01 03 NOTE: THIS DF MONITO ALL DR	
					MONITO ALL DR/	JRIN AWI

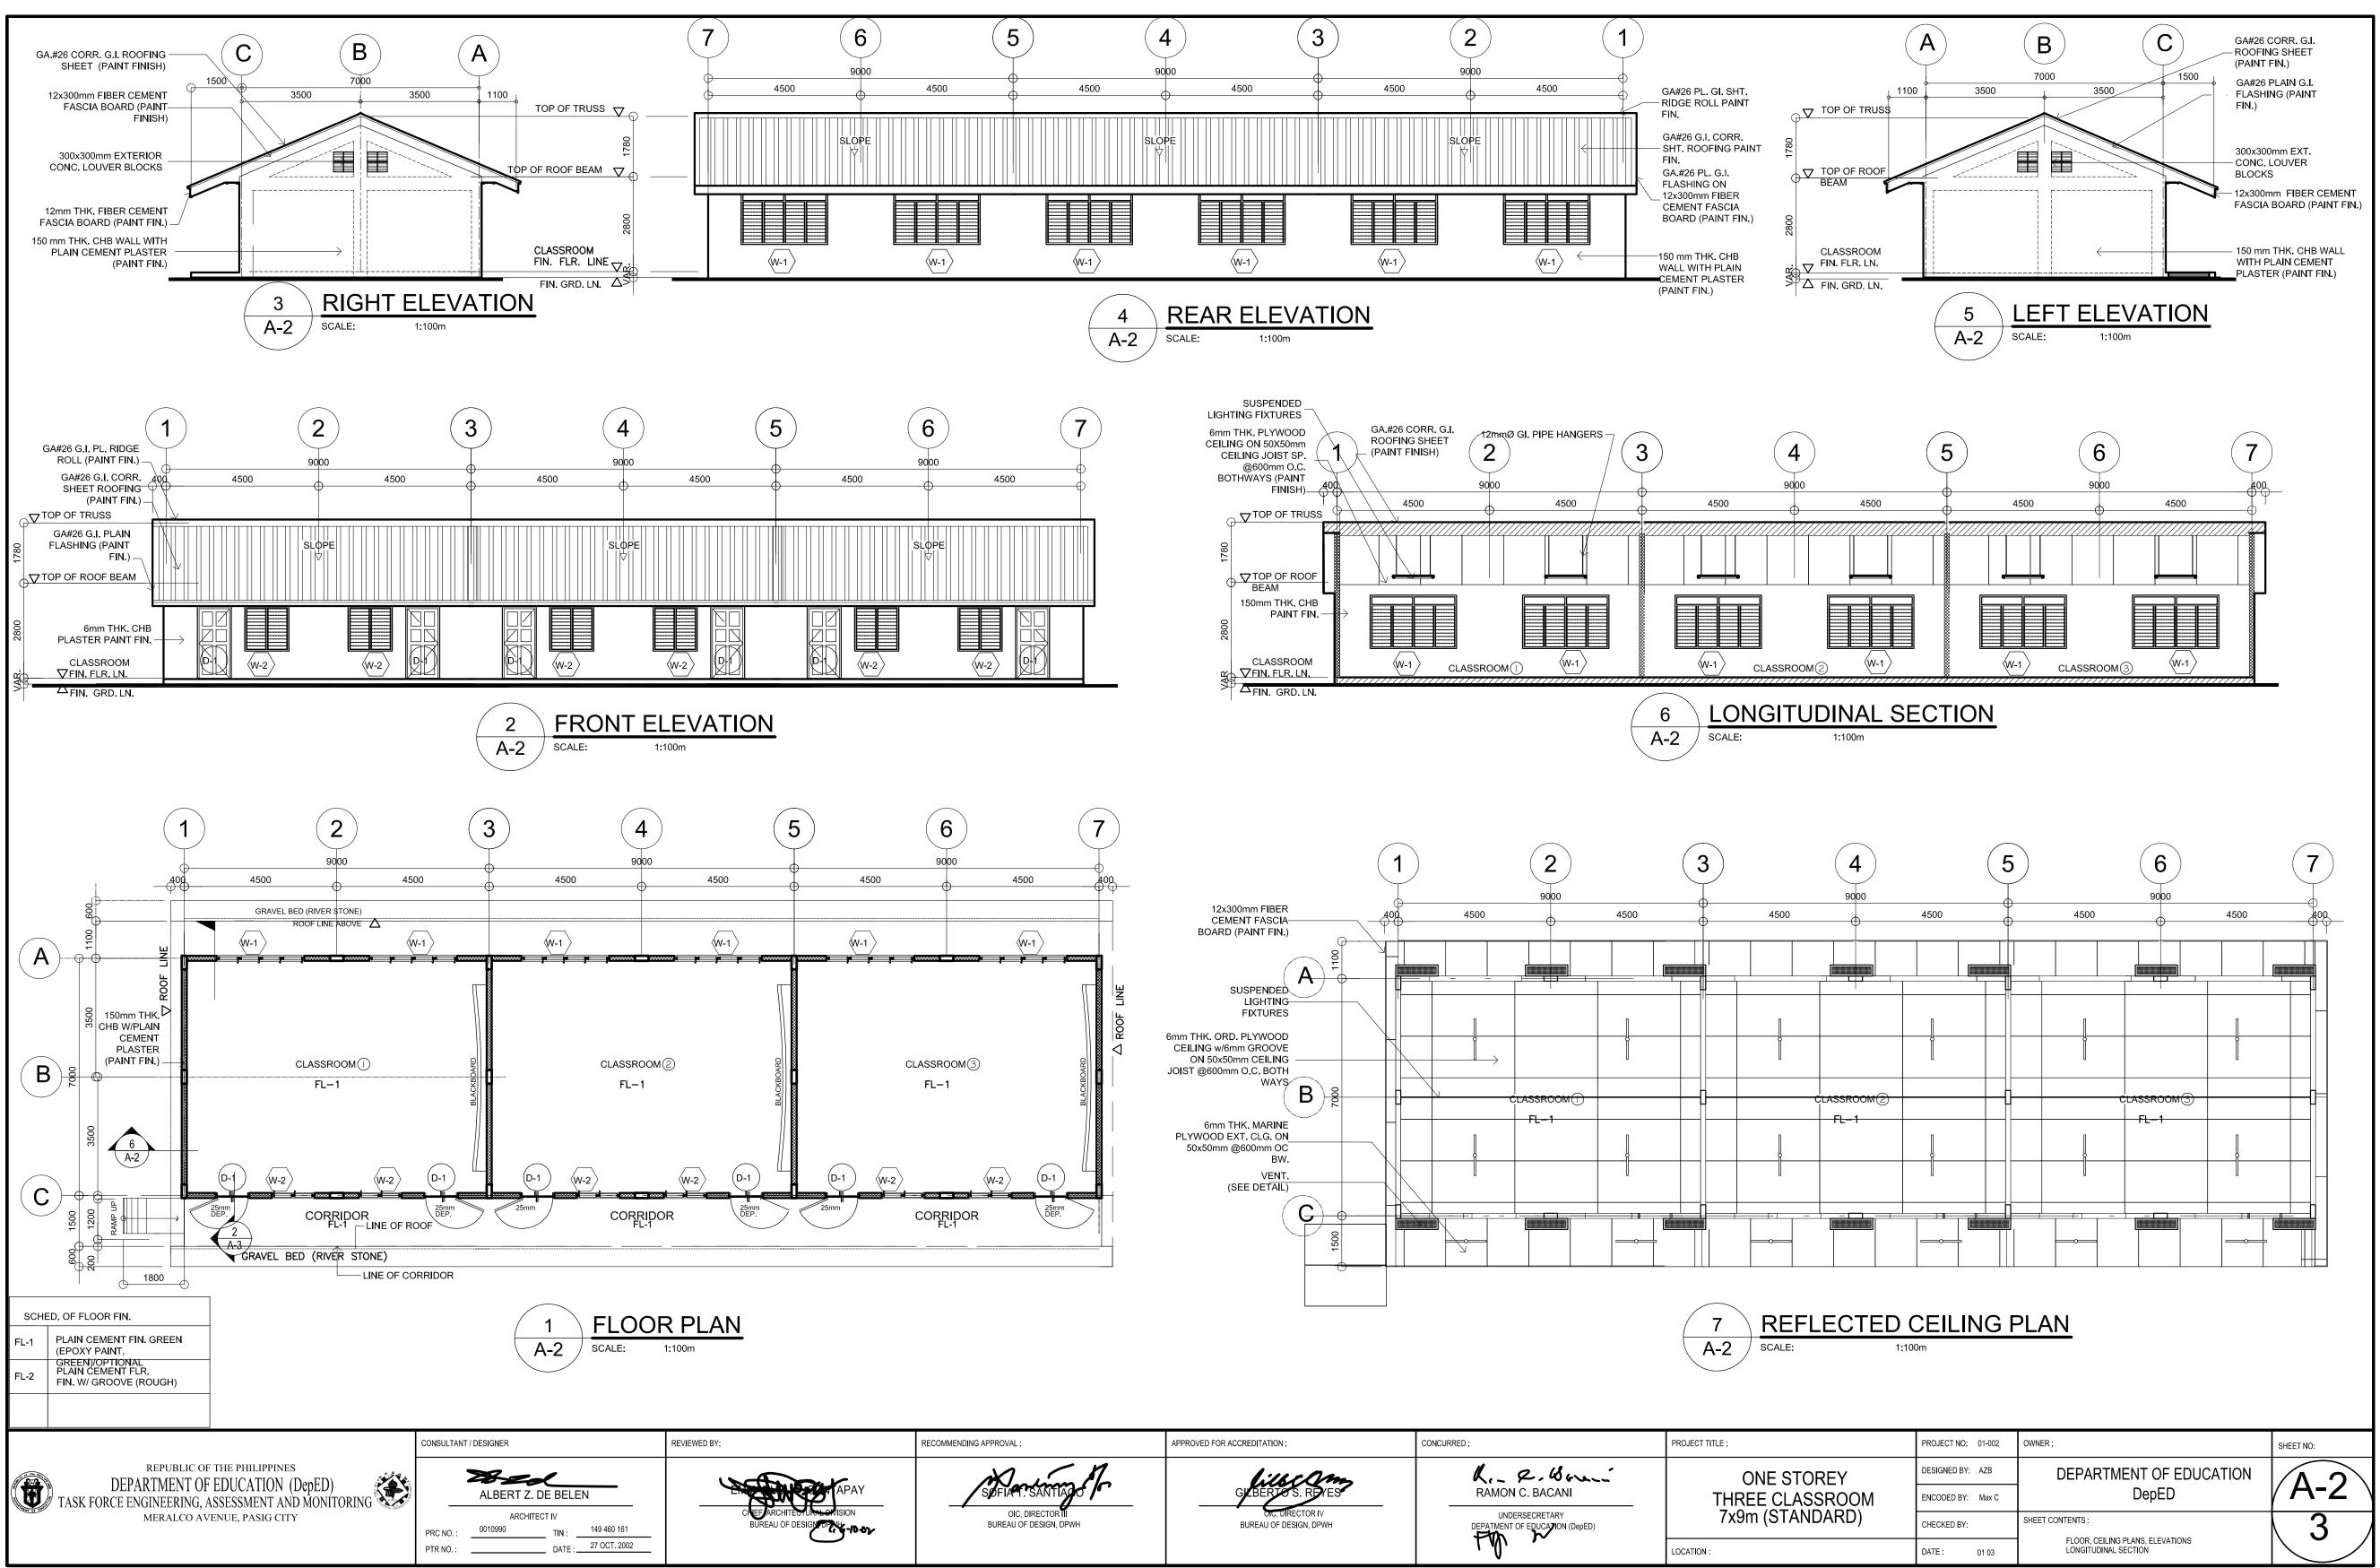


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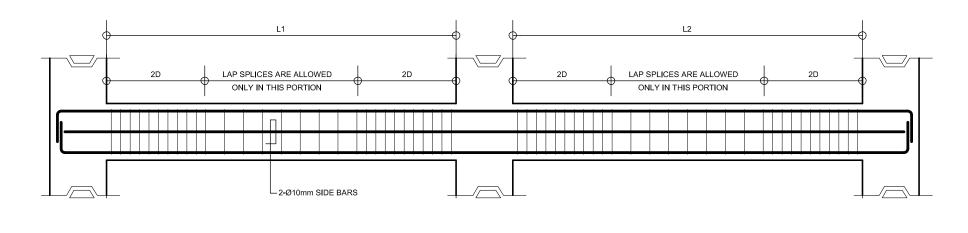
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OMMENDING APPROVAL :	APPROVED FOR ACCREDITATION :	CONCURRED :	PROJECT TITLE :	PROJECT NO: 01-002	٥v
SIDFIATT. SANTIADO OIC, DIRECTOR III BUREAU OF DESIGN, DPWH	Lilscam	K. R. Brui	THREE STOREY	DESIGNED BY: AZB	
	GLBERTO S. REVES	RAMON C. BACANI	TWO CLASSROOM	ENCODED BY: Max C	
			7x9m (STANDARD)	CHECKED BY:	S⊦
		Fly 2	LOCATION :	DATE : 01 03	


OWNER :	SHEET NO:
DEPARTMENT OF EDUCATION DepED	S-1
SHEET CONTENTS : FOUNDATION PLAN ROOF FRAMING PLAN	3

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BEAM SCHEDULE											
ELOOR BEAM DIMENSIONS STEEL REINFORCEMENTS											
FLOOR LEVEL	BEAM MARK	( in / mm		REBAR	LEFT		MID SPAN		RIGHT		
		b	h	(mm Ø)	TOP	воттом	TOP	воттом	TOP	воттом	
	RG-1	150	400	Ø12mm	2	2	2	2	2	2	
LEVEL	RG-2	150	400	Ø12mm	2	2	2	2	2	2	
ROOF											
Ř	EB-1	150	250	Ø10mm	2	2	2	2	2	2	

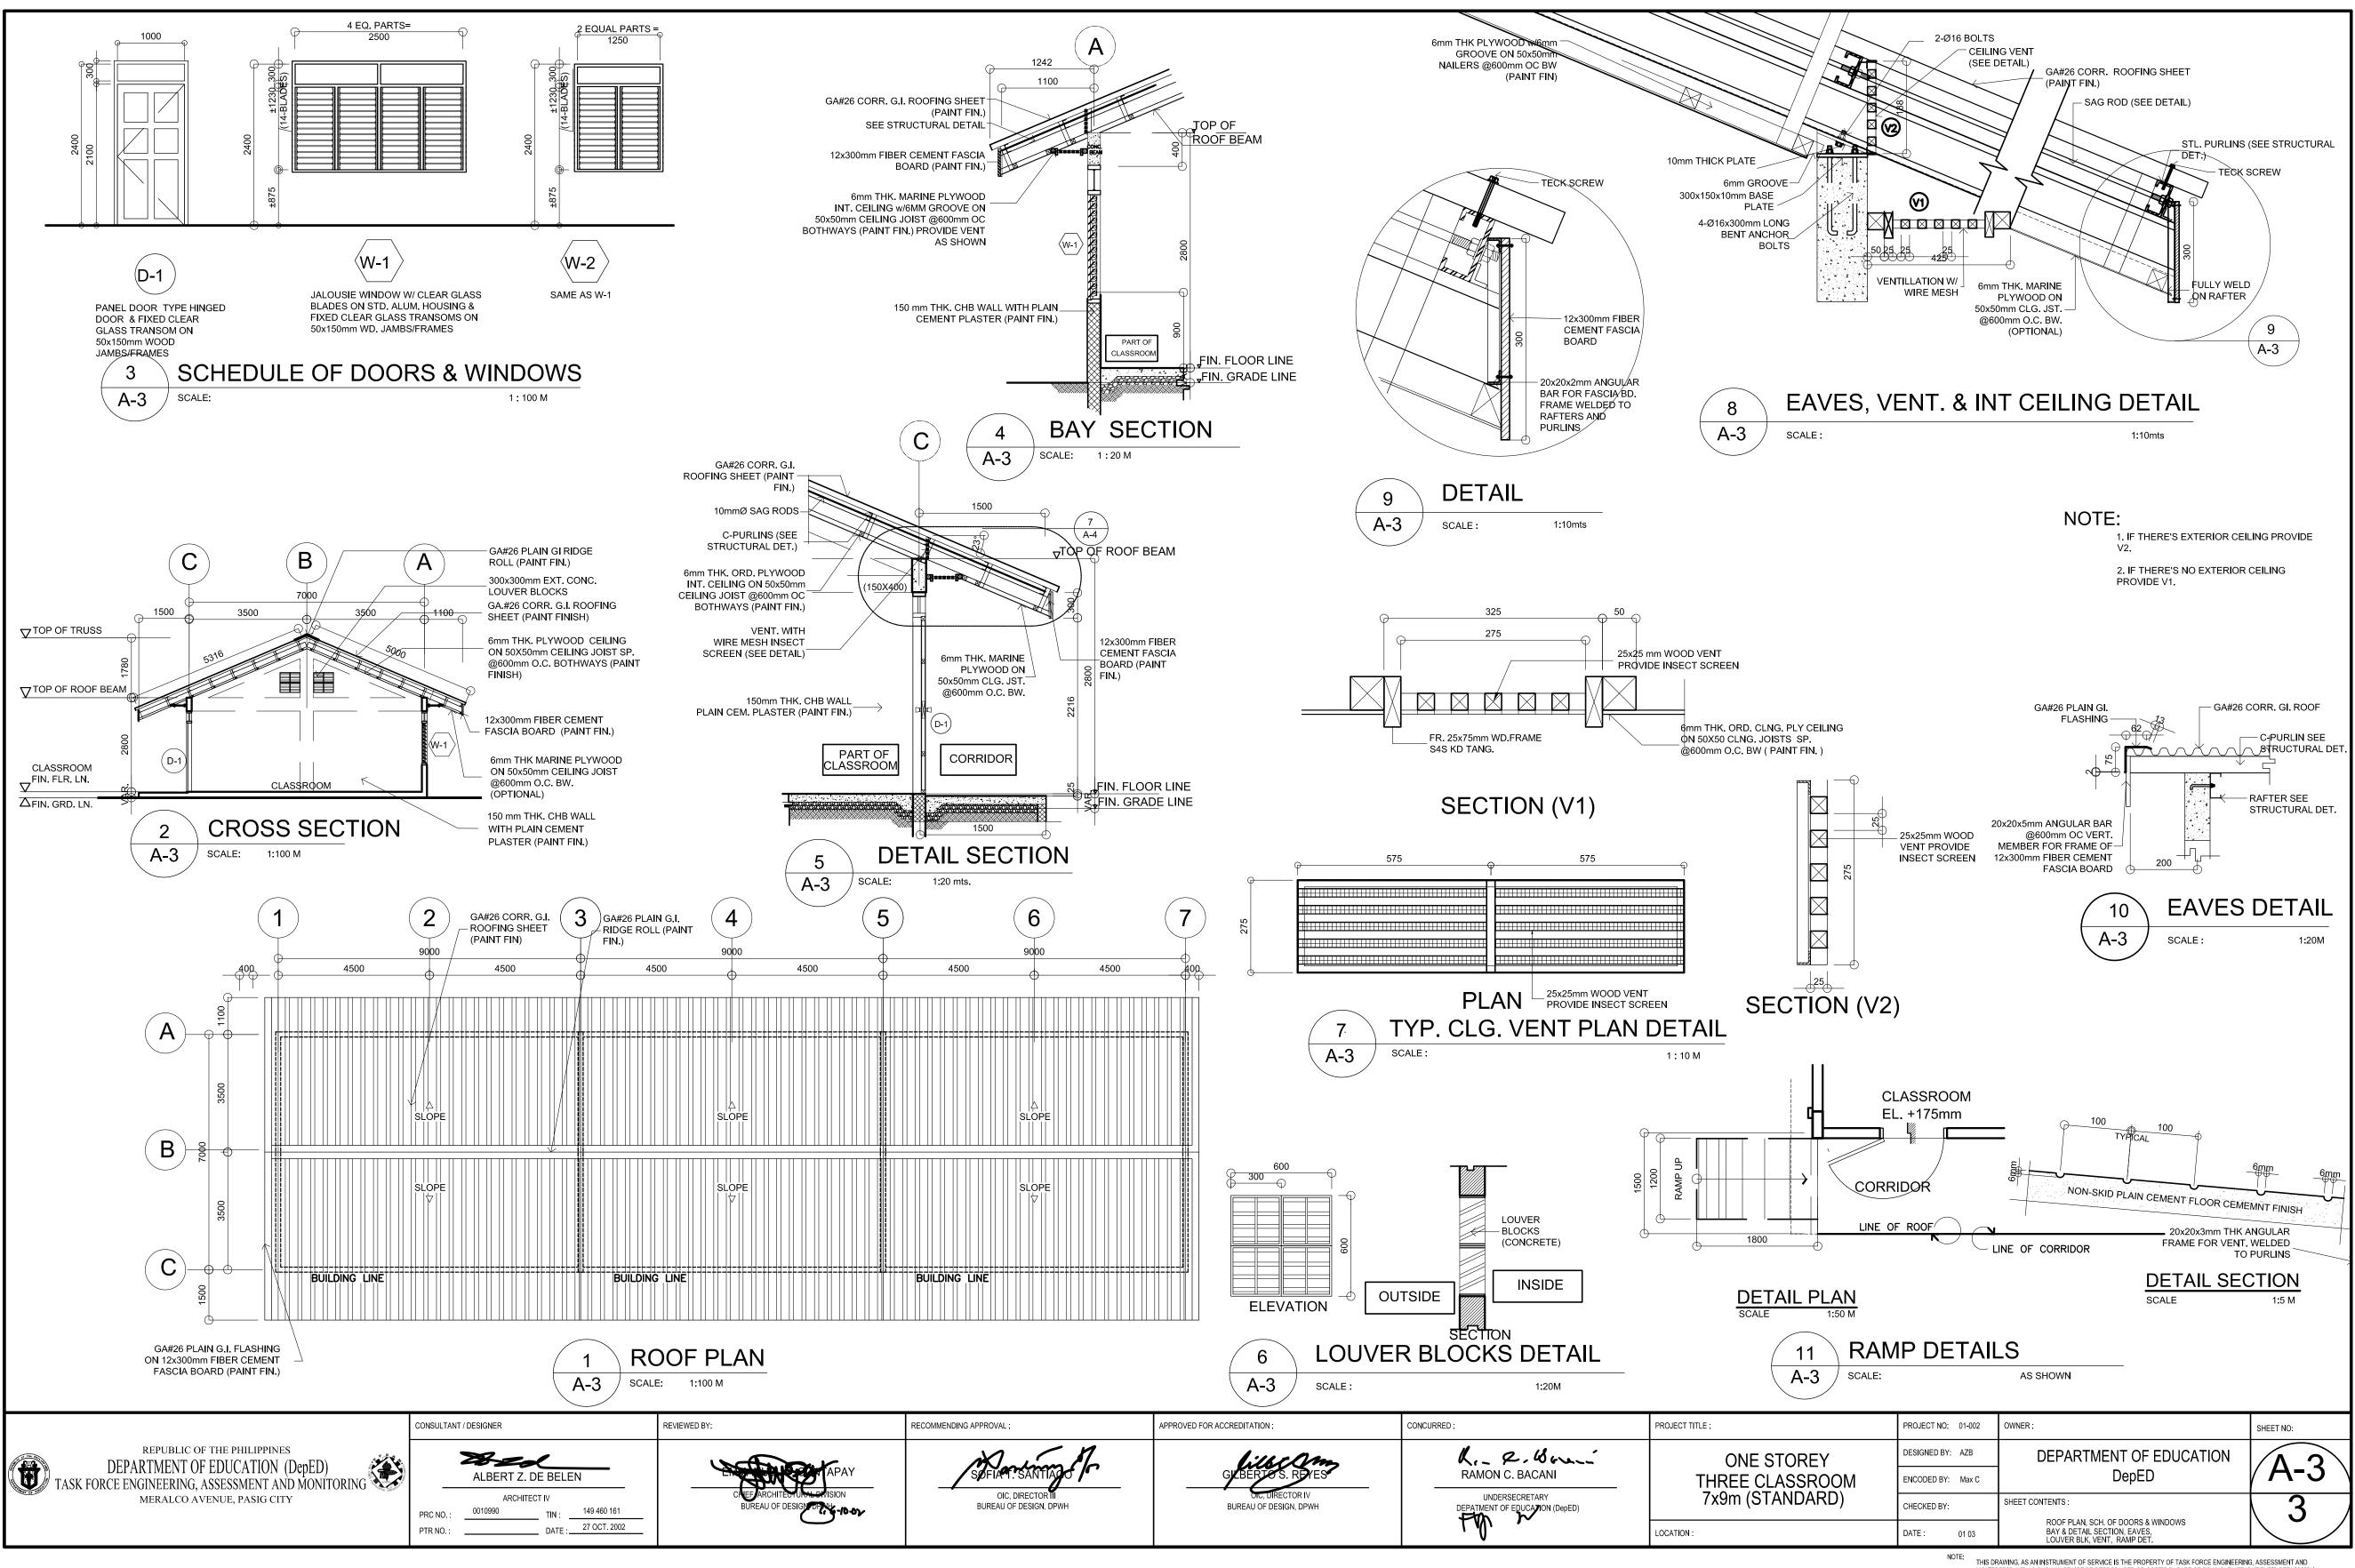

**DIC, DIRECTOR IV** 

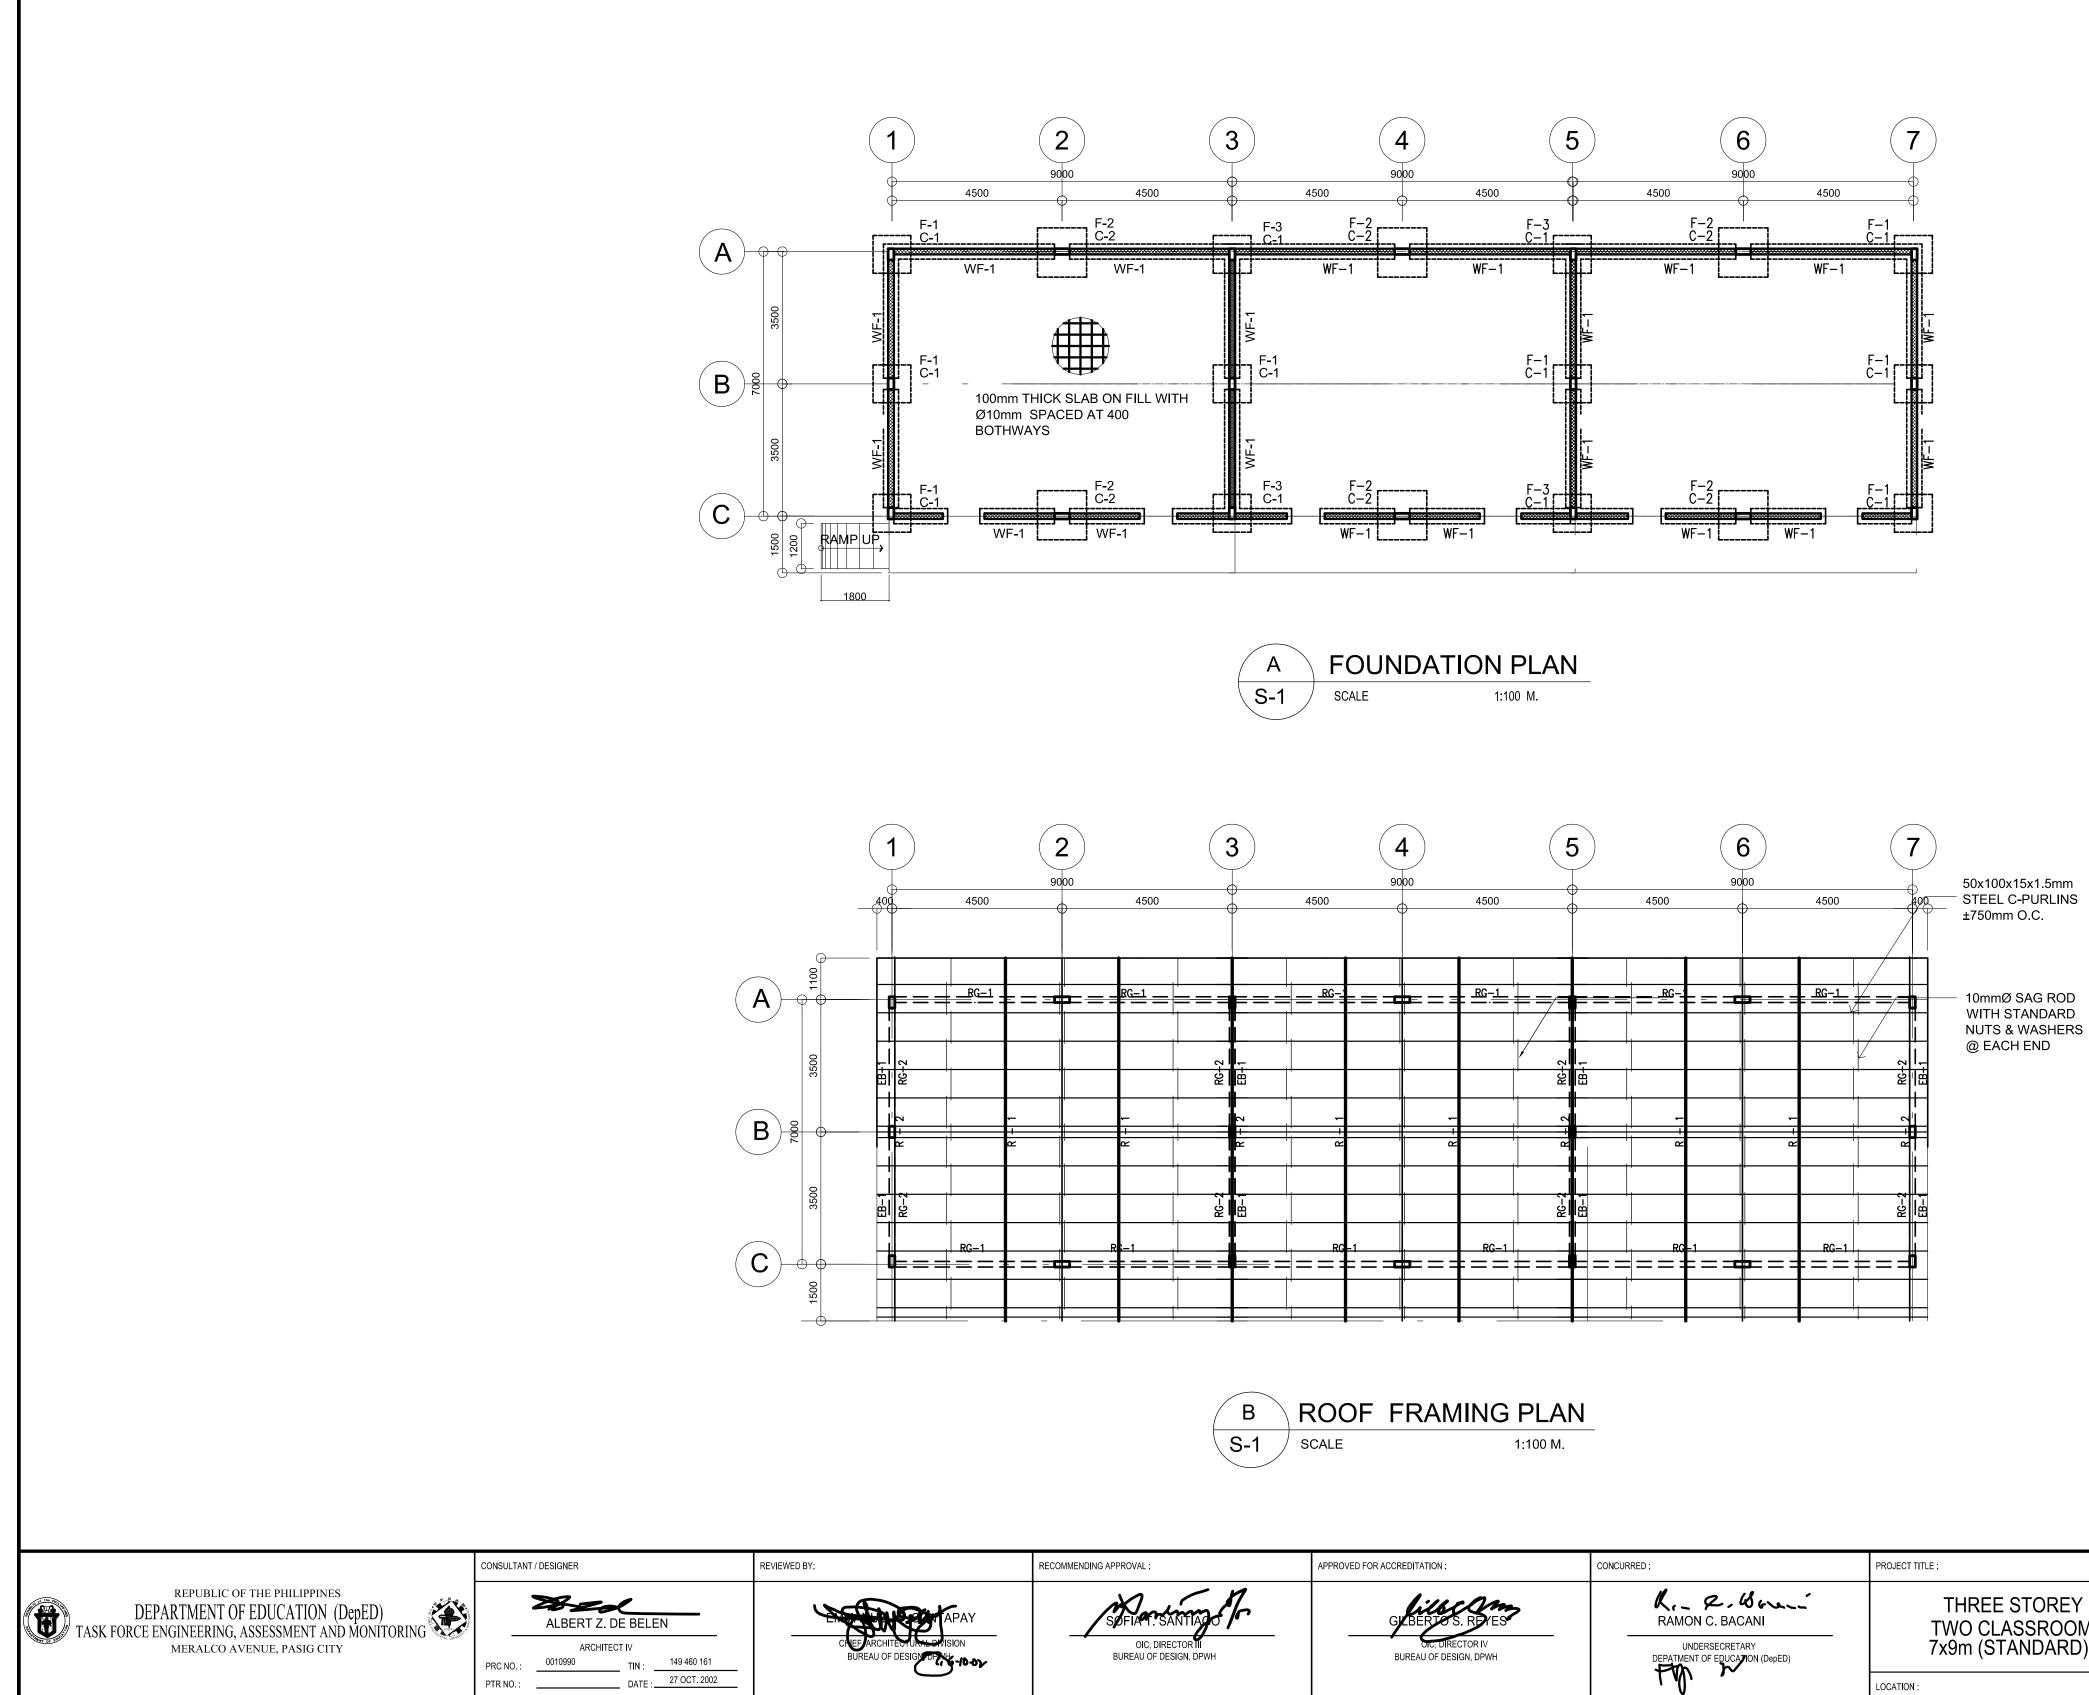BUREAU OF DESIGN, DPWH

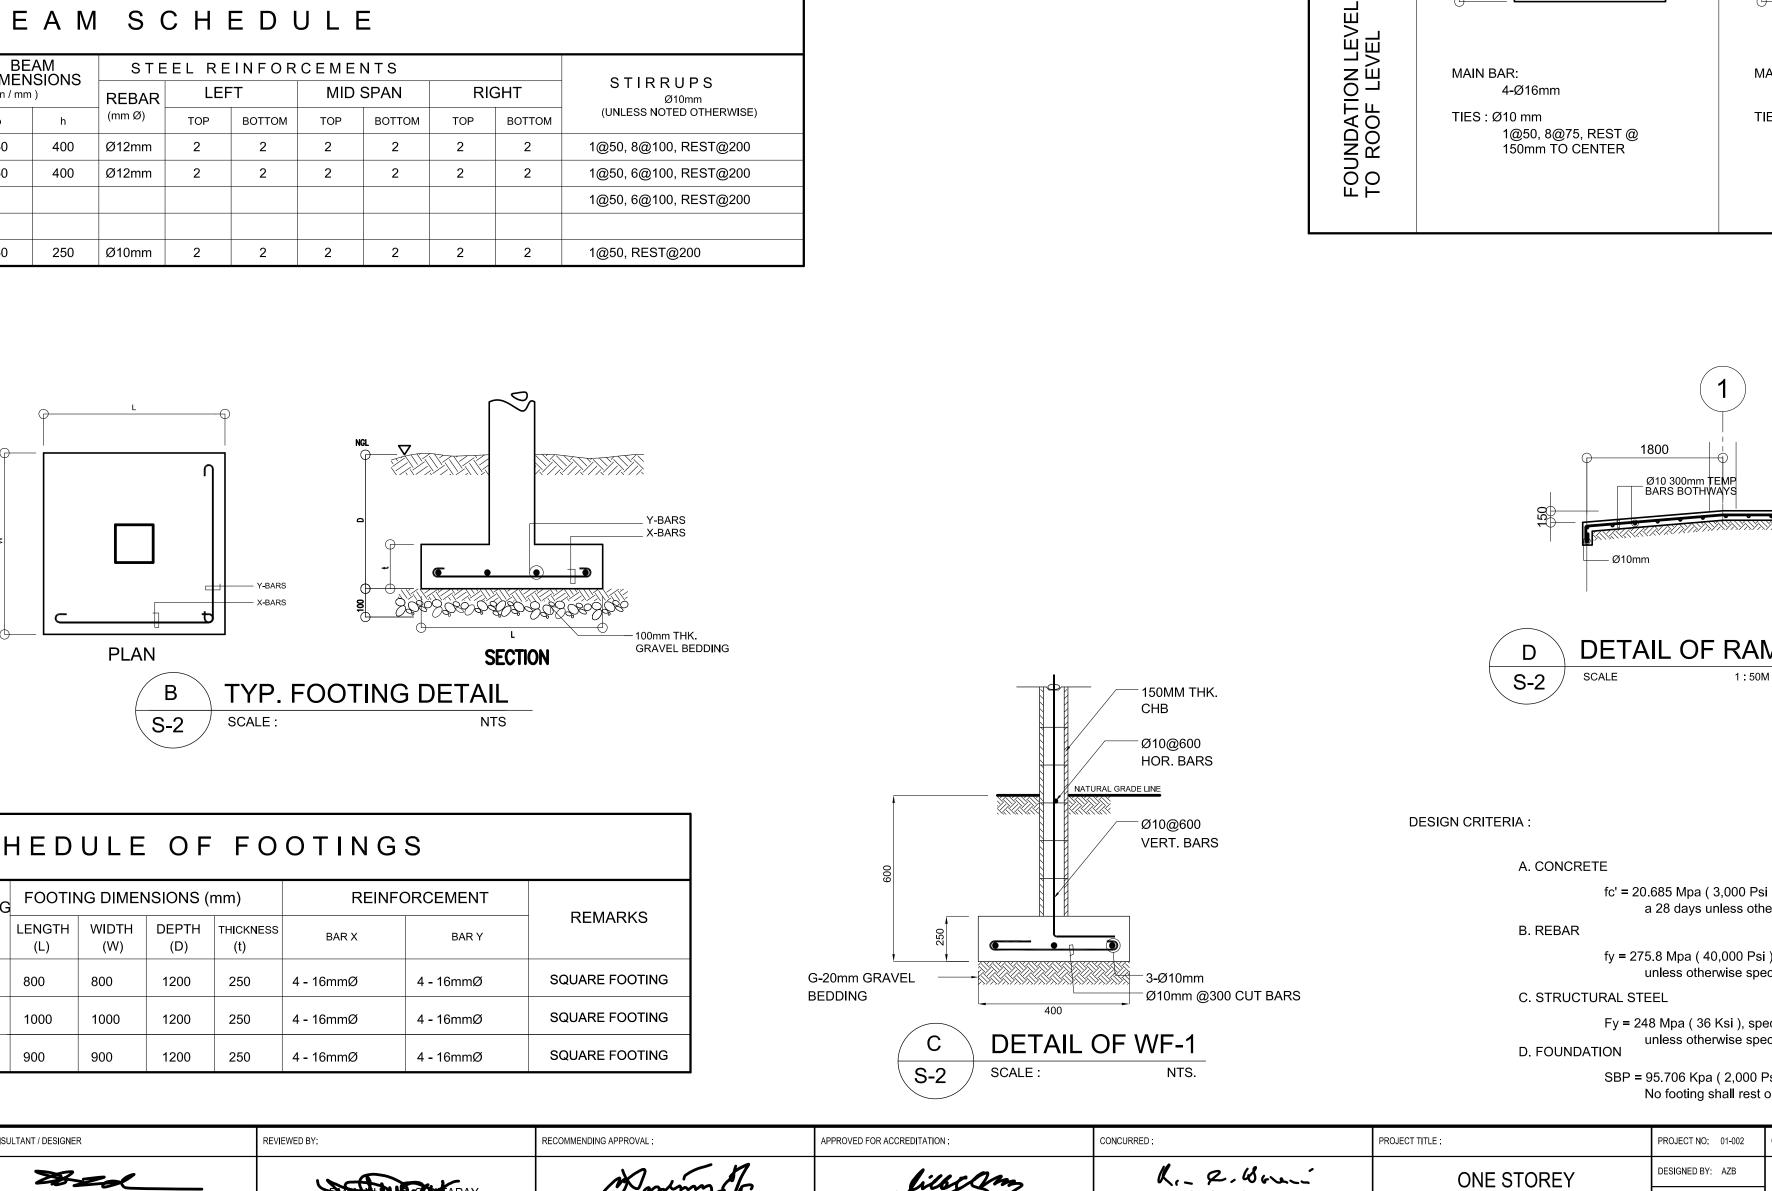LEVEL


RAMON C. BACANI


UNDERSECRETARY DEPATMENT OF EDUCATION (DepED)

LOCATION :

## SCHEDULE OF FOOTINGS

	FOOTING MARK	FOOTIN		NSIONS (r	mm)	REINFO	-	
		LENGTH (L)	WIDTH (W)	DEPTH (D)	THICKNESS (t)	BAR X	BAR Y	
	F-1	800	800	1200	250	4 - 16mmØ	4 - 16mmØ	SQL
	F-2	1000	1000	1200	250	4 - 16mmØ	4 - 16mmØ	SQL
	F-3	900	900	1200	250	4 - 16mmØ	4 - 16mmØ	SQL

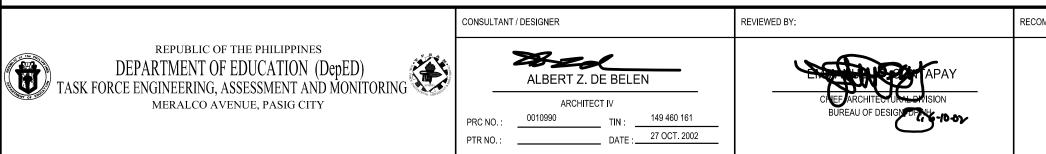

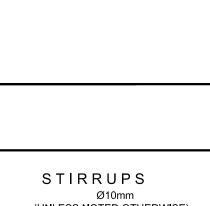


OIC, DIRECTOR III

BUREAU OF DESIGN, DPWH

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COLUMN SC	HEDUL	.E		
C-1		C-2		
MAIN BAR: 4-Ø16mm TIES : Ø10 mm 1@50, 8@75, REST @ 150mm TO CENTER		AIN BAR: 6-Ø16mm IES : Ø10 mm 1@50, 8@75, REST @ 150mm TO CENTER		
Ø10mm	1 300 JI JI JI JI JI JI JI JI JI JI			
A. CONCRETE fc' = 20. a B. REBAR fy = 275 c C. STRUCTURAL STE Fy = 24i D. FOUNDATION SBP = 9	28 days unless oth 8 Mpa ( 40,000 Psi nless otherwise spe EL 8 Mpa ( 36 Ksi ), sp nless otherwise spe	), minimum yield strength of reinforcing bars ecified. ecified minimum yield strength ecified. Psf ), was used in the design for all footings.		
TITLE :	PROJECT NO: 01-002	OWNER :	SHEET NO:	
ONE STOREY	DESIGNED BY: AZB	DEPARTMENT OF EDUCATION		$\searrow$
THREE CLASSROOM	ENCODED BY: Max C	DepED	/ S-2	
7x9m (STANDARD)	CHECKED BY:	SHEET CONTENTS : TYPICAL BEAM DETAIL, BEAM SCHEDULE, FOOTING DETAIL, COLUMN DETAIL, WF-1,	3	
N:	DATE : 01 03	RAMP DET.		/

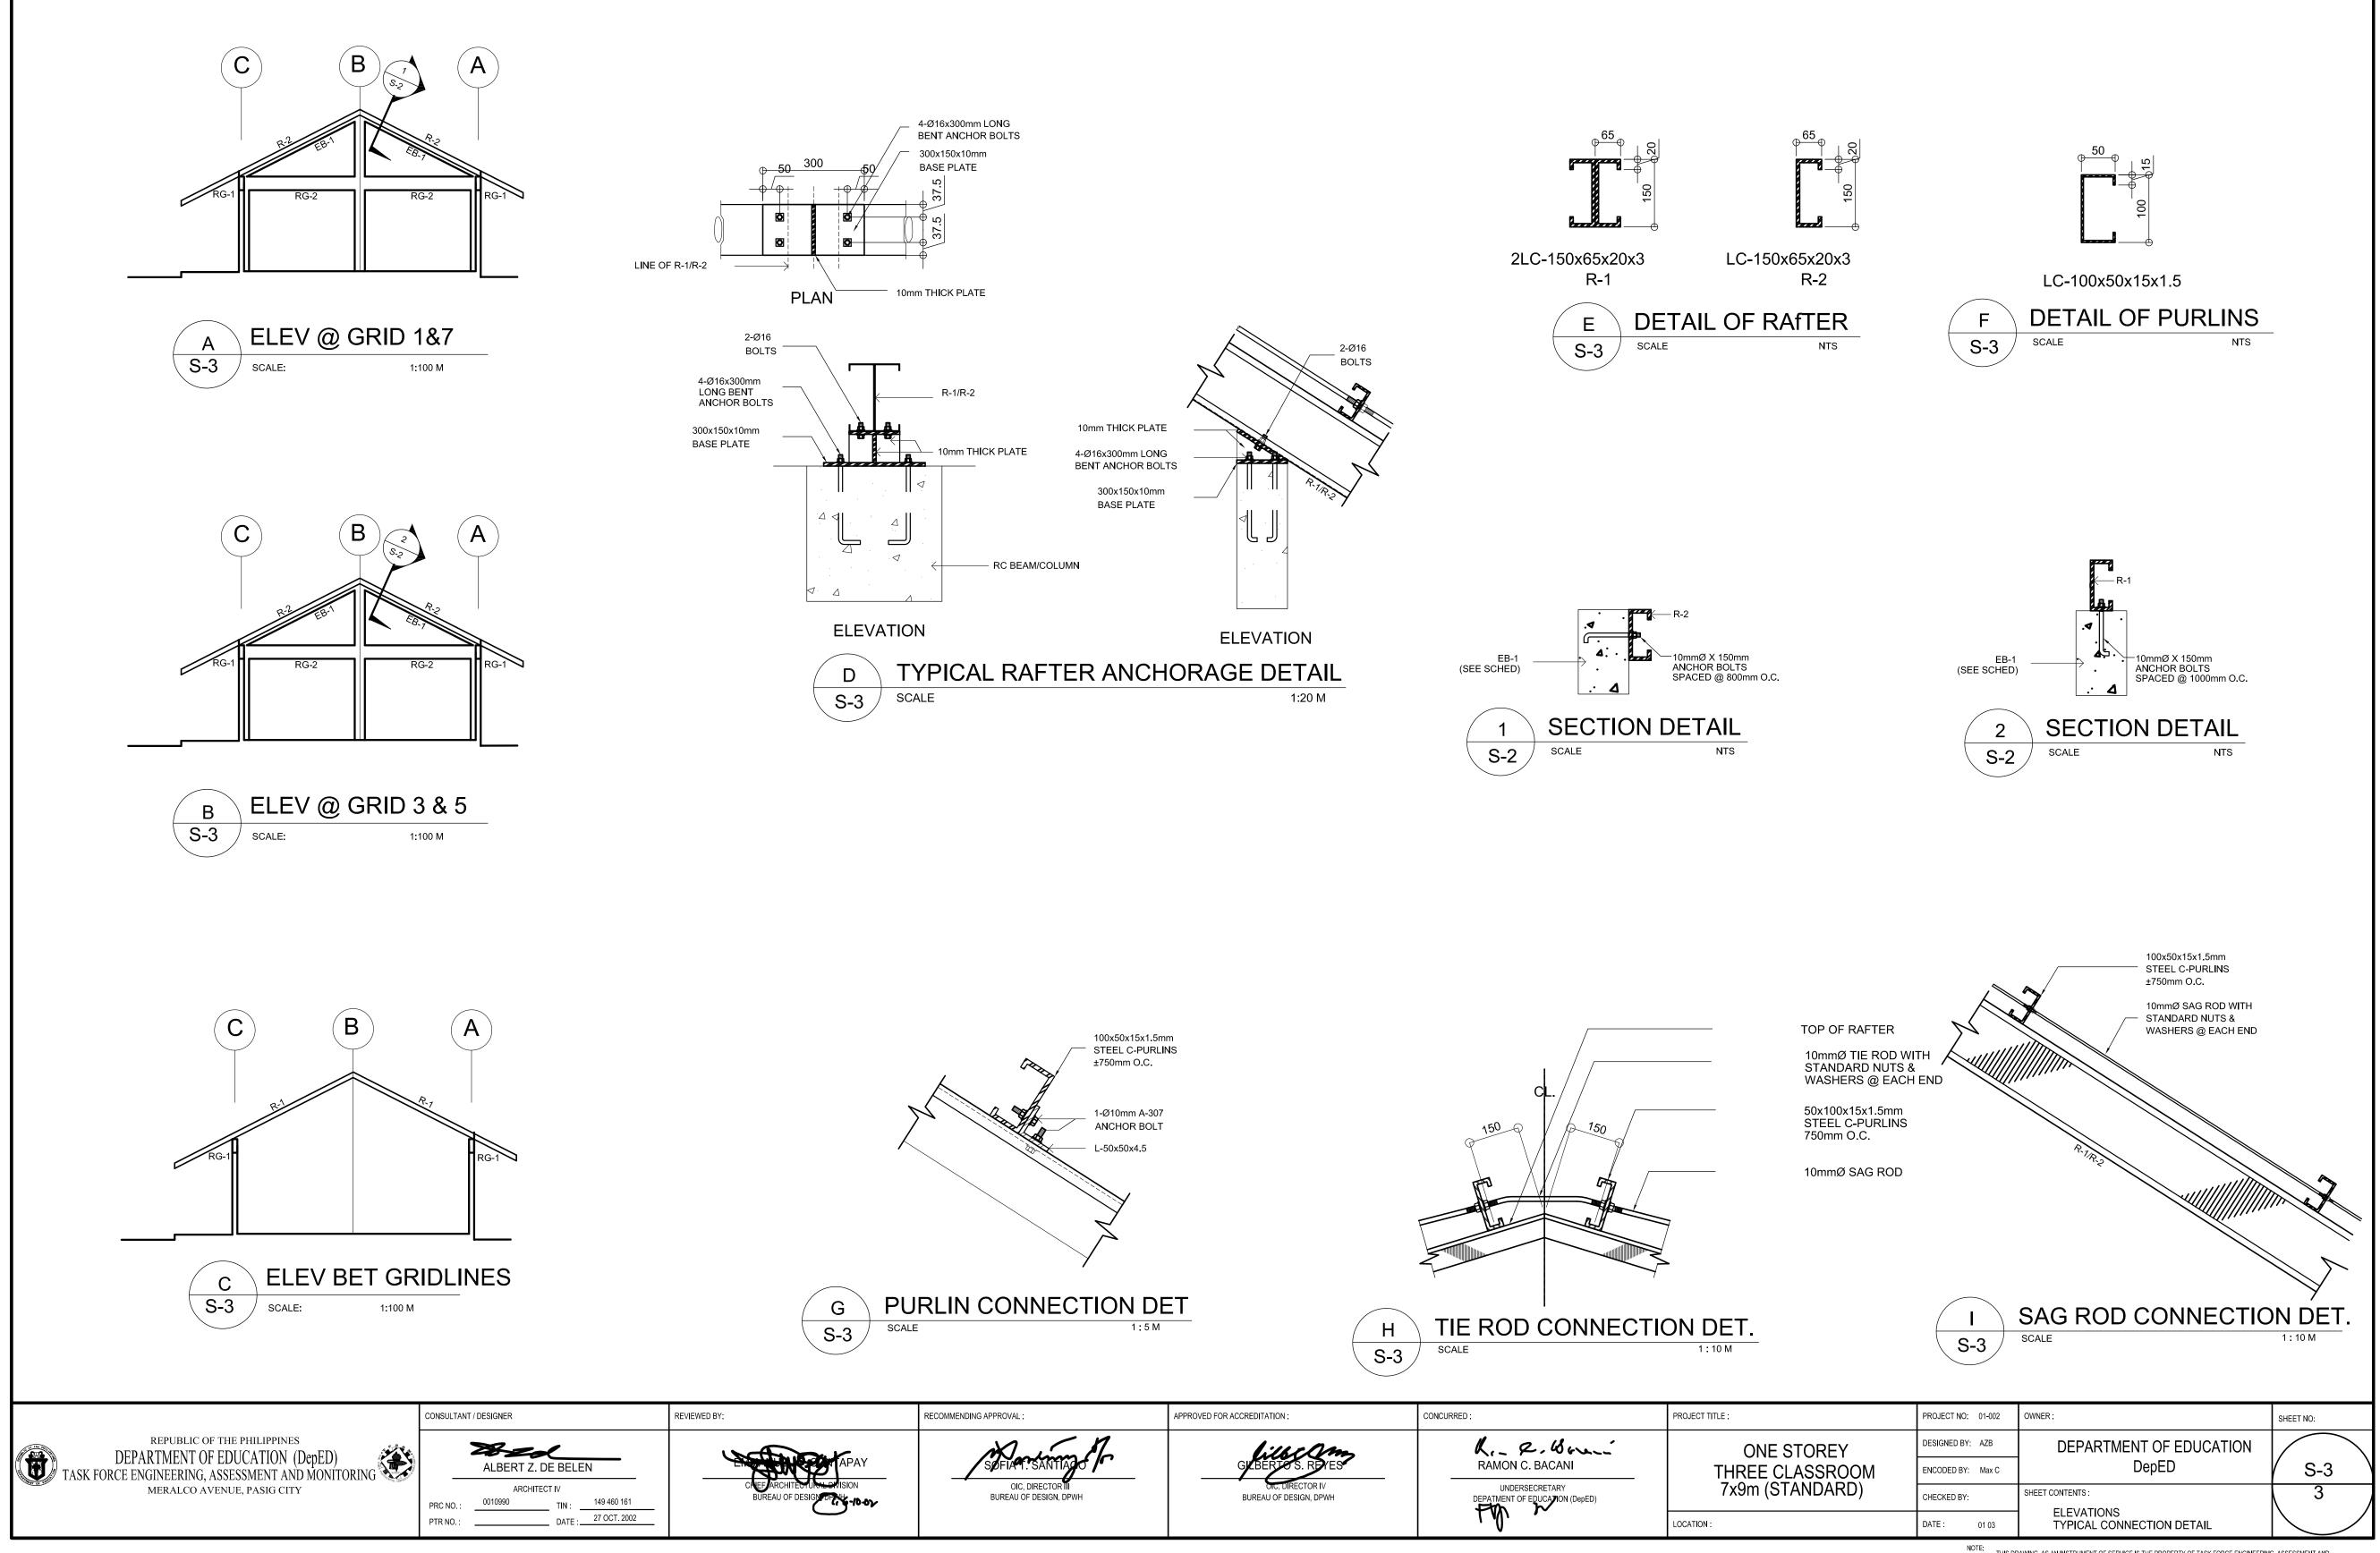

MMENDING APPROVAL :	APPROVED FOR ACCREDITATION :	CONCURRED :	PROJECT TITLE :	PROJECT NO: 01-002	OW
M	Lillecam	K. R. Brui	ONE STOREY	DESIGNED BY: AZB	
SOFIAMT SANTIAGO	GUBERTO S. REVES	RAMON C. BACANI	THREE CLASSROOM	ENCODED BY: Max C	
OIC, DIRECTOR TII BUREAU OF DESIGN, DPWH			7x9m (STANDARD)	CHECKED BY:	SHI
		Fly 2	LOCATION :	DATE : 01 03	

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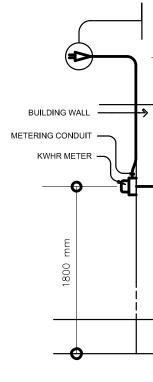
GENERAL NOTES	LEGEND		
<ol> <li>ALL ELECTRICAL WORKS SHALL COMPLY IN ACCORDANCE WITH THESE PLANS AND SPECIFICATIONS. THE APPLICABLE PROVISIONS OF THE LATEST EDITION OF THE PHILIPPINE ELECTRICAL CODE (PEC). THE RULES AND REGULATION OF THE LOCAL ENFORCING AUTHORITY AND THE REQUIREMENTS OF THE LOCAL POWER COMPANY. THE ELECTRICAL WORKS SHALL BE UNDER IMMEDIATE SUPERVISION OF A DULY REGISTERED ELECTRICAL ENGINEER.</li> </ol>	SYMBOLDESCRIPTIONImage: Constraint of the symbol-CEILING LIGHT of the symbolImage: Constraint of the symbol-2 × 40 WATTSImage: Constraint of the symbol-CEILING FAN OUS/Sa-ONE GANG DEVSab-TWO GANG DEV		
<ol> <li>2. THE ELECTRICAL SERVICE POWER IS 1-PHASE, 2-WIRE, 230 V AC, 60 Hz.</li> <li>3. WIRING METHOD SHALL BE AS FOLLOWS :</li> </ol>	Scde - THREE GANG D St - THREE WAY DE Sf - FAN CONTROL		
a. FEEDERS AND RISERS- INTERMEDIATE METALLIC CONDUITb. LIGHTING, POWER RECEPTACLE- POLYVINYL CHLORIDE CONDUITBRANCH CKT., & AUXILIARYSCH. 40	RACEWAY CONE RACEWAY CONE PANELBOARD		
4. ALL WIRES SHALL BE COPPER AND THERMOPLASTIC INSULATED TYPE "THW" UNLESS OTHERWISE INDICATED IN THE PLAN. THE MINIMUM SIZE OF WIRE FOR POWER AND LIGHTING CIRCUIT HOMERUN SHALL BE	- DUPLEX CONVE 10 AMPS, 250		
<ul> <li>3.5mm<sup>2</sup> AND INSULATED FOR 600 VOLTS. SMALLEST RACEWAY SHALL</li> <li>BE 15mmØ TRADE/NOMINAL SIZE.</li> <li>5. ALL OUTLET BOXES SHALL BE GALVANIZED GAGE NO. 16 DEEP</li> <li>TYPE WITH FACTORY KNOCKOUTS.</li> </ul>	- WEATHERPROOF WP DUPLEX CONVE 10 AMPS, 250 - HOMERUN DIRE		
6. ALL MATERIALS TO BE USED SHALL BE BRAND NEW AND APPROVED TYPE FOR THE PARTICULAR LOCATION AND PURPOSE OF USAGE.	<ul> <li>HOMERUN DIREG</li> <li>CIRCUIT BREAK</li> <li>ELECTRIC SERV</li> </ul>		
7. GROUNDING SYSTEM SHALL BE PROVIDED TO ALL LIGHTING AND POWER CIRCUIT AS PER PHILIPPINE ELECTRICAL CODE REQUIREMENT. 8. MOUNTING HEIGHT OF WIRING DEVICES SHALL BE AS FOLLOWS :	- SERVICE ENTRA		
a. LIGHT SWITCH- 1.20 M ABOVE FINISH FLOORb. CONVENIENCE OUTLET- 0.30 M ABOVE FINISH FLOOR.			

# LOAD SCHEDULE

- 1.80 M ABOVE FINISH FLOOR

c. PANELBOARD

CKT.	ELBOARD: LP	VA	CIRCUIT BREAKER				//AIN: 60AT, 100AF, 2P, 230V
NO.	DESCRIPTION	LOAD	VOLT	POLE	AT	AF	WIRE & CONDUIT SIZE
1	CONV. OUTLET - 8 x 180W	1440	230	2	20	50	3-3.5mm <sup>2</sup> THW IN 15mmØ C
2	LIGHTING OUTLET - 8 x 100W	800	230	2	20	50	3-3.5mm <sup>2</sup> THW IN 15mmØ C
3	LIGHTING OUTLET - 10 x 100W	1000	230	2	20	50	3-3.5mm² THW IN 15mmØ C
4	SPARE	1500	230	2	20	50	
	TOTAL	4740		_			
IL =	4740 = 20.6  A 230 V					2-14mm² THW IN 25mmØ C FION: 60 AT, 100 AF, 2P, 230 V	






	CONSULTANT / DESIGNER	REVIEWED BY:	RECOMMENDING APPROVAL :	APPROVED FOR ACCREDITATION :	CONCURRED :	PROJECT TITLE :	PROJECT NO: 99-000-001
REPUBLIC OF THE PHILIPPINES DEPARTMENT OF EDUCATION (DepED) TASK FORCE ENGINEERING, ASSESSMENT AND MONITORING MERALCO AVENUE, PASIG CITY	Tord		Maria Ma	lillacam	Kr. R. Bouni	THREE CLASSROOM	DESIGNED BY: RDRDS
	ALBERT Z. DE BELEN		SOFIAT. SANTIADO	GIBERTOS. REVES	RAMON C. BACANI		ENCODED BY: RD\$RDS
		BUREAU OF DESIGN DPAH -D-OX	OIC, DIRECTOR TII BUREAU OF DESIGN, DPWH	OTC, DIRECTOR IV BUREAU OF DESIGN, DPWH			CHECKED BY:
	PTR NO. : DATE :27 OCT. 2002					LOCATION :	DATE :5-5-00 5-5-00


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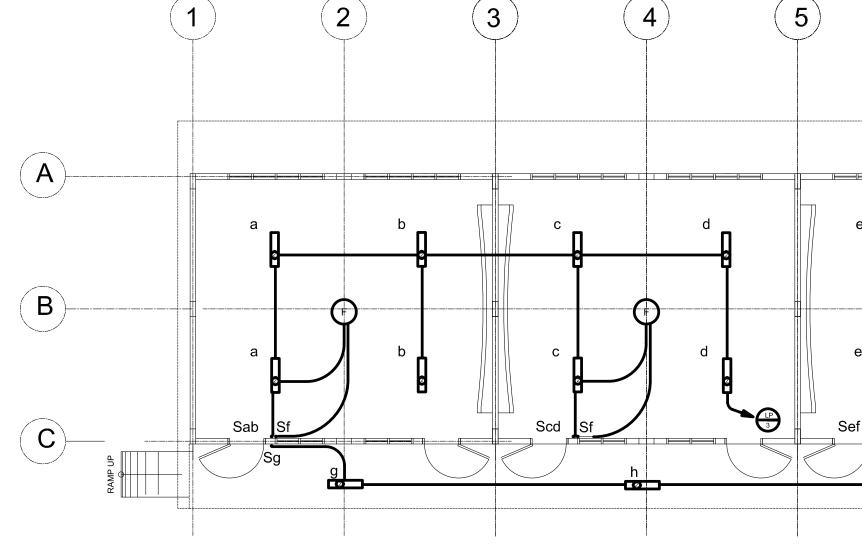
OUTLET

- TS FLUORESCENT LAMP
- OUTLET
- EVICE SWITCH
- EVICE SWITCH
- DEVICE SWITCH
- DEVICE SWITCH
- SWITCH
- NDUIT CONCEALED IN CEILING NDUIT CONCEALED UNDER FLOOR
- VENIENCE OUTLET, GROUNDING TYPE 50 VOLT WITH MODERN PLATE COVER
- OF TYPE
- VENIENCE OUTLET, GROUNDING TYPE 50 VOLT WITH MODERN PLATE COVER
- RECT TO PANELBOARD
- AKER, RATING AS INDICATED
- RVICE METER
- RANCE



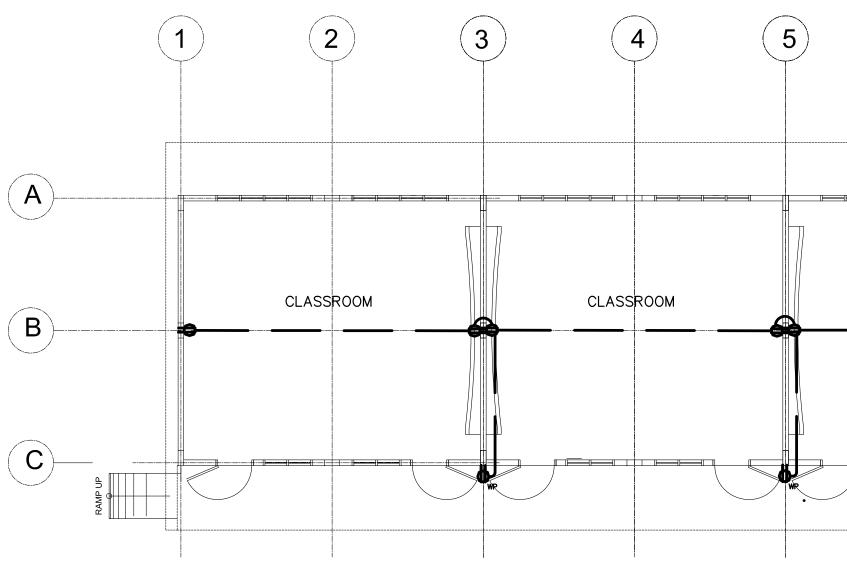




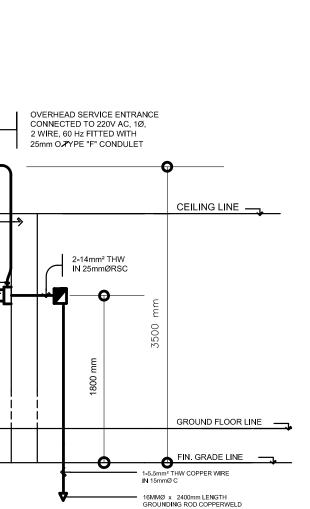

## ELECTRICAL RISER DIAGRAM ТО

#### SCALE

LIGHTING LAYOUT SCALE 1:100 M

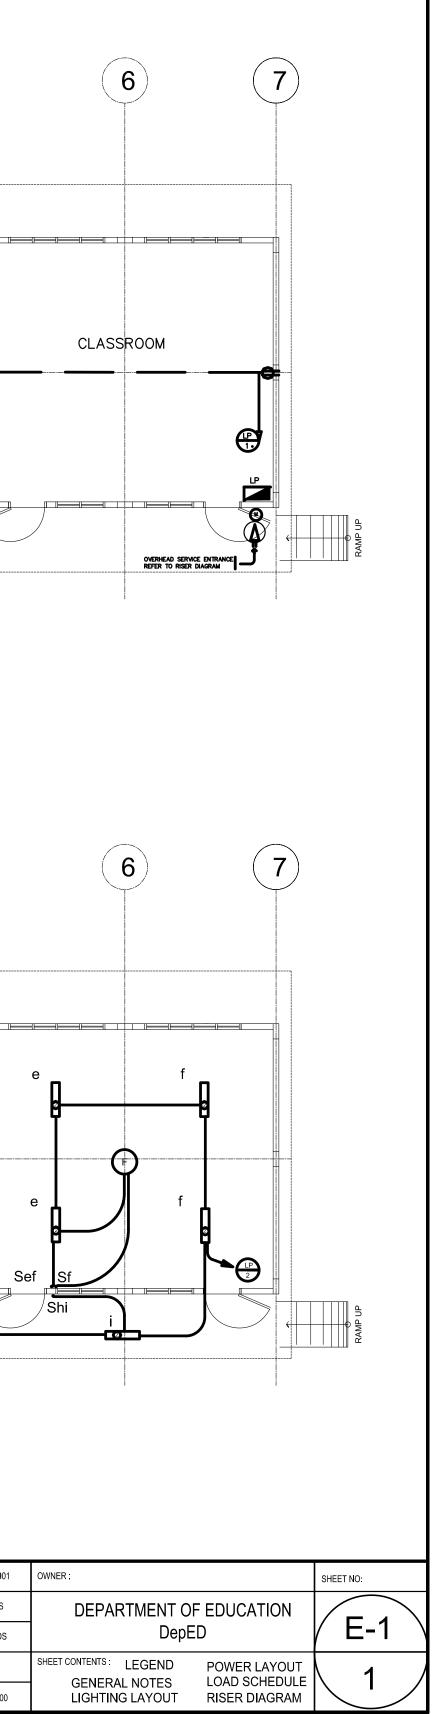

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