



ROVAL : W	GILBERTO S. REYES	RAMON C. BACANI		) STOREY LASSROOM	DESIGNED BY: ENCODED BY: Max C.	DEPART	MENT OF EDUCATION DepED	SHEET NO:
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				P-2 SEPTIC TA LEGEND, M	NK, CATCH BAS NOTES & DESIG	IN DETAILS N CRITERIA	MECHANICAL	
					OUT & ISOMETI	RIC VIEW		
				SANITARY		D005		
				E-3 GROUND F		LAYOUT	ELECTRICAL	
				LINE DIAG E-2 GROUND F SECOND F		AYOUT		
				E-1 GEN. NOTE SCHEDULE	, RISER DIAGRA	AD M, SINGLE		
				ELECTRICAL				
							SANITARY	
				DETAILS O	F STEEL CONNE	CTION		
				BEAM, FOO DETAIL S-3 TRUSS DIA	DTING/TIE BEAM GRAM, STAIR D	/COLUMN ET.		
				S-1 FOUNDATIO 2ND FLOC S-2 DET. STAIF	R & ROOF FRA	MING PLAN	STRUCTURAL	
				STRUCTURAL				
							ARCHITECTURAL	
				A-5 TOILET, CO				
				RAILING,	EAVES, RAMP DETAILS		LINL & UNAUL	
				ELEV. A-4 LEFT SIDE		OF	LINE & GRADE	
				REFLECTEI A-3 LONGITUDI FRONT, RE	) CEILING PLAN	S CTION,		
				A–1 PERSPECT CONTENTS A–2 GROUND,	SECOND FLOOR	, ROOF,		
				ARCHITECTURA	<u>L</u>		LAND USE & ZO	DNING
							DISTRICT/CITY/MUN	IICIPALITY
				CC	OF NTEN	TS		
				r	TABLE		OFFICE OF THE CITY ENGINEER/BUILDIN	/MUNICIPAL
							<b>REPUBLIC OF THE PH</b>	HILIPPINES

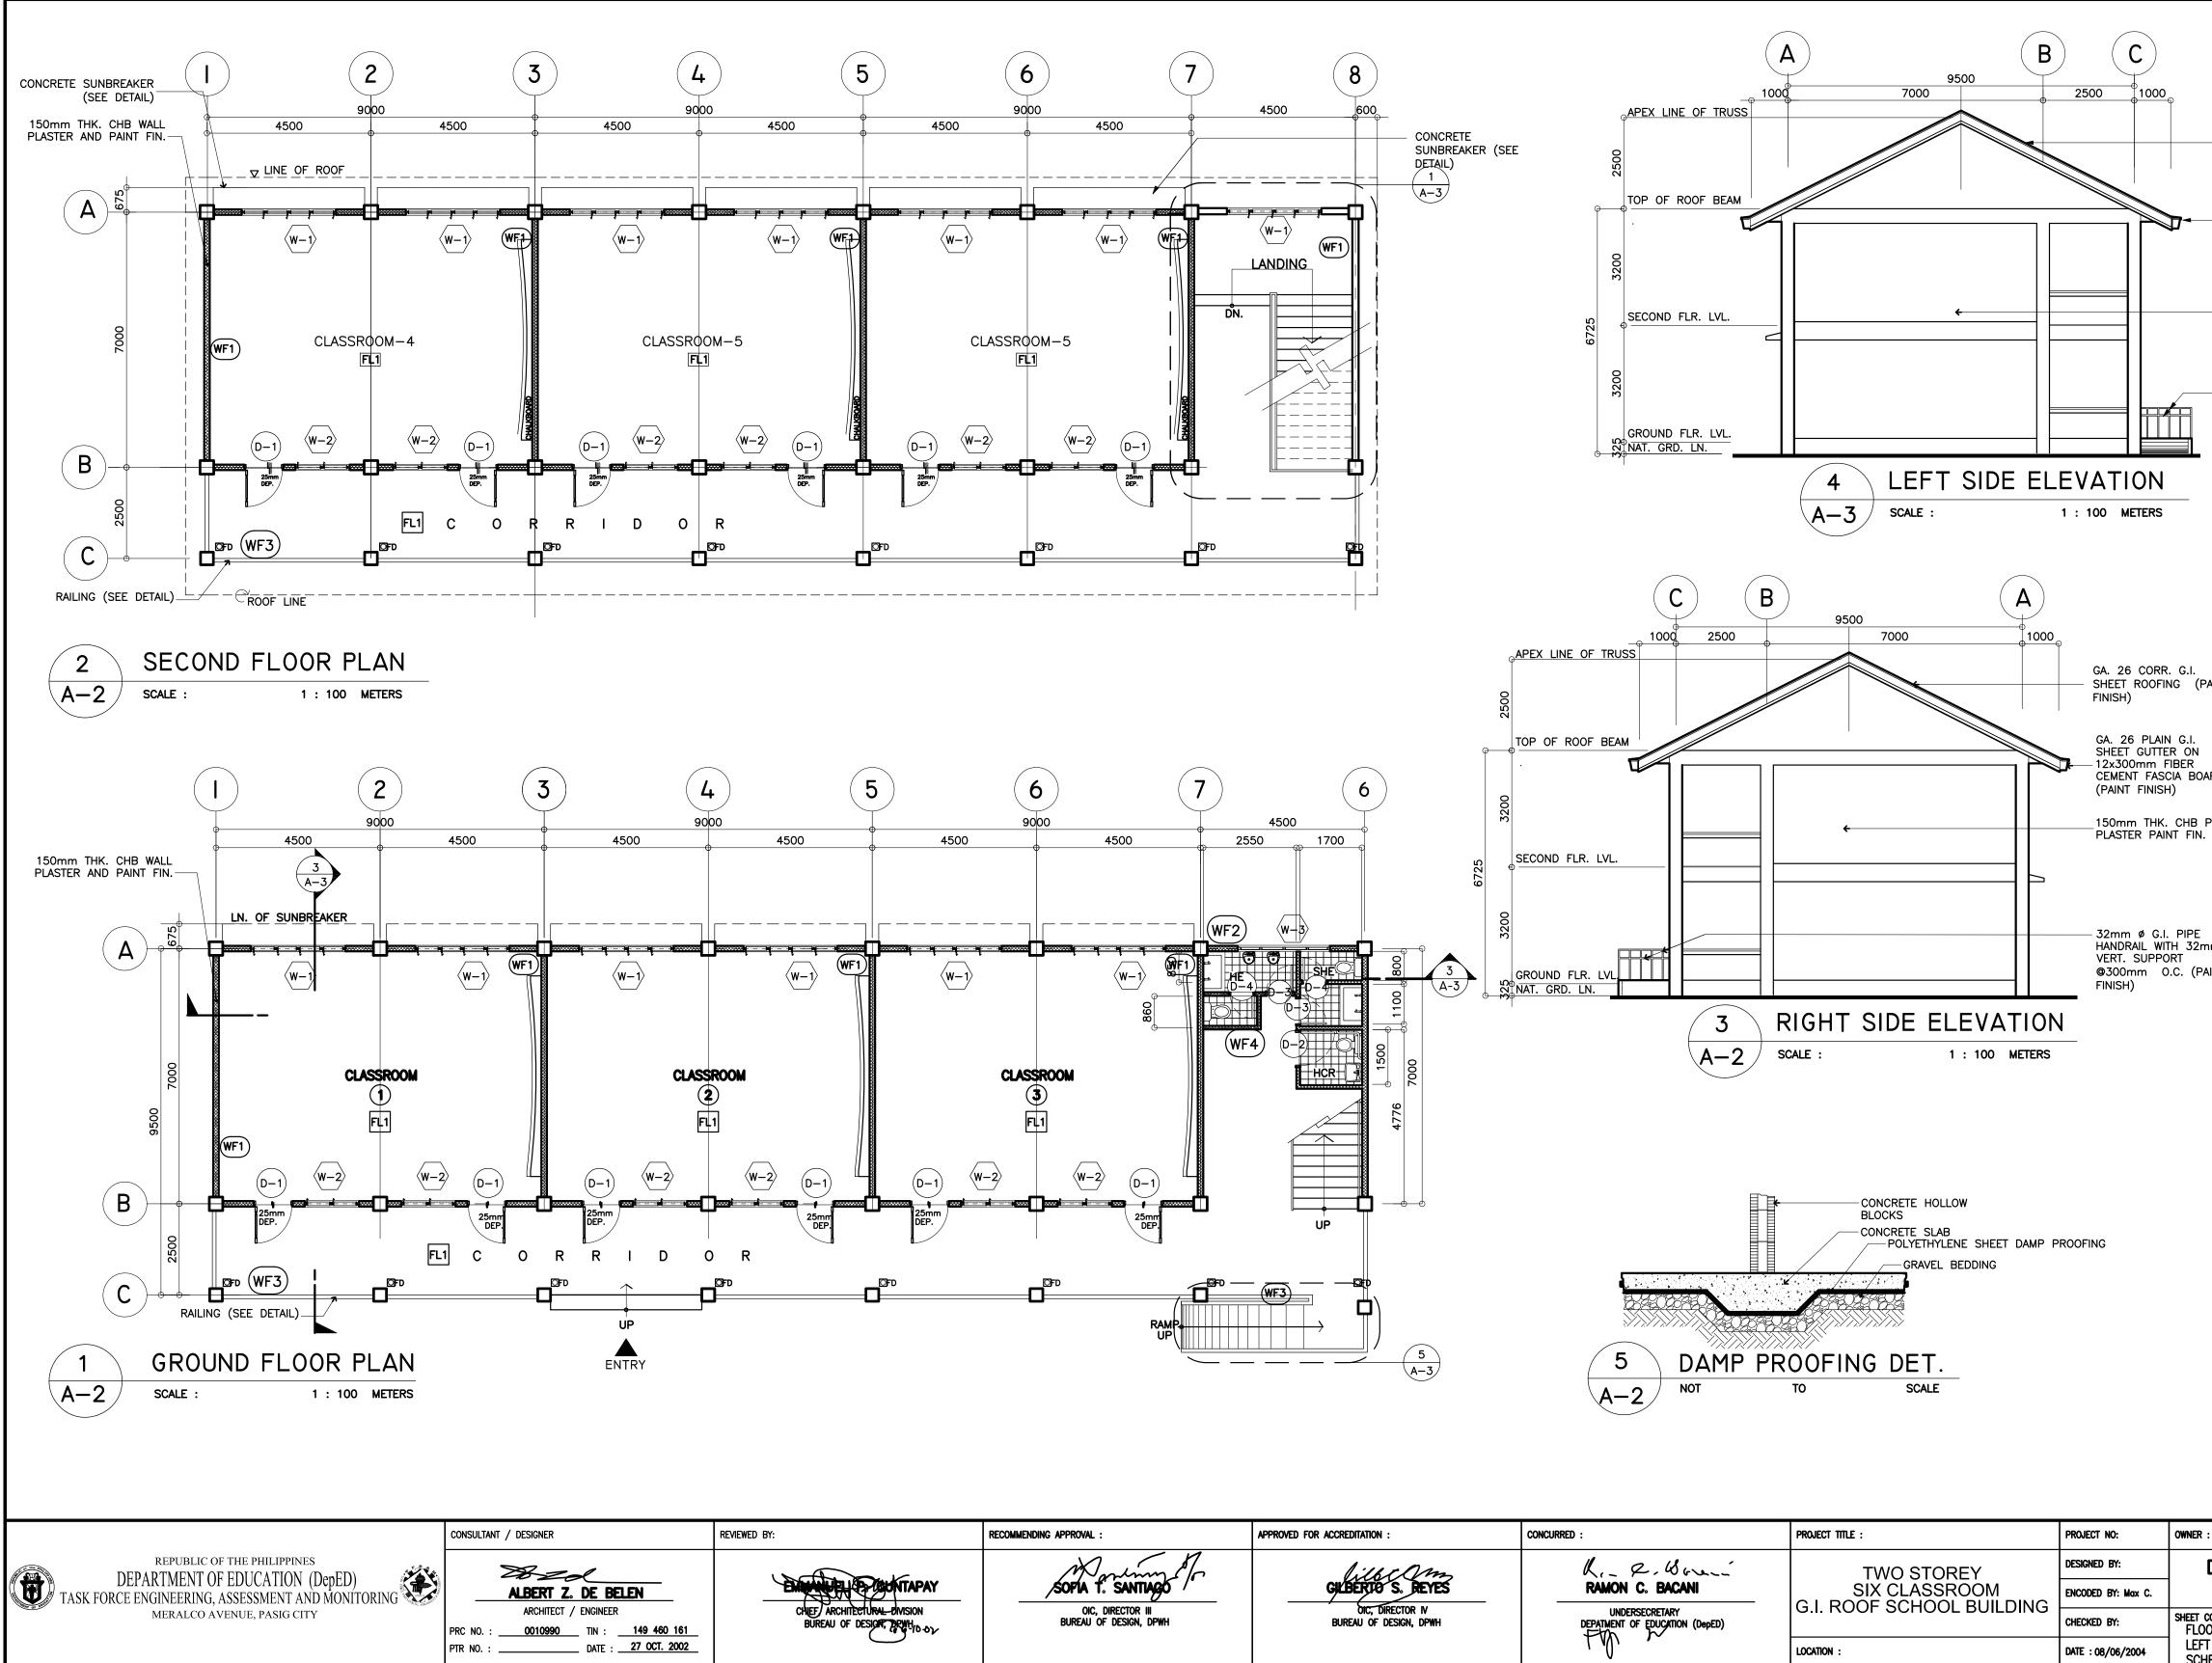


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SOPIA T. SANTIAGO OIC, DIRECTOR III BUREAU OF DESIGN, DPWH	GILBERTO S. REYES	RAMON C. BACANI	SIX CLASSROOM G.I. ROOF SCHOOL BUILDING	ENCODED BY: Max C.	
	Dic, Director IV Bureau of Design, DPWH	UNDERSECRETARY DEPATMENT OF EDUCATION (DepED)		CHECKED BY:	SHEET CO
		Fy 2	Location :	DATE : 08/06/2004	Left   Schei

GA. 26 CORR. G.I. SHEET ROOFING (PAINT FINISH)	
GA. 26 PLAIN G.I. SHEET GUTTER ON 12x300mm FIBER CEMENT FASCIA BOARD (PAINT FINISH)	
150mm THK. CHB ————PLAIN PLASTER PAINT FIN.	
——————————————————————————————————————	
PAINT	
ARD	
PLAIN	
SCHEDULE OF FINISH	_
AINT FLOORS :	
FL1 – PLAIN CEMENT FLOOR	
FL2 – PLAIN CEMENT FLOOR WITH GROOVES	ROUGH
<b>FL3</b> – 200X200 VITRIFIED FL ( UNGLAZED )	R TILES
WALLS :	
WF1) - 150 MM THK. CHB W CEMENT PLASTER FIN	/ PLAIN (PAINT)
(WF2) – 150mm THK. CHB w/ VITRIFIED WALL TILES	(200X200mm ( GLAZED )
WF3) – 100mm THK. CHB PL PLASTER w/50mmø G HANDRAIL PAINT FIN.	
(WF4) – 100mm THK. CHB w/ VITRIFIED WALL TILES	(200X200mm (GLAZED)
	SHEET NO:
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EDULE OF FINISHES. DAMP PROOFING	

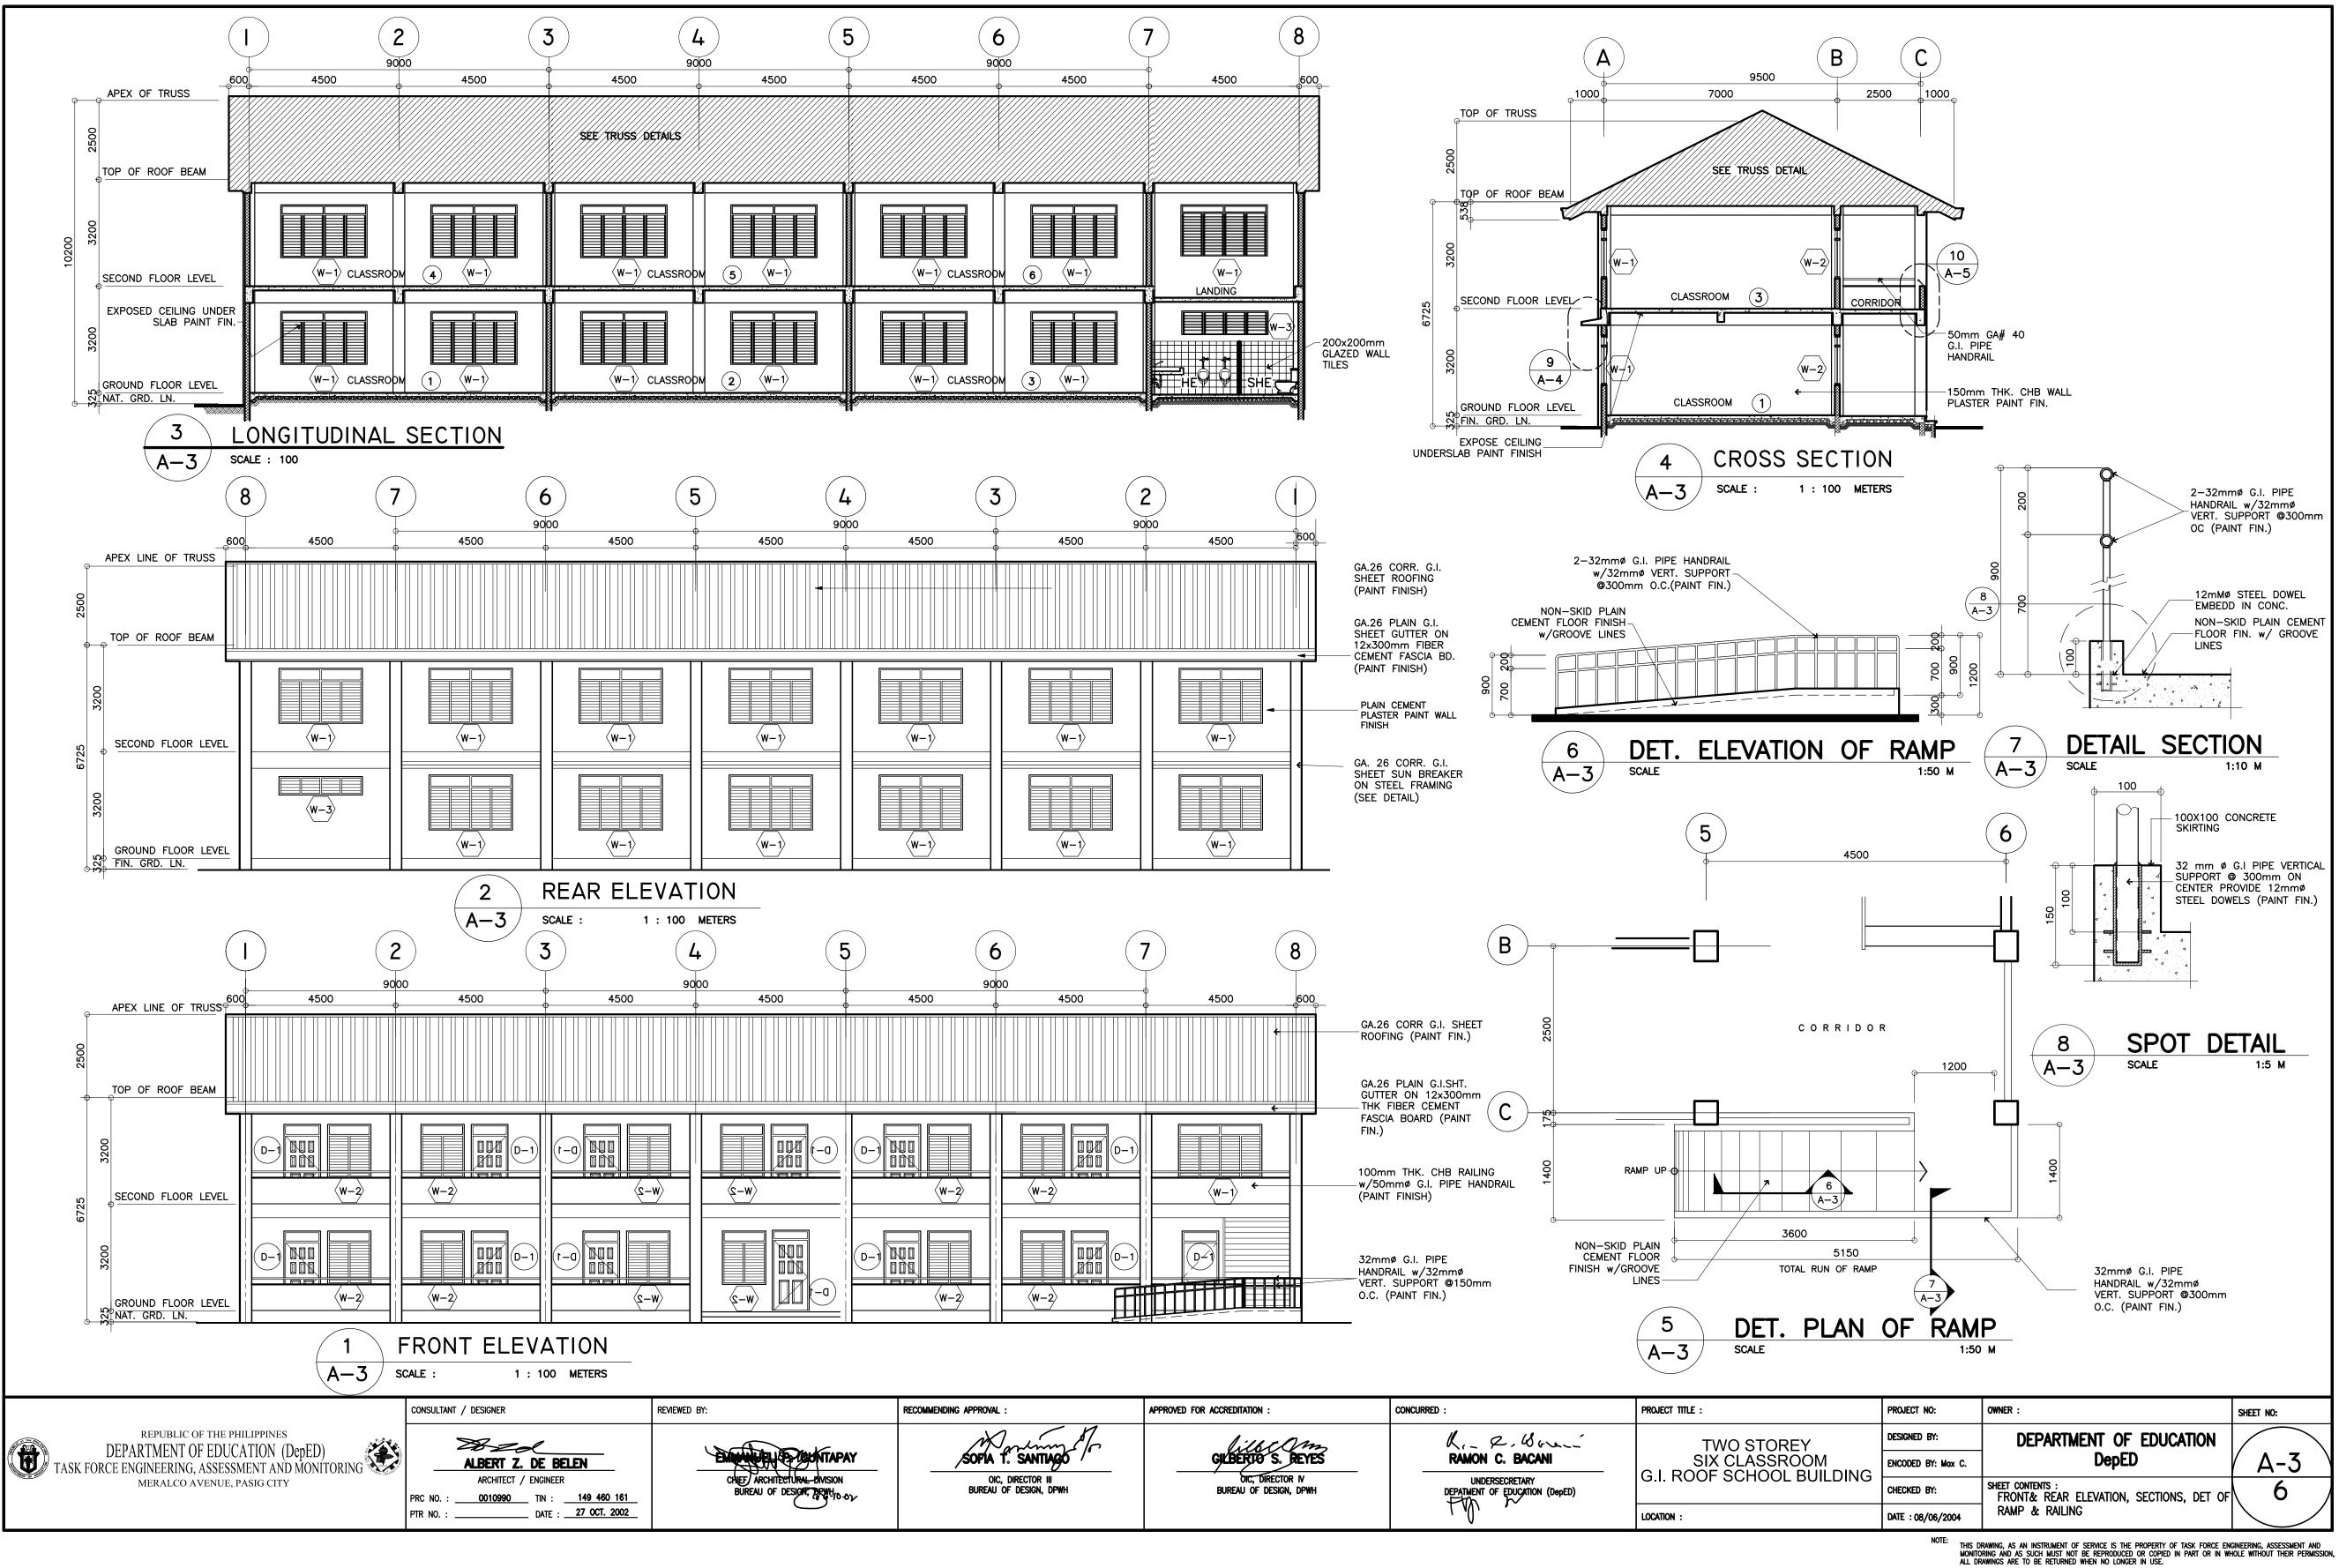


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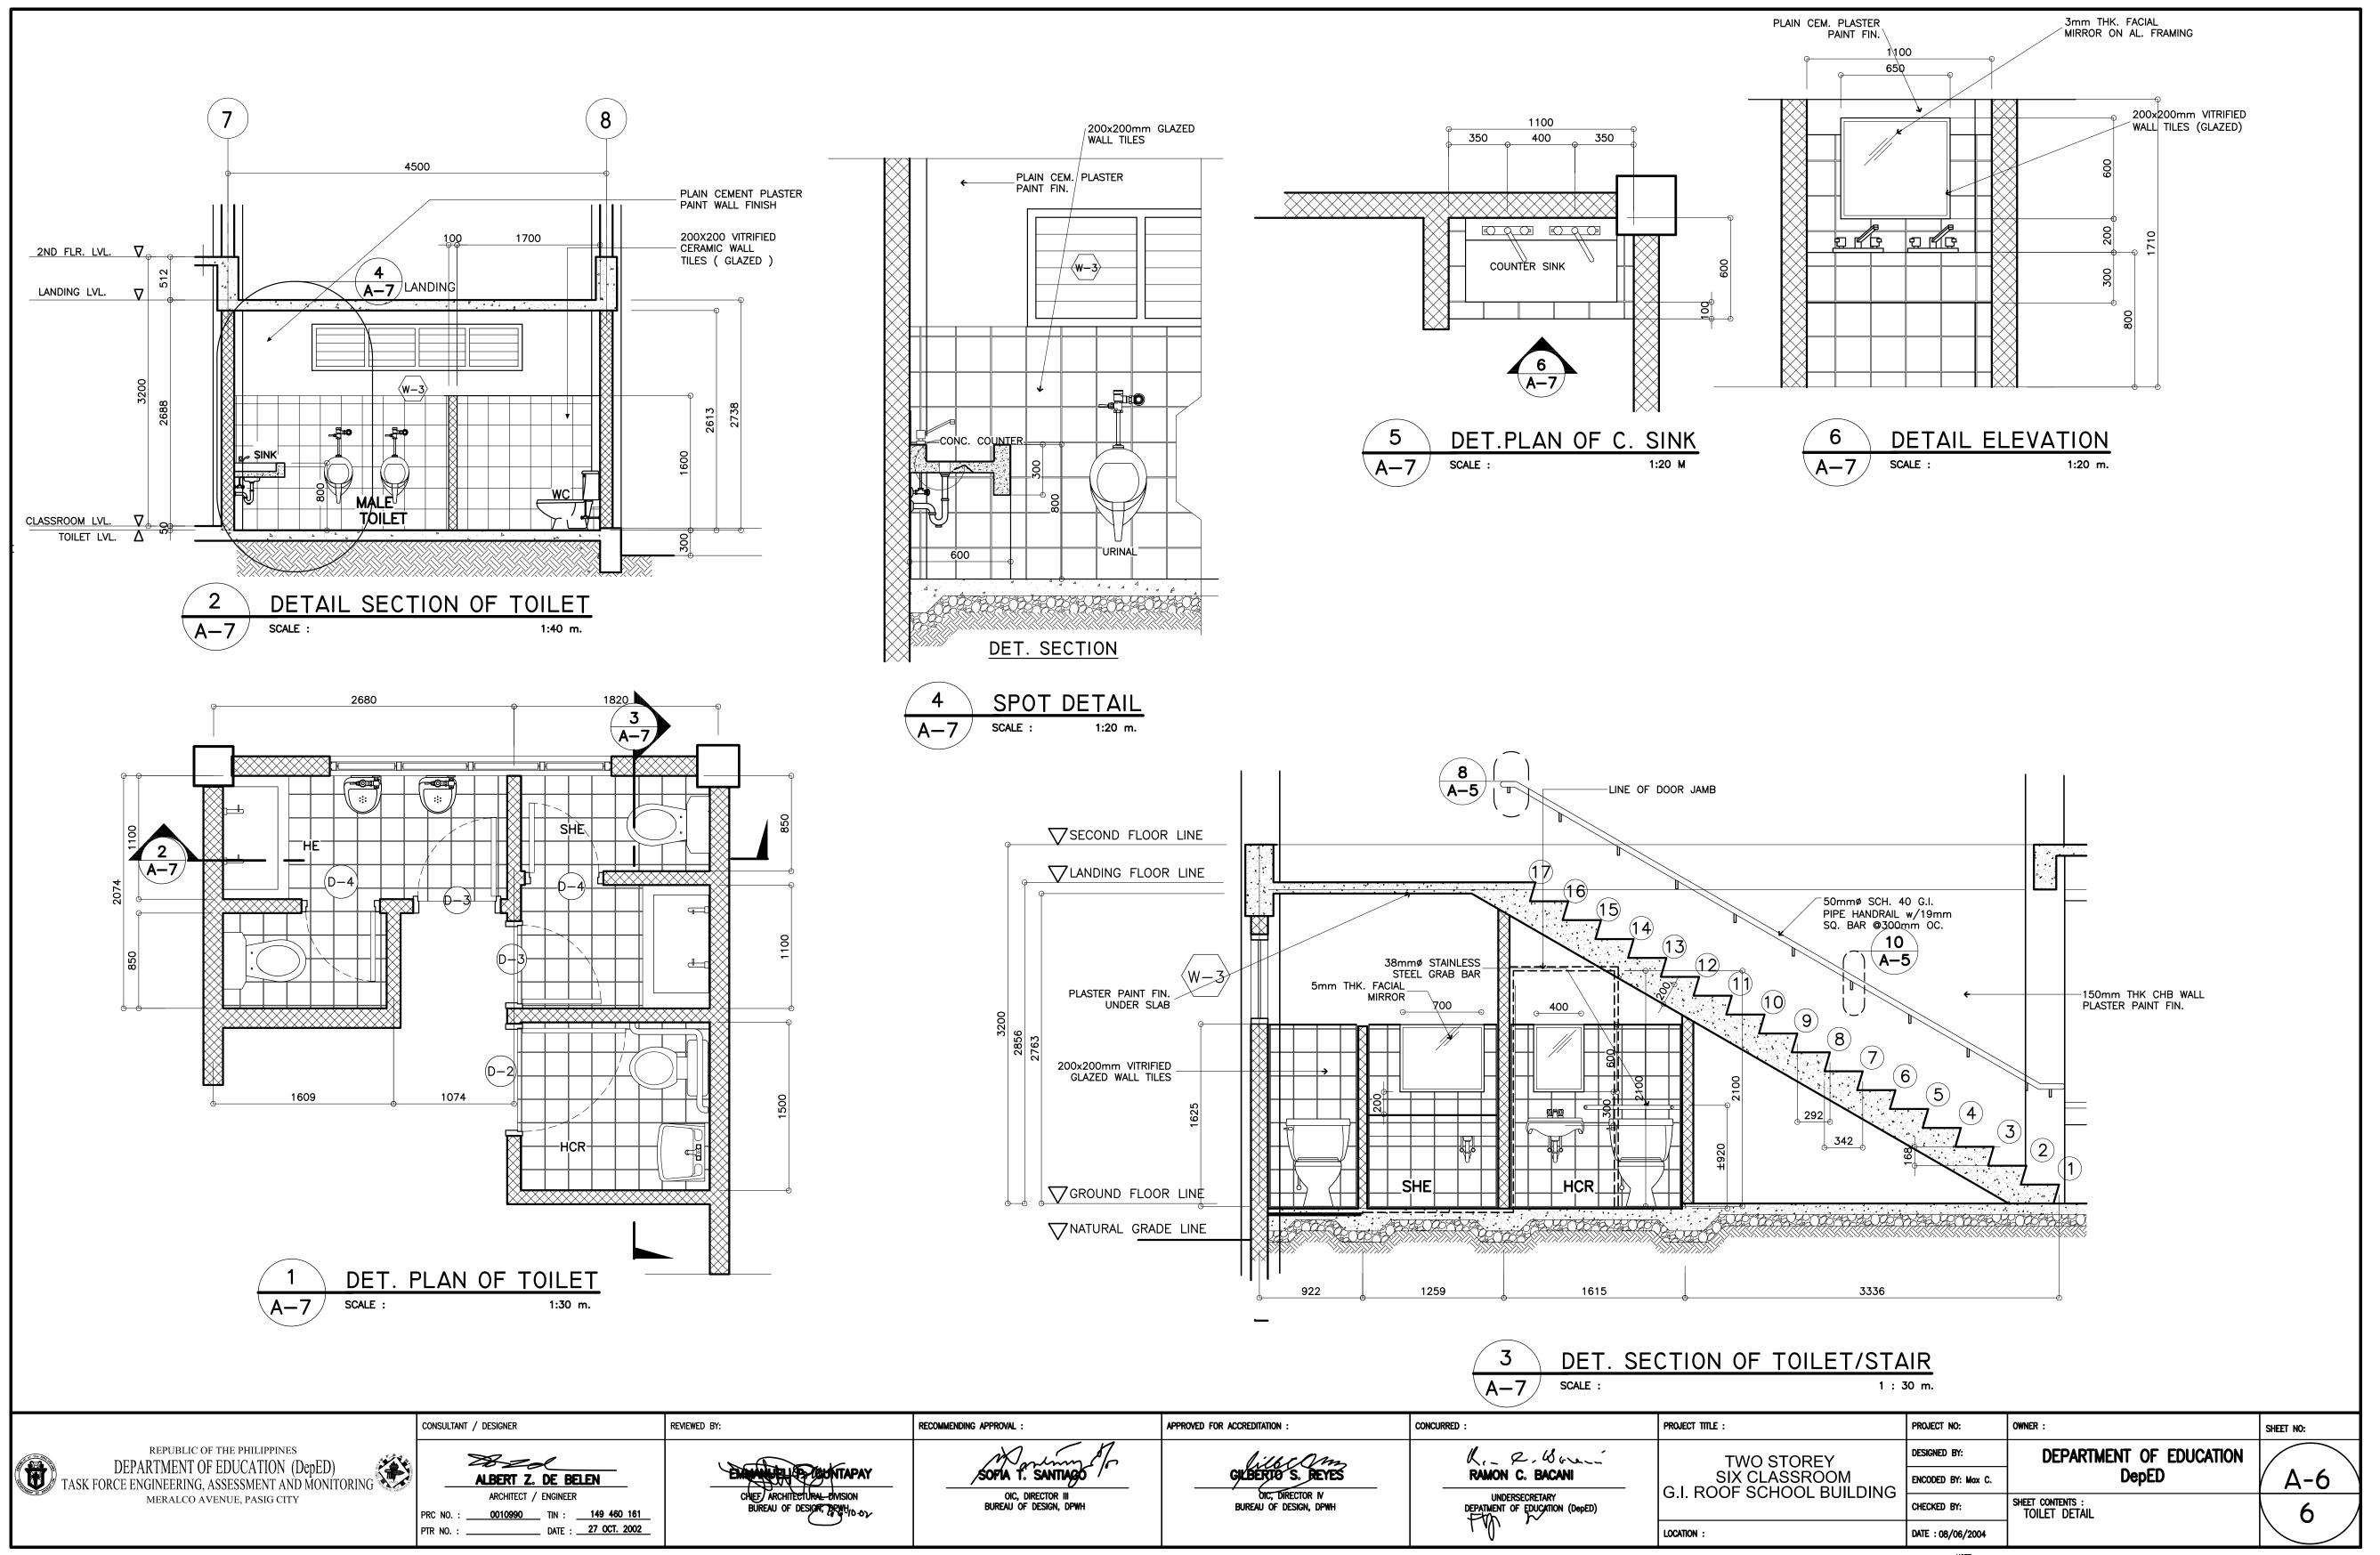


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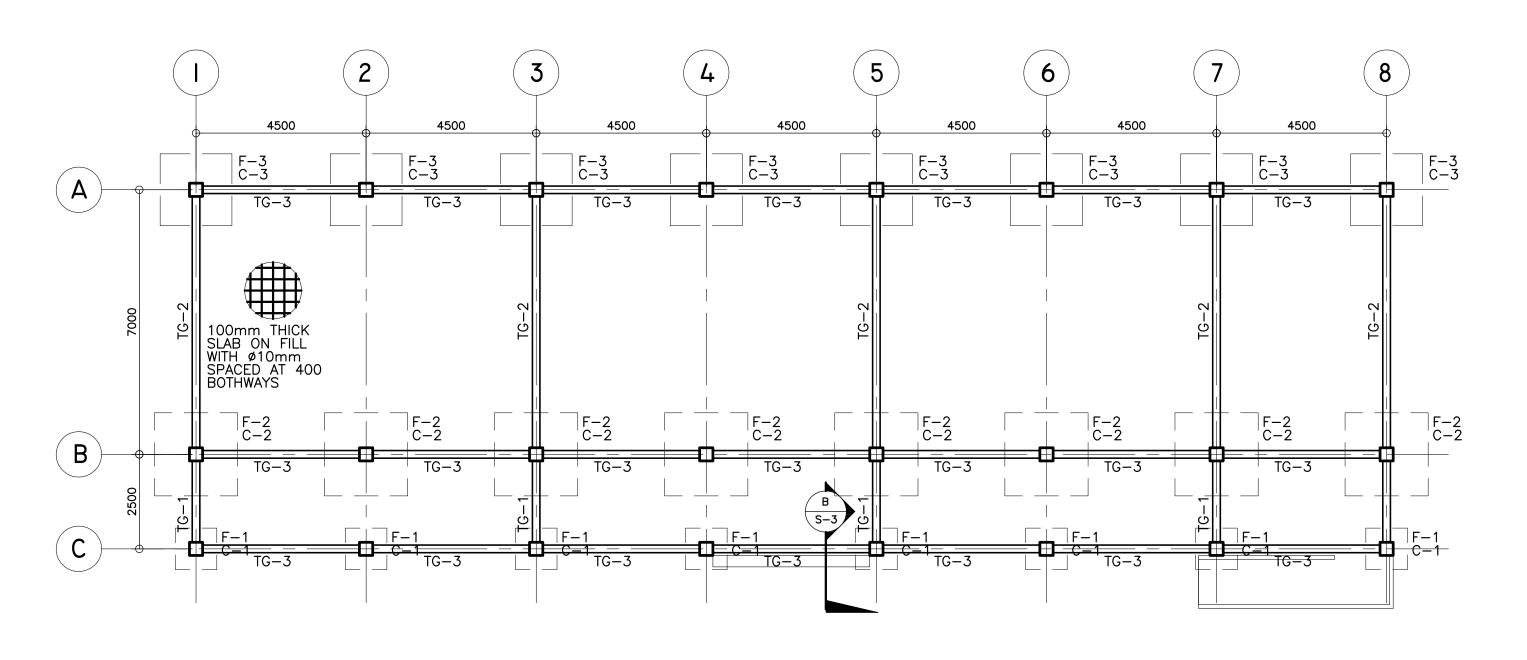


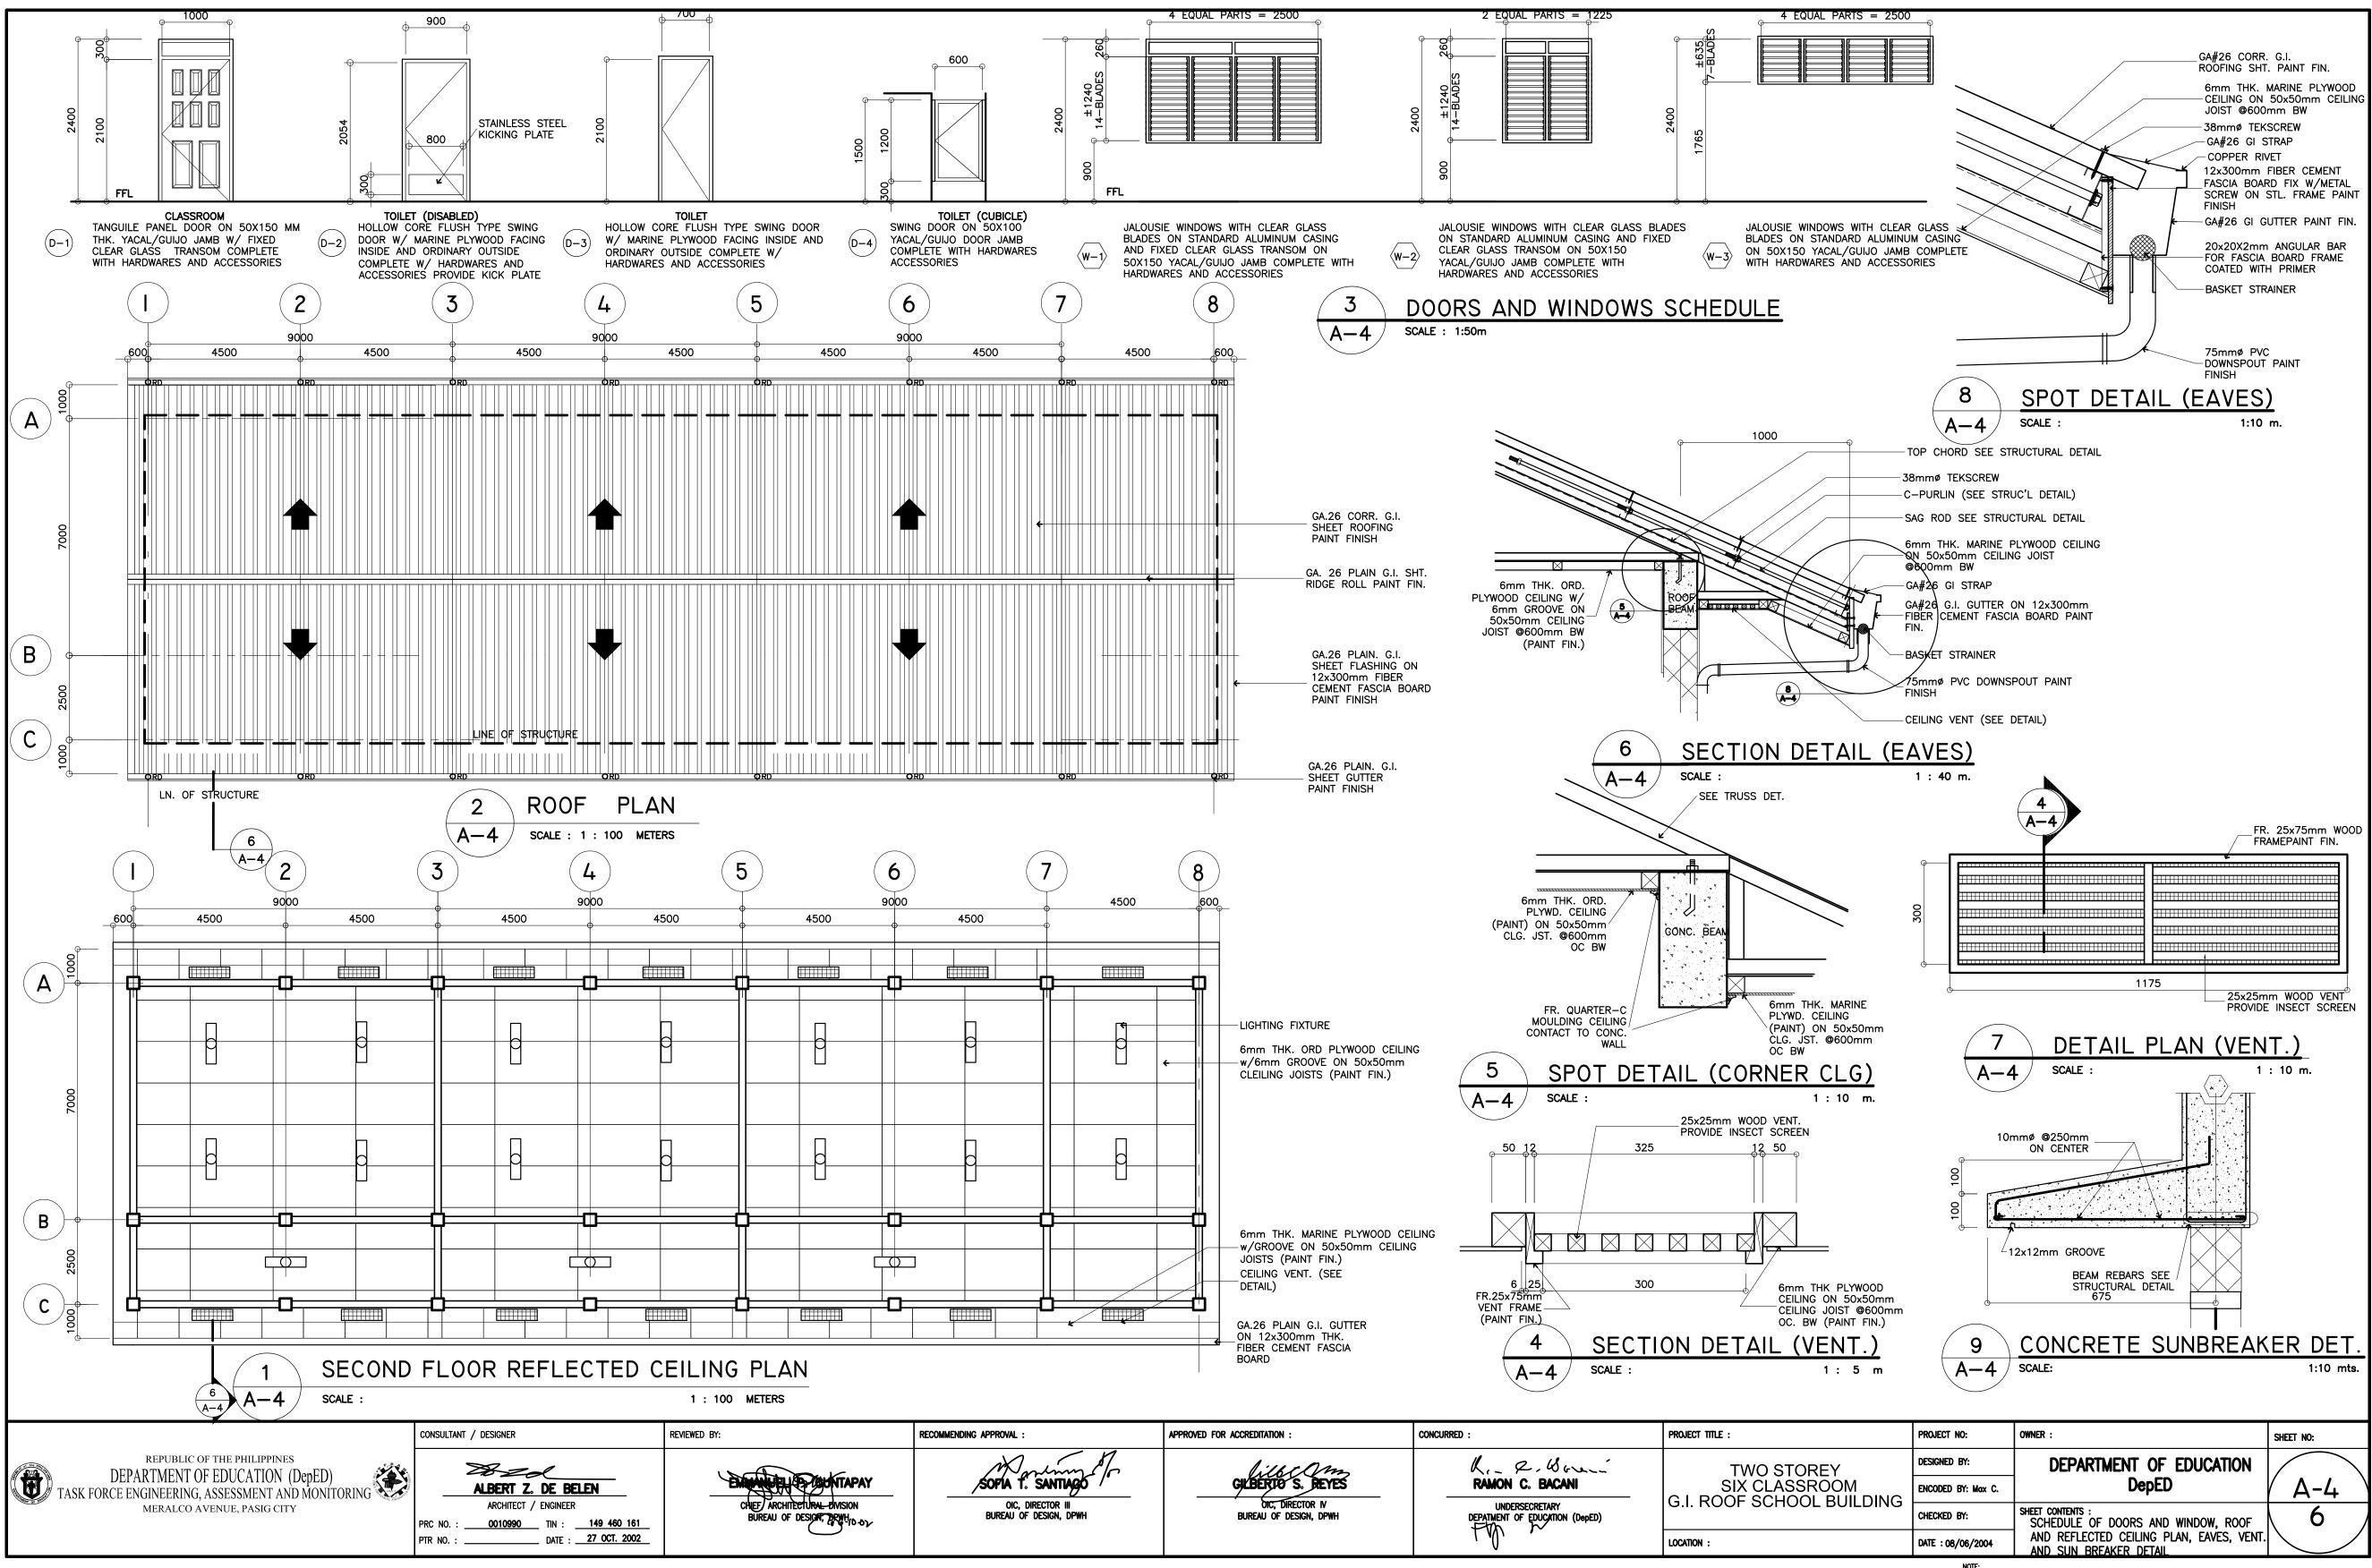
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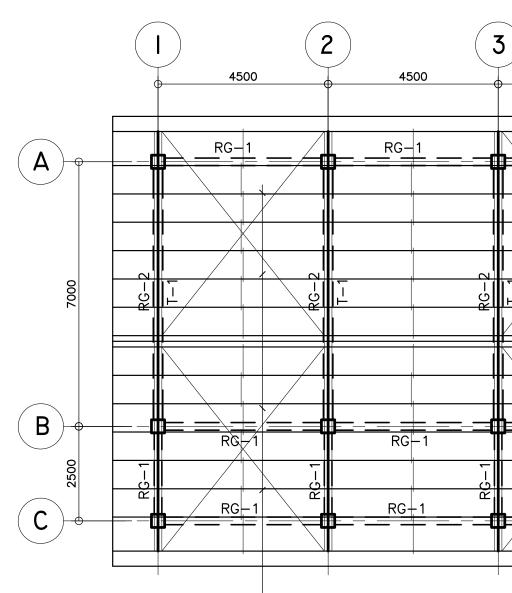
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REPUBLIC OF THE PHILIPPINES DEPARTMENT OF EDUCATION (DepED) TASK FORCE ENGINEERING, ASSESSMENT AND MONITORING MERALCO AVENUE, PASIG CITY	ANTONIA         M. MANIO           CML ENGINEER           PRC NO. :         70071           TIN :         188-342-853           PTR NO. :         DATE :	OIC, STRUCTURAL DIVISION BUREAU OF DESIGN, DPWH	

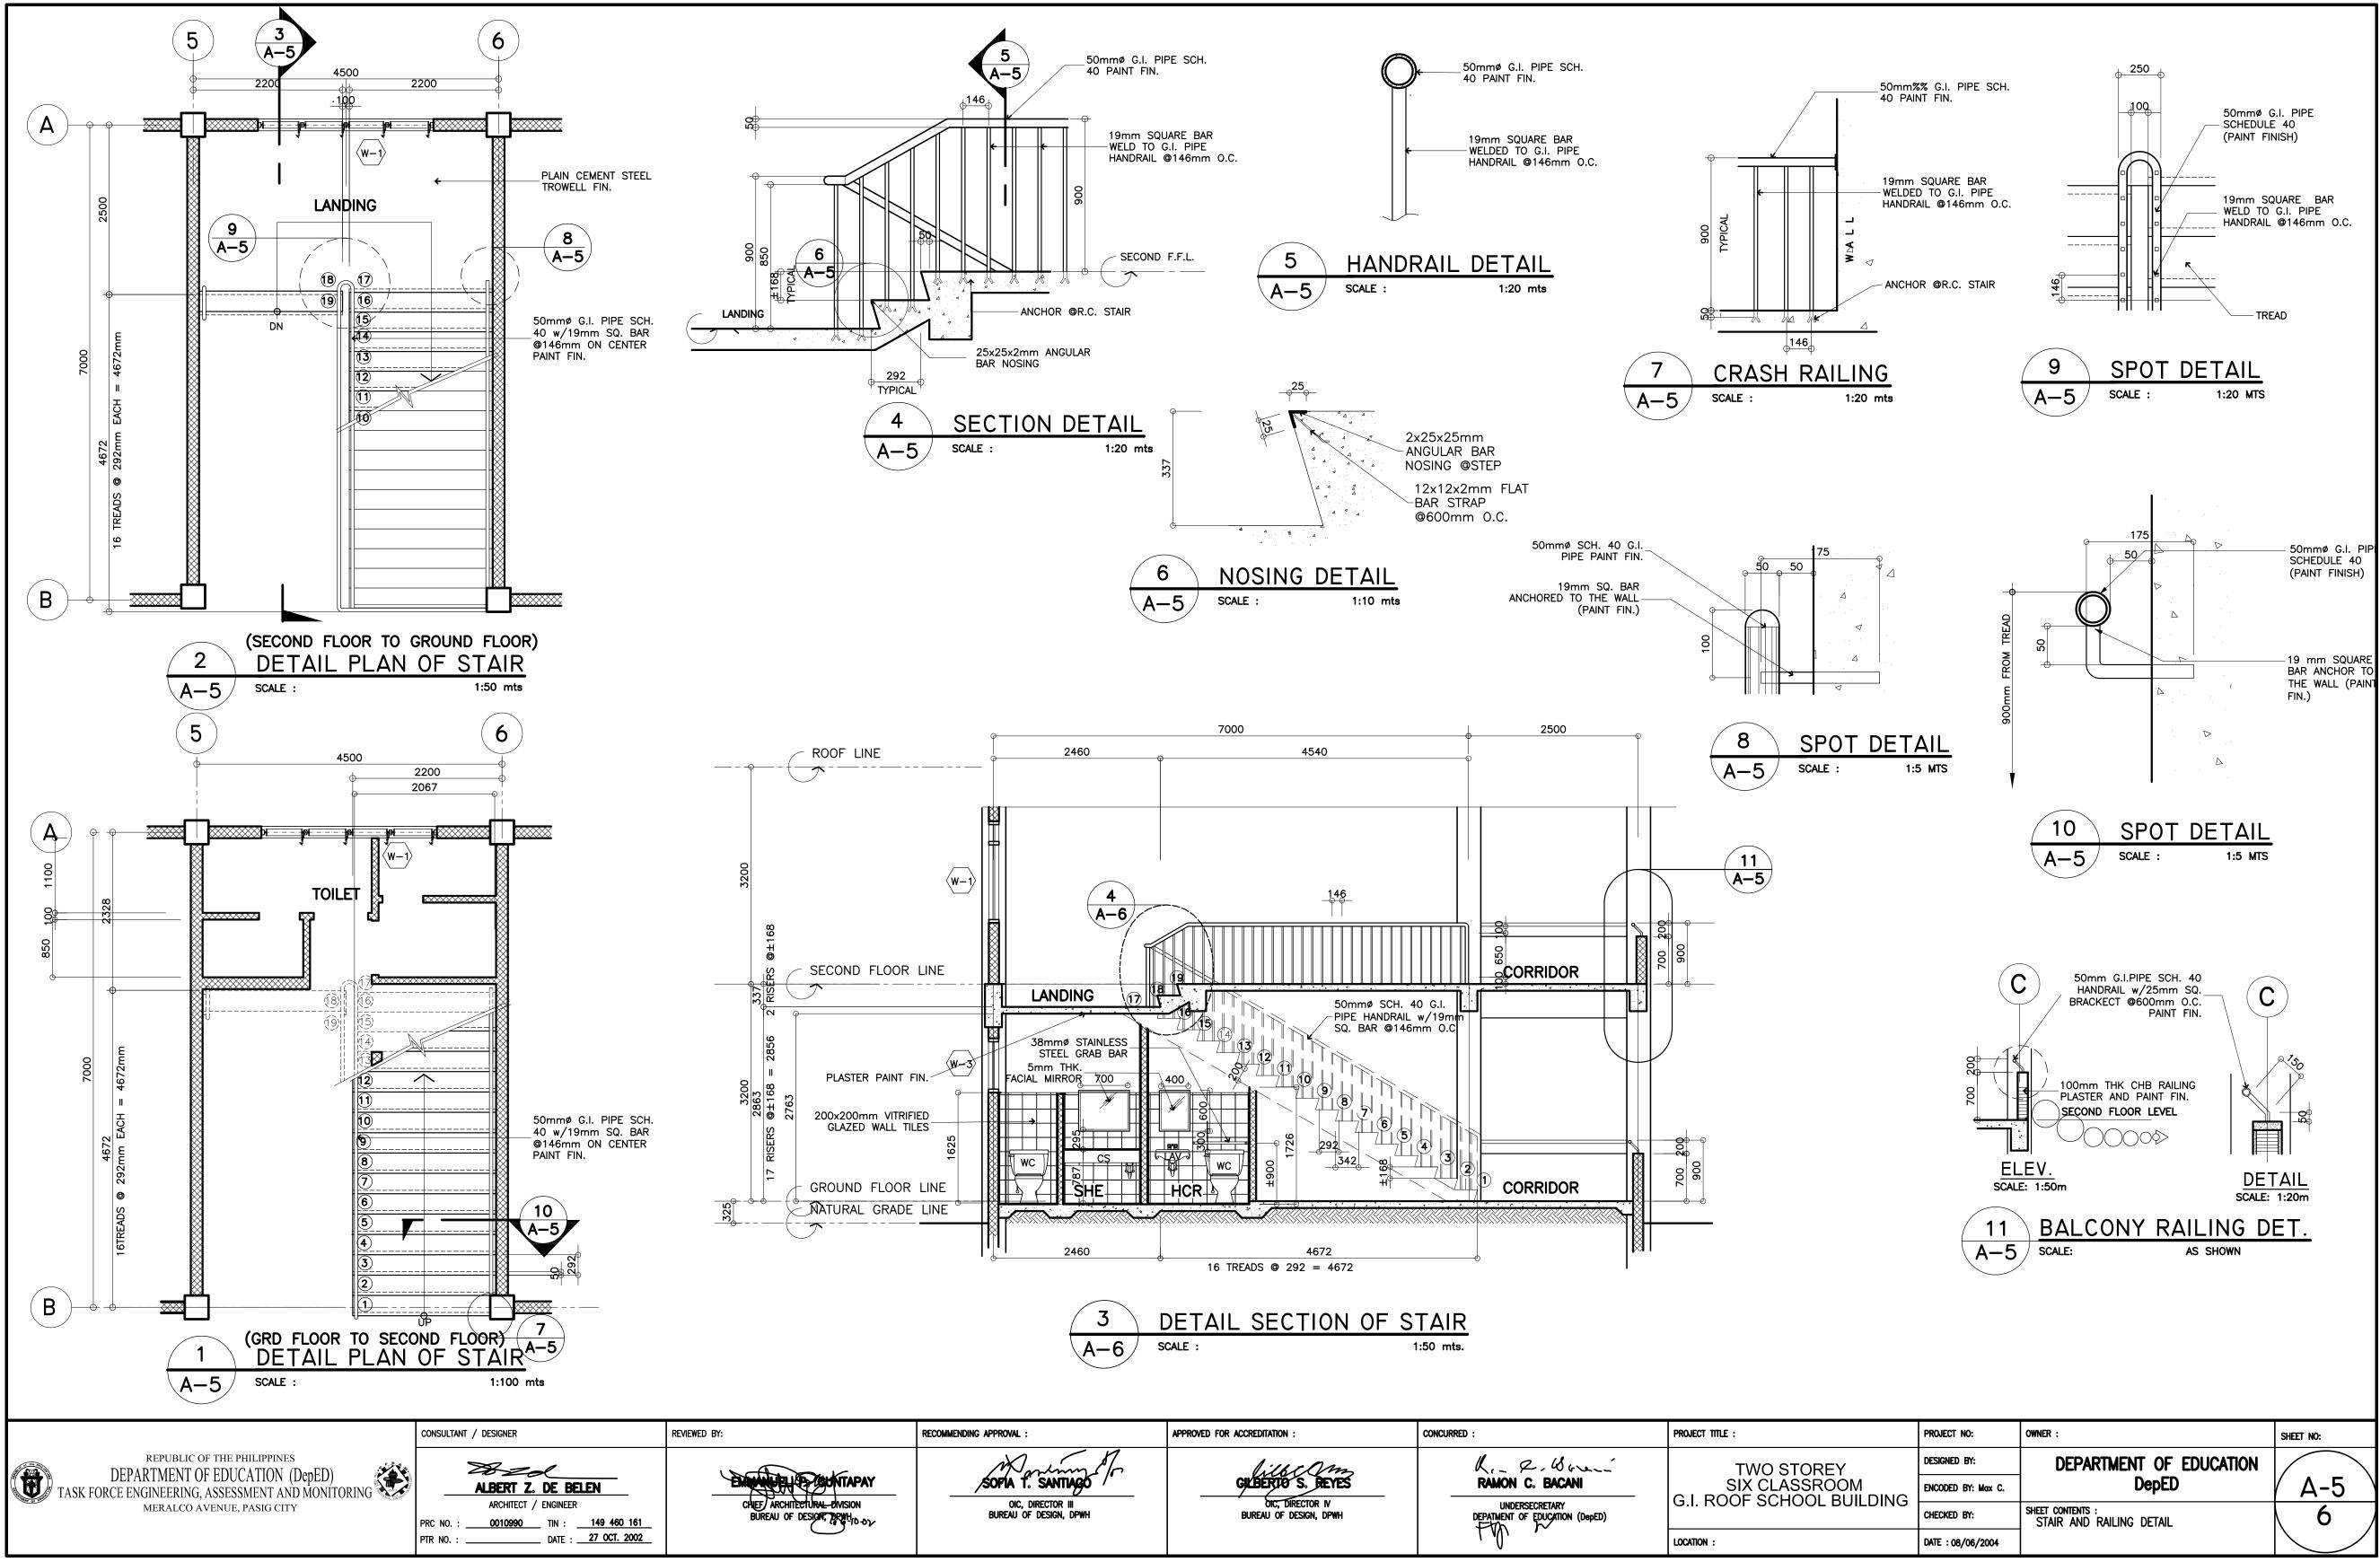

### B 2ND FLOOR FRAMING PLAN S-1 | SCALE : 1:100 M.


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JNDATION D FLOOR PLAN	
AN INSTRUMENT OF SERVICE IS THE PROPERTY OF TASK FORCE EN	GINEERING, ASSESSMENT AND

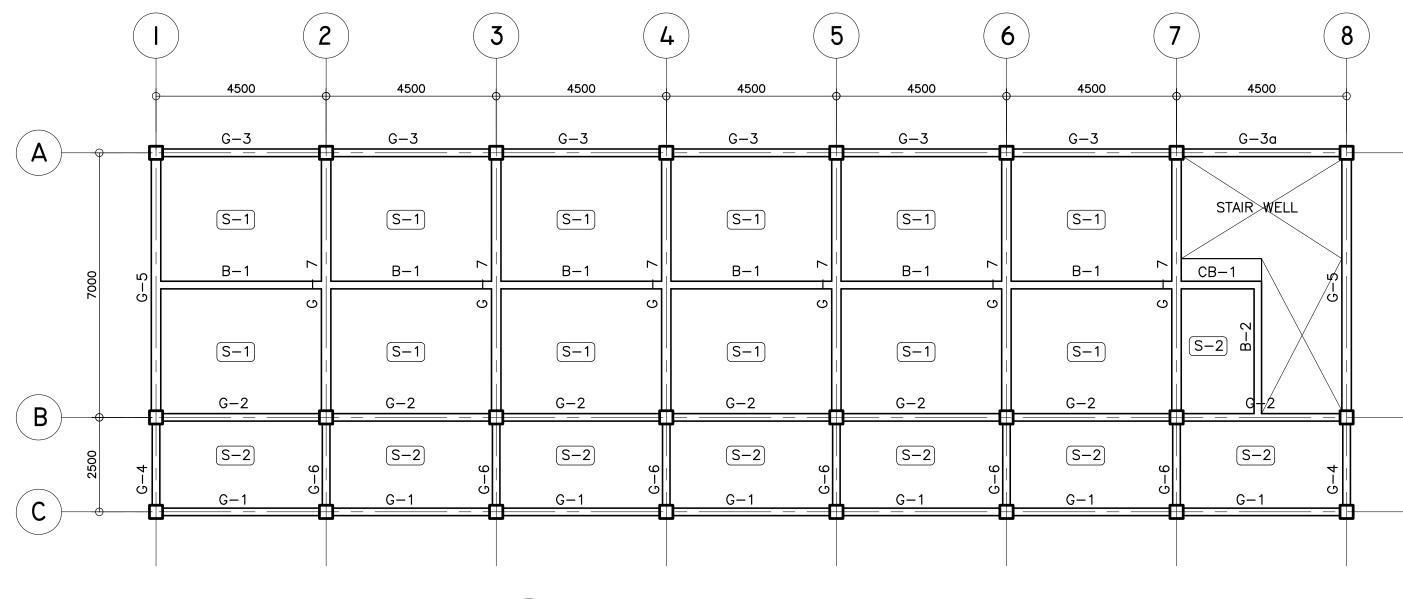

Ø12mm CROSS BRACINGS



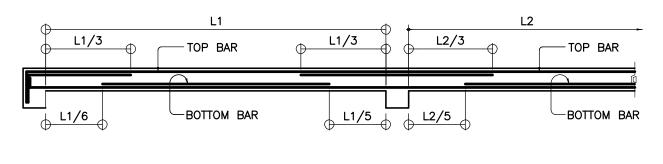

			000	-	CH		-				_ A						
FLOOR LEVEL	SLAB MARK	THICK- NESS	REBAR		ACING /	MIDS				REBAR			MIDS			SUPPORT	REMARKS
		in mm	SIZE	ТОР	BOTT.	TOP	BOTT.	TOP	BOTT.	SIZE	ТОР	BOTT.	TOP	BOTT.	TOP	BOTT.	
VEL																	
	S–1	100	10ø	200	300	-	300	200	300	10ø	250	300	-	300	250	300	TWO-WAY
LE	S-2	100	10ø	300	300	-	300	300	300	10ø	300	300	-	300	300	300	TWO-WAY
, ,																	

	Consultant / Designer	REVIEWED BY:	RECOMMENDING
REPUBLIC OF THE PHILIPPINES DEPARTMENT OF EDUCATION (DepED) TASK FORCE ENGINEERING, ASSESSMENT AND MONITORING MERALCO AVENUE, PASIG CITY	ANTONIA M. MANIO CML ENGINEER PRC NO. : TIN : PTR NO. : DATE :	WILFREDO S. LOPEZ OIC, STRUCTURAL DIVISION BUREAU OF DESIGN, DPWH	

4500	4 4500	5 4500	6 4500	<b>7 8 4500</b>
	RG-1	RG-1	RG-1	
	RG - 1 RG - 1 RG - 1		RG-2	
RG-1	RG-1 		RG-1	
	LC-120x40x20x2.0 P - SPACED © 750 mm WITH Ø10 SAGRODS @	0.C		


SCALE :

ROOF DECK FRAMING PLAN 1:100 M.



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	Dic, Director IV Bureau of Design, DPWH	DEPATIMENT OF EDUCATION (DepED)		CHECKED BY:	SHEET
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OF DECK FRAMING PLAN HEDULE OF SLAB	

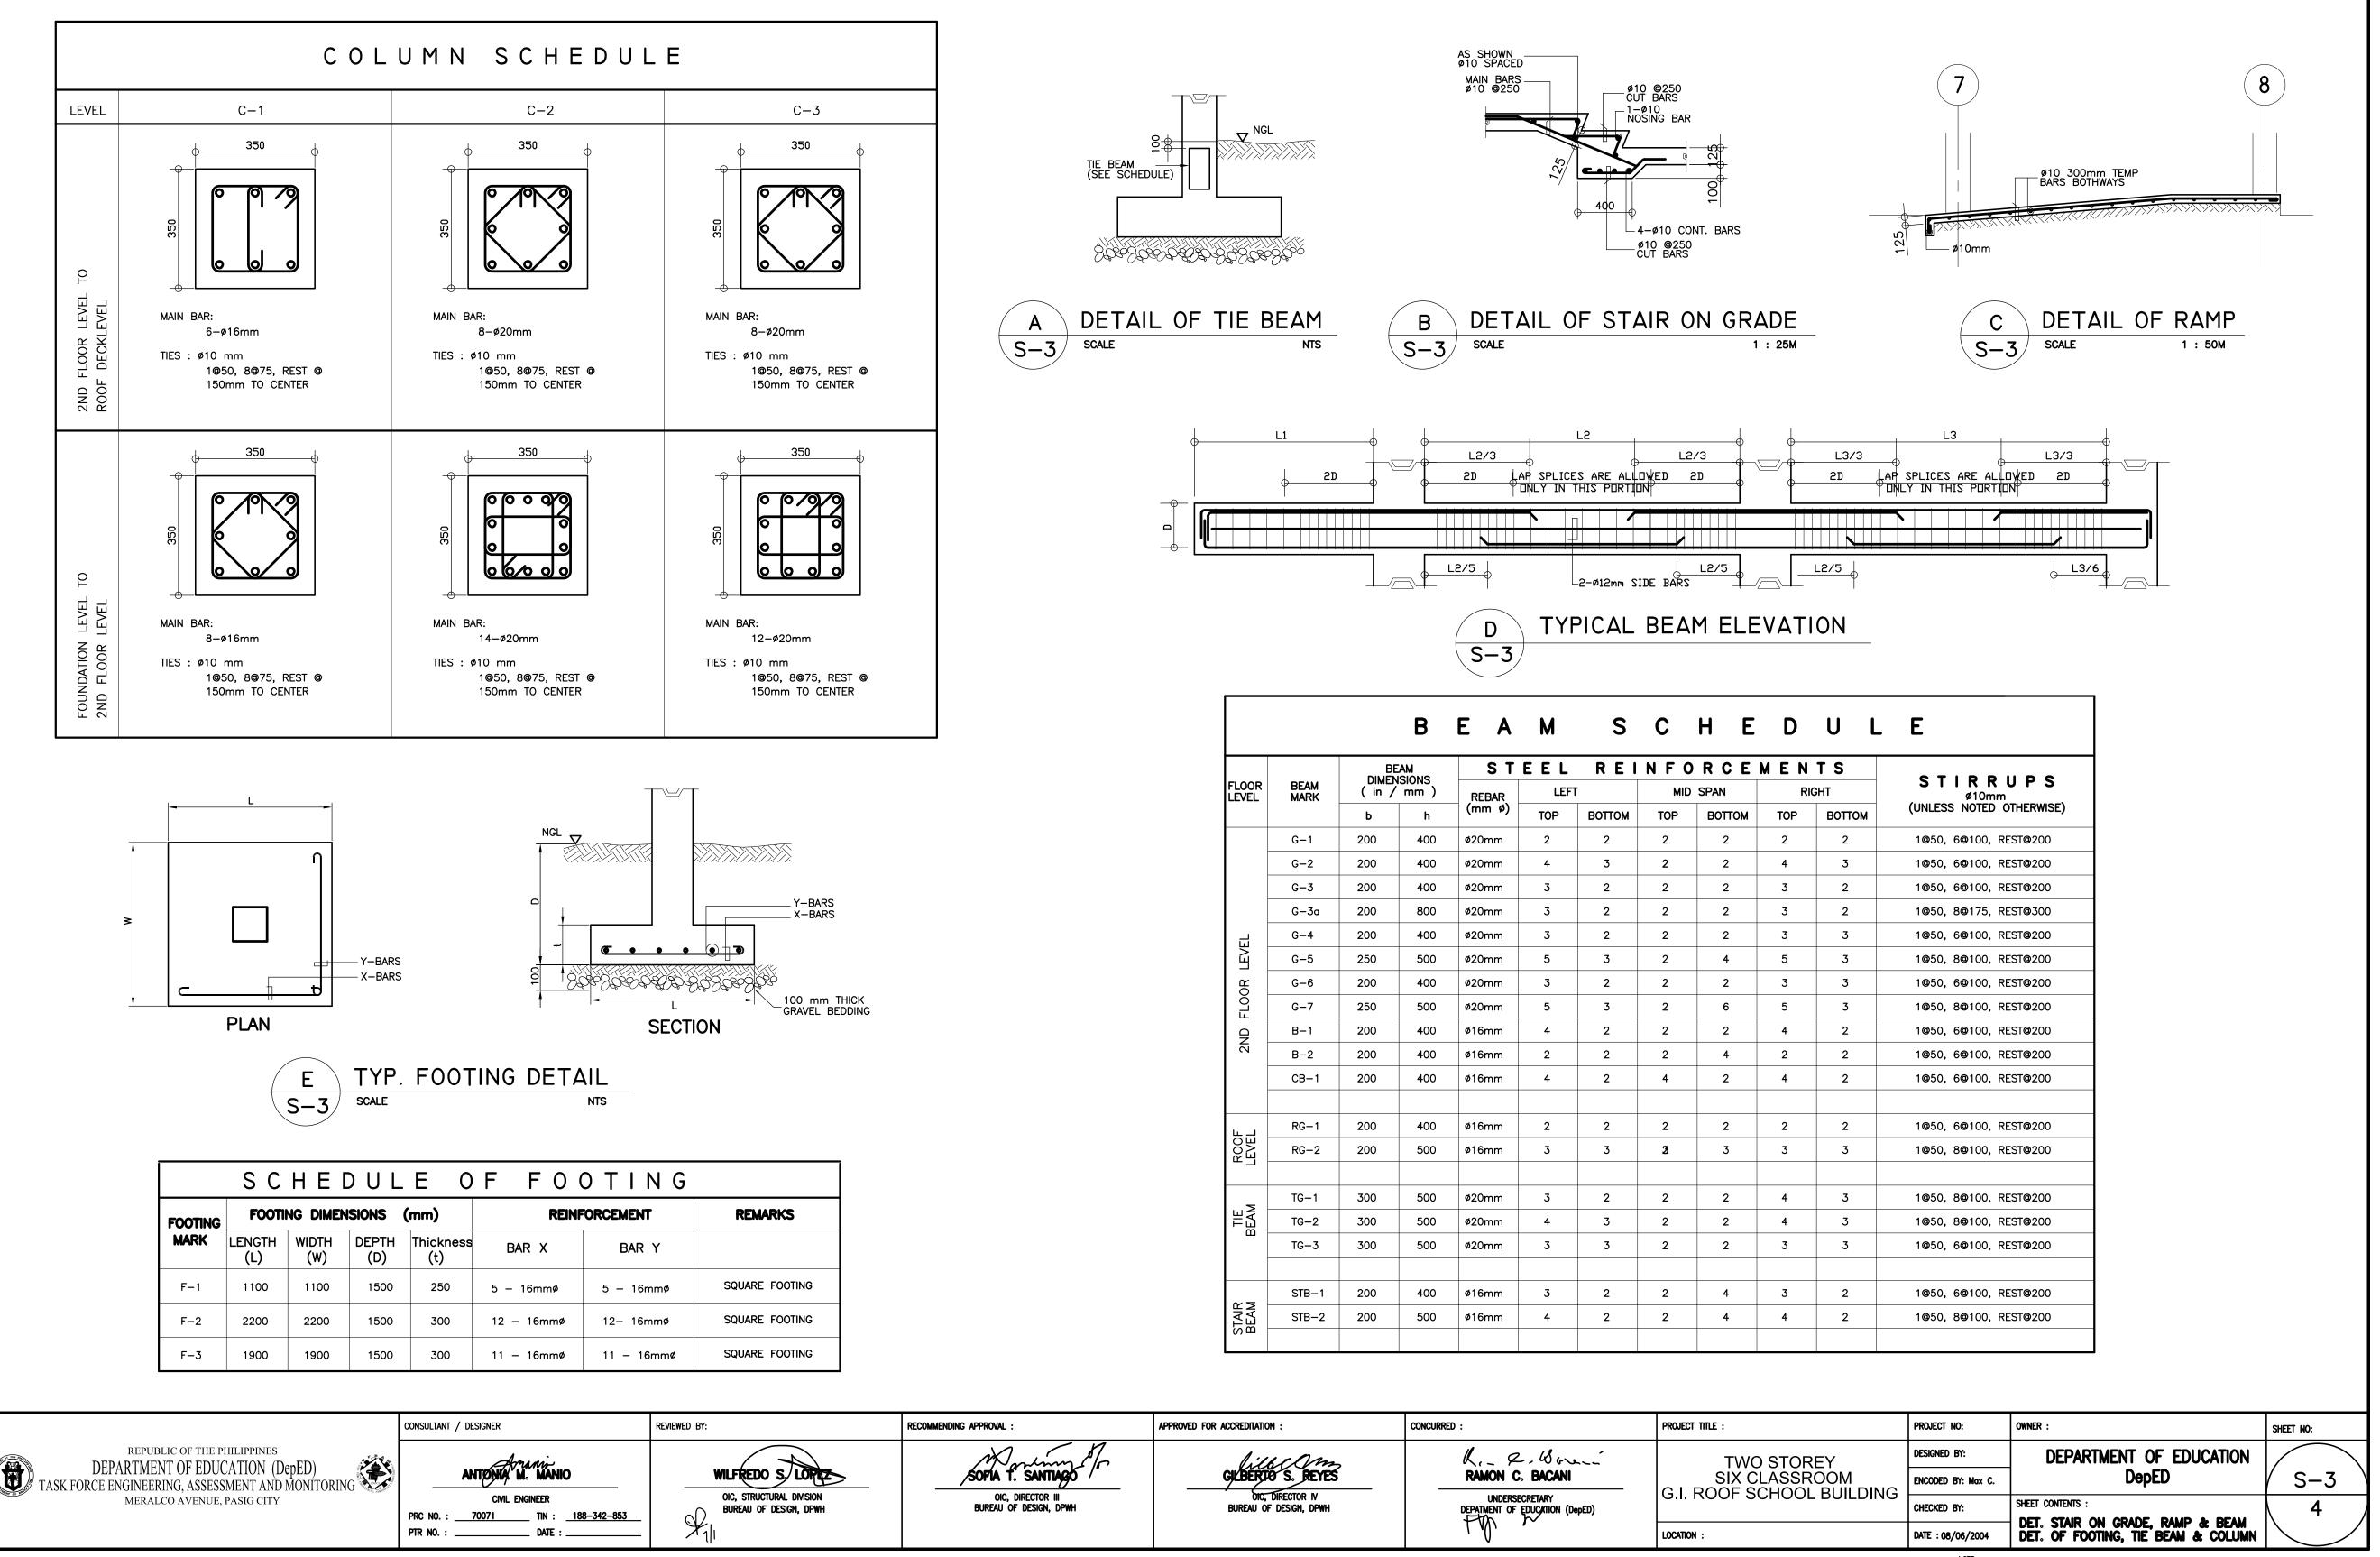


REPUBLIC OF THE PHILIPPINES DEPARTMENT OF EDUCATION (DepED) TASK FORCE ENGINEERING, ASSESSMENT AND MONITORING	ANTONIA M. MANIO	WILFREDO S LOF
MERALCO AVENUE, PASIG CITY	CIVIL ENGINEER	OIC, STRUCTURAL DIVISIO
	PRC NO. :	BUREAU OF DESIGN, DP

		BI		S T	EEL	REI	NFO	RCE	MEN	TS	
FLOOR LEVEL	BEAM MARK	( in /	NSIONS ′mm)	REBAR	LEFT		MID	SPAN	RIC	GHT	STIRRUPS ø10mm
		b	h	(mm ø)	TOP	воттом	TOP	воттом	TOP	воттом	(UNLESS NOTED OTHERWIS
	G-1	200	400	ø20mm	2	2	2	2	2	2	1@50, 6@100, REST@200
	G-2	200	400	ø20mm	4	3	2	2	4	3	1@50, 6@100, REST@200
	G-3	200	400	ø20mm	3	2	2	2	3	2	1@50, 6@100, REST@200
	G-3a	200	800	ø20mm	3	2	2	2	3	2	1@50, 8@175, REST@300
	G-4	200	400	ø20mm	3	2	2	2	3	3	1@50, 6@100, REST@200
LEVEL	G-5	250	500	ø20mm	5	3	2	4	5	3	1@50, 8@100, REST@200
	G-6	200	400	ø20mm	3	2	2	2	3	3	1@50, 6@100, REST@200
FLOOR	G-7	250	500	ø20mm	5	3	2	6	5	3	1@50, 8@100, REST@200
2ND F	B-1	200	400	ø16mm	4	2	2	2	4	2	1@50, 6@100, REST@200
2	B-2	200	400	ø16mm	2	2	2	4	2	2	1@50, 6@100, REST@200
	CB-1	200	400	ø16mm	4	2	4	2	4	2	1@50, 6@100, REST@200
	RG-1	200	400	ø16mm	2	2	2	2	2	2	1@50, 6@100, REST@200
ROOF	RG-2	200	500	ø16mm	3	3	3	3	3	3	1@50, 8@100, REST@200
	TG-1	300	500	ø20mm	3	2	2	2	4	3	1@50, 8@100, REST@200
BEAM	TG-2	300	500	ø20mm	4	3	2	2	4	3	1@50, 8@100, REST@200
ш –	TG-3	300	500	ø20mm	3	3	2	2	3	3	1@50, 6@100, REST@200
	STB-1	200	400	ø16mm	3	2	2	4	3	2	1@50, 6@100, REST@200
STAIR BEAM	STB-2	200	500	ø16mm	4	2	2	4	4	2	1@50, 8@100, REST@200

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sopia t. santiago /	GILBERTO S. REYES	RAMON C. BACANI	SIX CLASSROOM	ENCODED BY: Max C.	
oic, director III Bureau of Design, dpwh	OTC, DIRECTOR IV BUREAU OF DESIGN, DPWH	DEPATMENT OF EDUCATION (DepED)		CHECKED BY:	Sheet C
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ŚOPIA 1. SANTIAGO /	GILBERTO S. REYES	RAMON C. BACANI	SIX CLASSROOM G.I. ROOF SCHOOL BUILDING	ENCODED BY: Max C.	
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GENE	RAL NOTES		LEC	GEND
THESE OF THE THE RU AND TH THE ELI	CTRICAL WORKS SHALL COMPLY IN ACCOR PLANS AND SPECIFICATIONS. THE APPLICA LATEST EDITION OF THE PHILIPPINE ELEC LES AND REGULATION OF THE LOCAL ENFO E REQUIREMENTS OF THE LOCAL POWER OF CTRICAL WORKS SHALL BE UNDER IMMEDI JLY REGISTERED ELECTRICAL ENGINEER.	BLE PROVISIONS IRICAL CODE (PEC). DRCING AUTHORITY COMPANY.	SYMBOL C S/Sa Sab	DESCRIPTION - CEILING LIG - 2 × 40 WA - CEILING FA - ONE GANG - TWO GANG
2. THE ELI	CTRICAL SERVICE POWER IS 1-PHASE, 2- AC, 60 Hz.	WIRE,	Scde S3W	- THREE GAN - THREE WAY
a. FEED b. LIGH	METHOD SHALL BE AS FOLLOWS : ERS AND RISERS - INTERMEDIATE N TING, POWER RECEPTACLE - POLYVINYL (		Sf Sef	- FAN CONTR - EXHAUST F - RACEWAY (
4. ALL WIF "THW" SIZE OF 3.5mm <sup>2</sup>	CKT., & AUXILIARY SCH. 40 ES SHALL BE COPPER AND THERMOPLAST JNLESS OTHERWISE INDICATED IN THE PLA WIRE FOR POWER AND LIGHTING CIRCUIT AND INSULATED FOR 600 VOLTS. SMALLES MD TRADE/NOMINAL SIZE.	N. THE MINIMUM HOMERUN SHALL BE		- RACEWAY ( - PANELBOAR - CKT. BREAR - DUPLEX CC
5. ALL OU	TLET BOXES SHALL BE GALVANIZED GAUGI TH FACTORY KNOCKOUTS.	NO. 16 DEEP	⇒ <sub>EF</sub>	10 AMPS, 2 — EXHAUST F
	TERIALS TO BE USED SHALL BE BRAND N OR THE PARTICULAR LOCATION AND PURPO			10 AMPS, 2 — HOMERUN
	ING SYSTEM SHALL BE PROVIDED TO ALL CIRCUIT AS PER PHILIPPINE ELECTRICAL C			- PUSH BUT - ENCLOSED
a. LIGH b. CON	NG HEIGHT OF WIRING DEVICES SHALL BE T SWITCH - 1.20 M ABOV VENIENCE OUTLET - 0.30 M ABOV CLBOARD - 1.50 M ABOV	E FINISH FLOOR Æ FINISH FLOOR.	⊾ ⊑  © 	<ul> <li>FIRE ALARN</li> <li>FIRE ALARN</li> <li>VIBRATING</li> <li>FIRE ALARN</li> <li>SERVICE MINUTE</li> </ul>
	ALARM STATION OUTLET – 1.50 M. ABC H BUTTON OUTLET – 1.20 M ABC			- SERVICE EI
f. FIRE	ALARM & VIBRATING BELL - 0.30 M BE	LOW CEILING LINE	PANEL LP	———100AT, 100AF, 2P,
				#8mm <sup>2</sup> BARE COF
			SINGLE LIN	_
	CONSULTANT / DESIGNER	REVIEWED BY:		SCALE
REPUBLIC OF THE DEPARTMENT OF EDU TASK FORCE ENGINEERING, ASSES MERALCO AVENUE	HILIPPINES CATION (DepED) SMENT AND MONITORING	HAGUN FE M.	LECTRICAL DIVISION OF DESIGN, DPW/Jhder	SOPIA T. SANTIAGO OIC, DIRECTOR III BUREAU OF DESIGN, DPWH

# ND
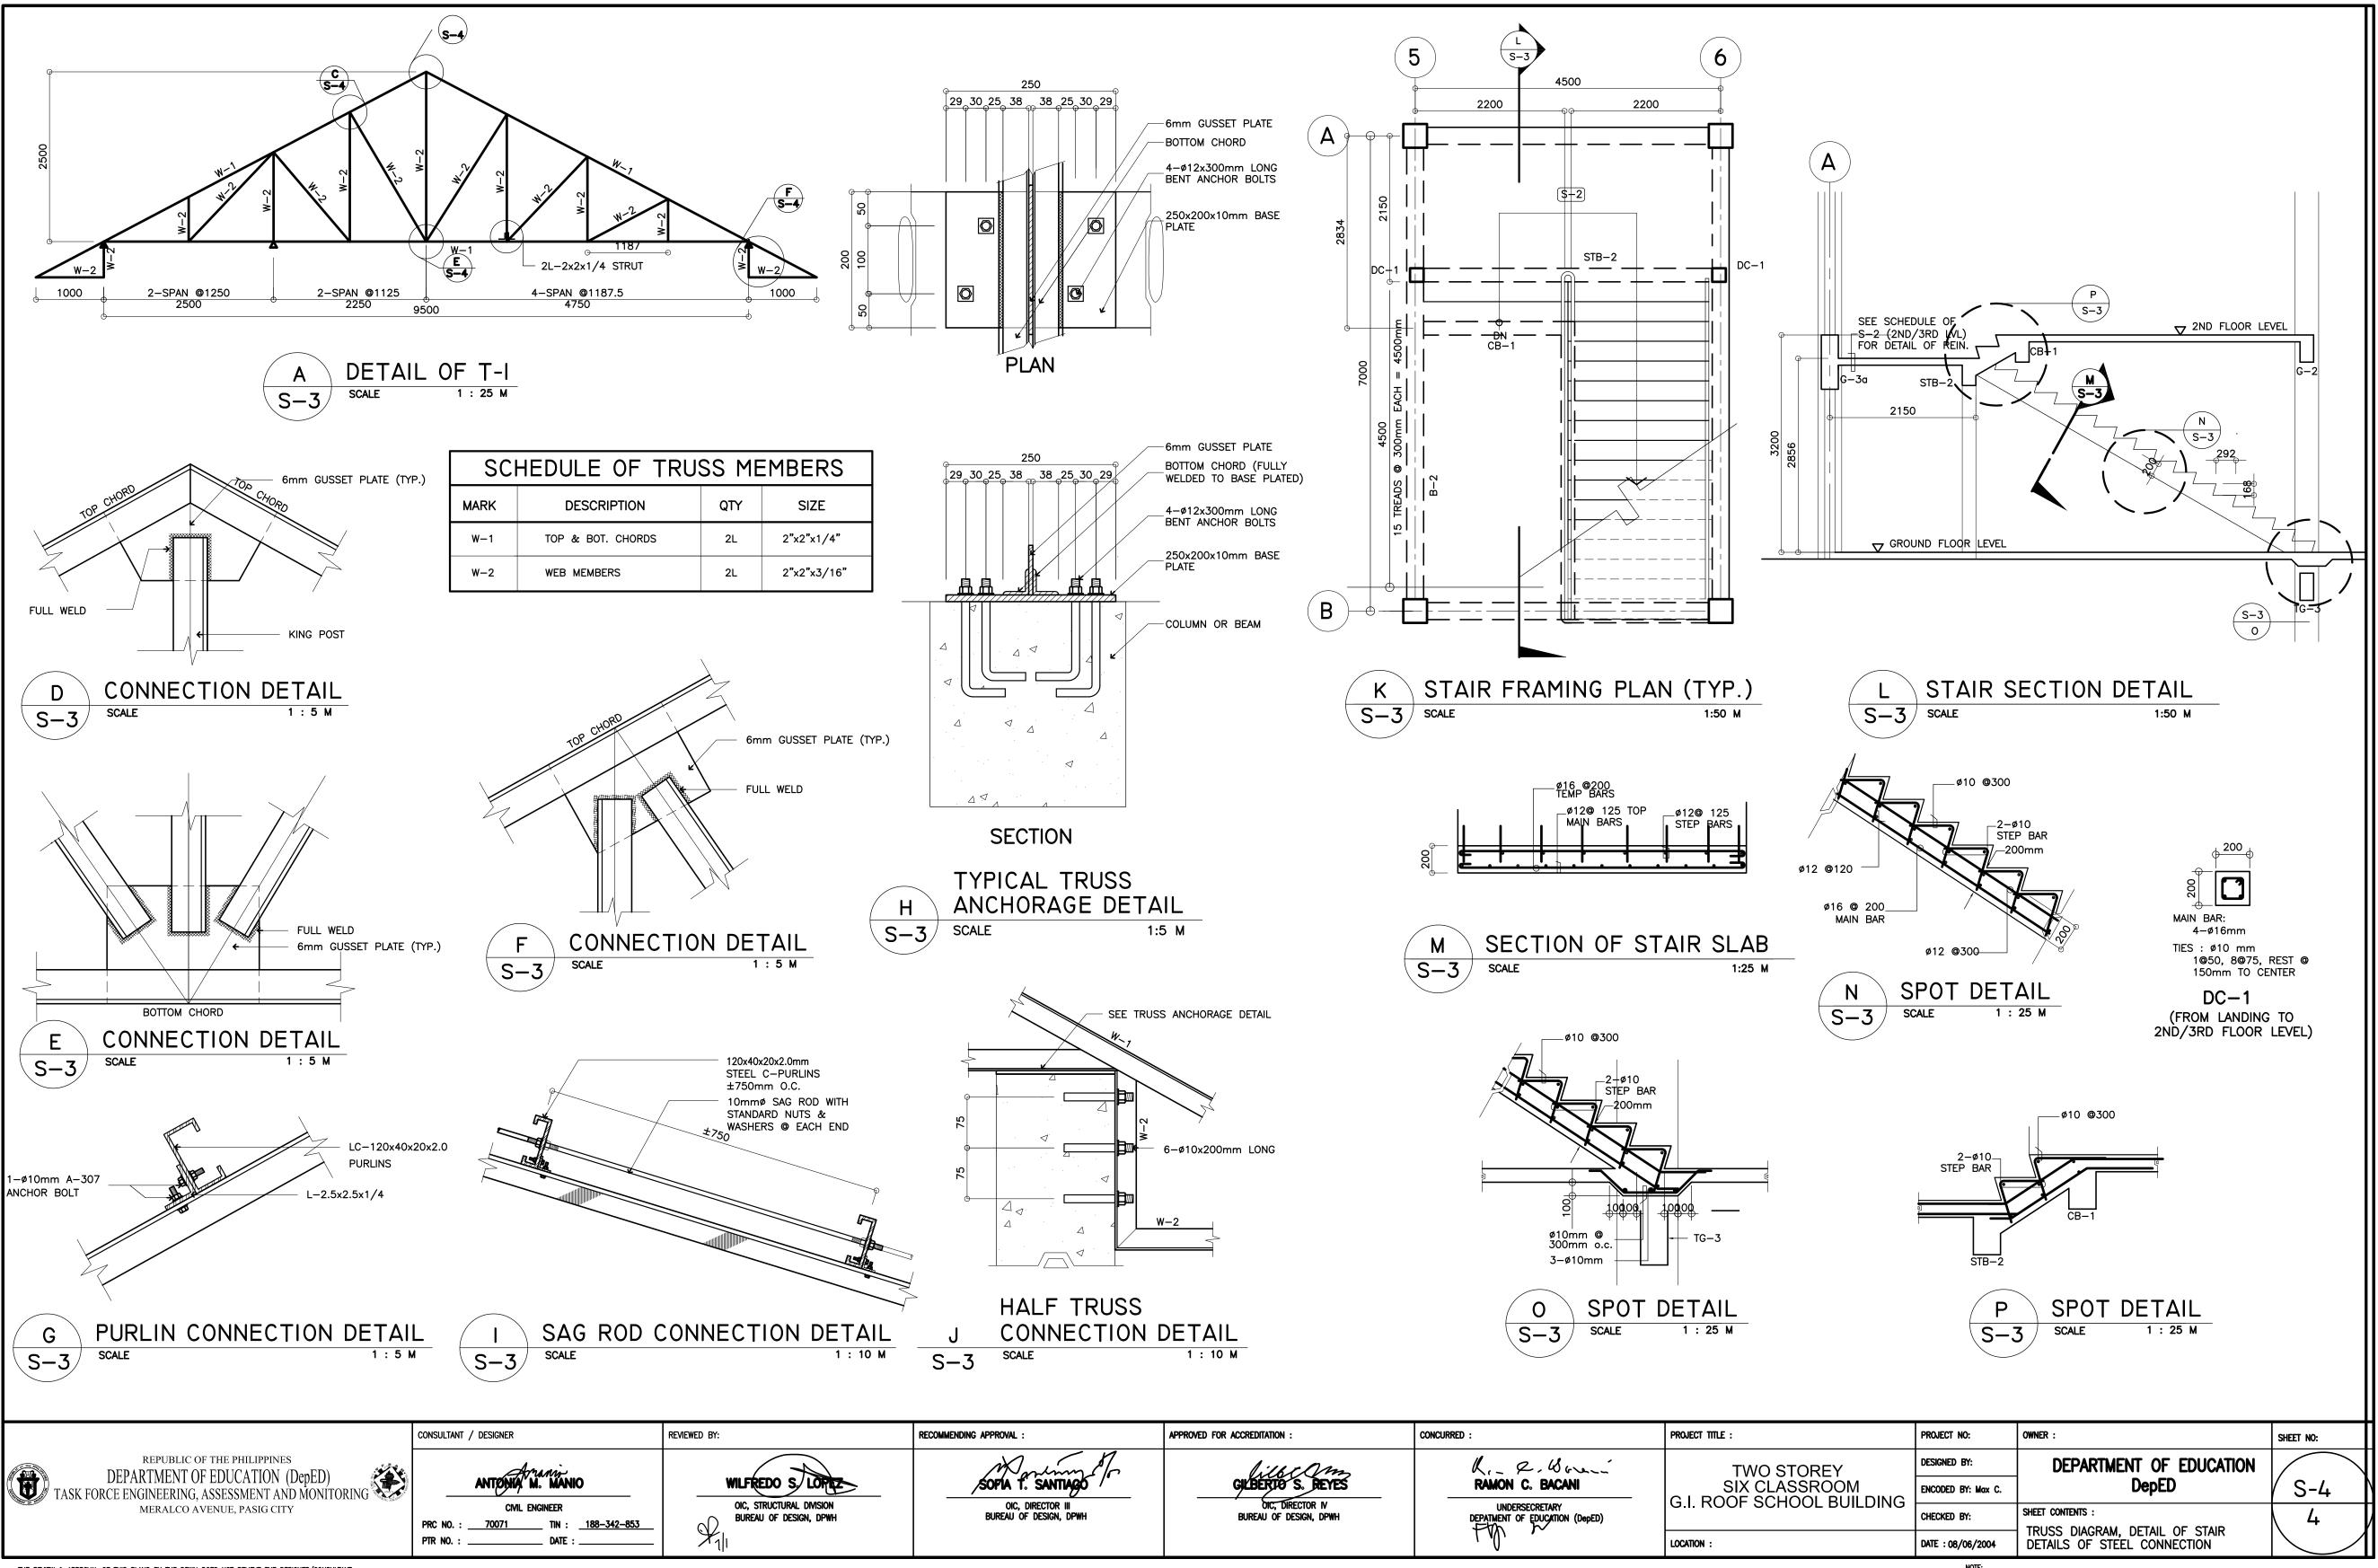
### DESCRIPTION


- CEILING LIGHT OUTLET
- 2 x 40 WATTS FLUORESCENT LAMP
- CEILING FAN OUTLET
- ONE GANG DEVICE SWITCH
- TWO GANG DEVICE SWITCH
- THREE GANG DEVICE SWITCH
- THREE WAY DEVICE SWITCH
- FAN CONTROL SWITCH
- EXHAUST FAN SWITCH
- RACEWAY CONDUIT CONCEALED IN CEILING
- RACEWAY CONDUIT CONCEALED UNDER FLOOR
- PANELBOARD
- CKT. BREAKER, RATING AS INDICATED
- DUPLEX CONVENIENCE OUTLET, GROUNDING TYPE 10 AMPS, 250 VOLT WITH MODERN PLATE COVER - EXHAUST FAN OUTLET, SINGLE, GROUNDING TYPE
- 10 AMPS, 250 VOLT WITH MODERN PLATE COVER
- HOMERUN DIRECT TO PANELBOARD
- PUSH BUTTON
- ENCLOSED AIR CIRCUIT BREAKER
- FIRE ALARM CONTROL PANEL
- FIRE ALARM STATION OUTLET
- VIBRATING BELL OUTLET
- FIRE ALARM BELL
- SERVICE METER

# LOAD SCHEDULE

PANE	ELBOARD: LP					N	AIN :
СКТ.		VA	CIR	CUIT E	BREAK	ER	WIF
NO.	DESCRIPTION	LOAD	VOLT	POLE	AT	AF	VVIT
1	CONV. OUTLET - 9 x 180W	1620	230	2	20	50	3-3.
2	CONV. OUTLET - 9 x 180W	1620	230	2	20	50	3-3.
3	LIGHT OUTLET - 7 x 100W EXHAUST FAN OUTLET - 1 x 180W	880	230	2	20	50	3-3.
4	LIGHT OUTLET - 15 x 100W	1500	230	2	20	50	3-3.
5	LIGHT OUTLET - 10 x 100W	1000	230	2	20	50	3-3.
6	LIGHT OUTLET - 10 x 100W	1000	230	2	20	50	3–3.
7	SPARE	1500	230	2	20	50	
8	SPARE	1500	230	2	20	50	
	TOTAL	10620					

IL @ 80% D.F. =  $10620 \times 80\%$  x 1.25 = 46.2 A 230 V

FEEDER: 2–30mm<sup>2</sup> THW IN 32mmØC PROTECTION: 100 AT, 100 AF, 2P, 230 V

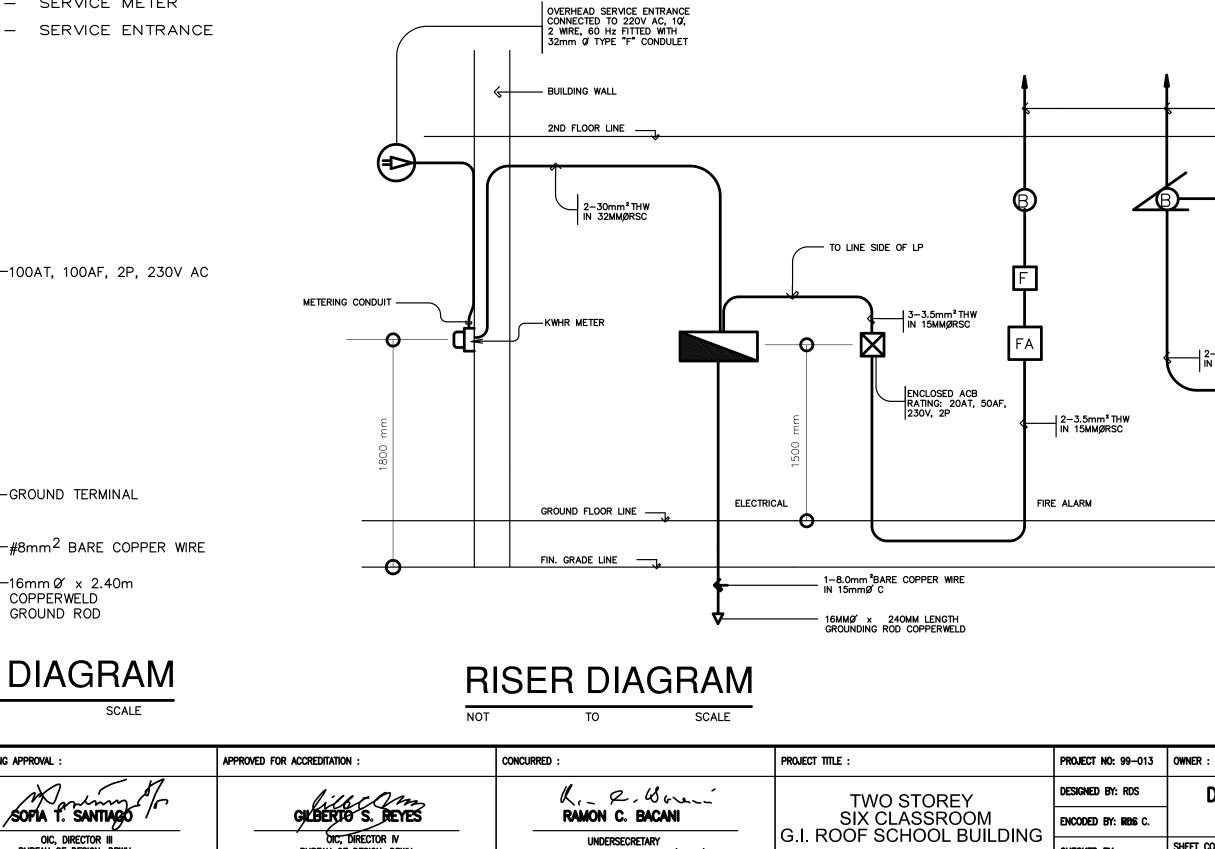

RAMON C. BACANI

UNDERSECRETARY

DEPATMENT OF EDUCATION (DepED)

LOCATION :


OIC, DIRECTOR IV

BUREAU OF DESIGN, DPWH


ENCODED BY: RDS C.

DATE :5085<del>/0</del>69/2004

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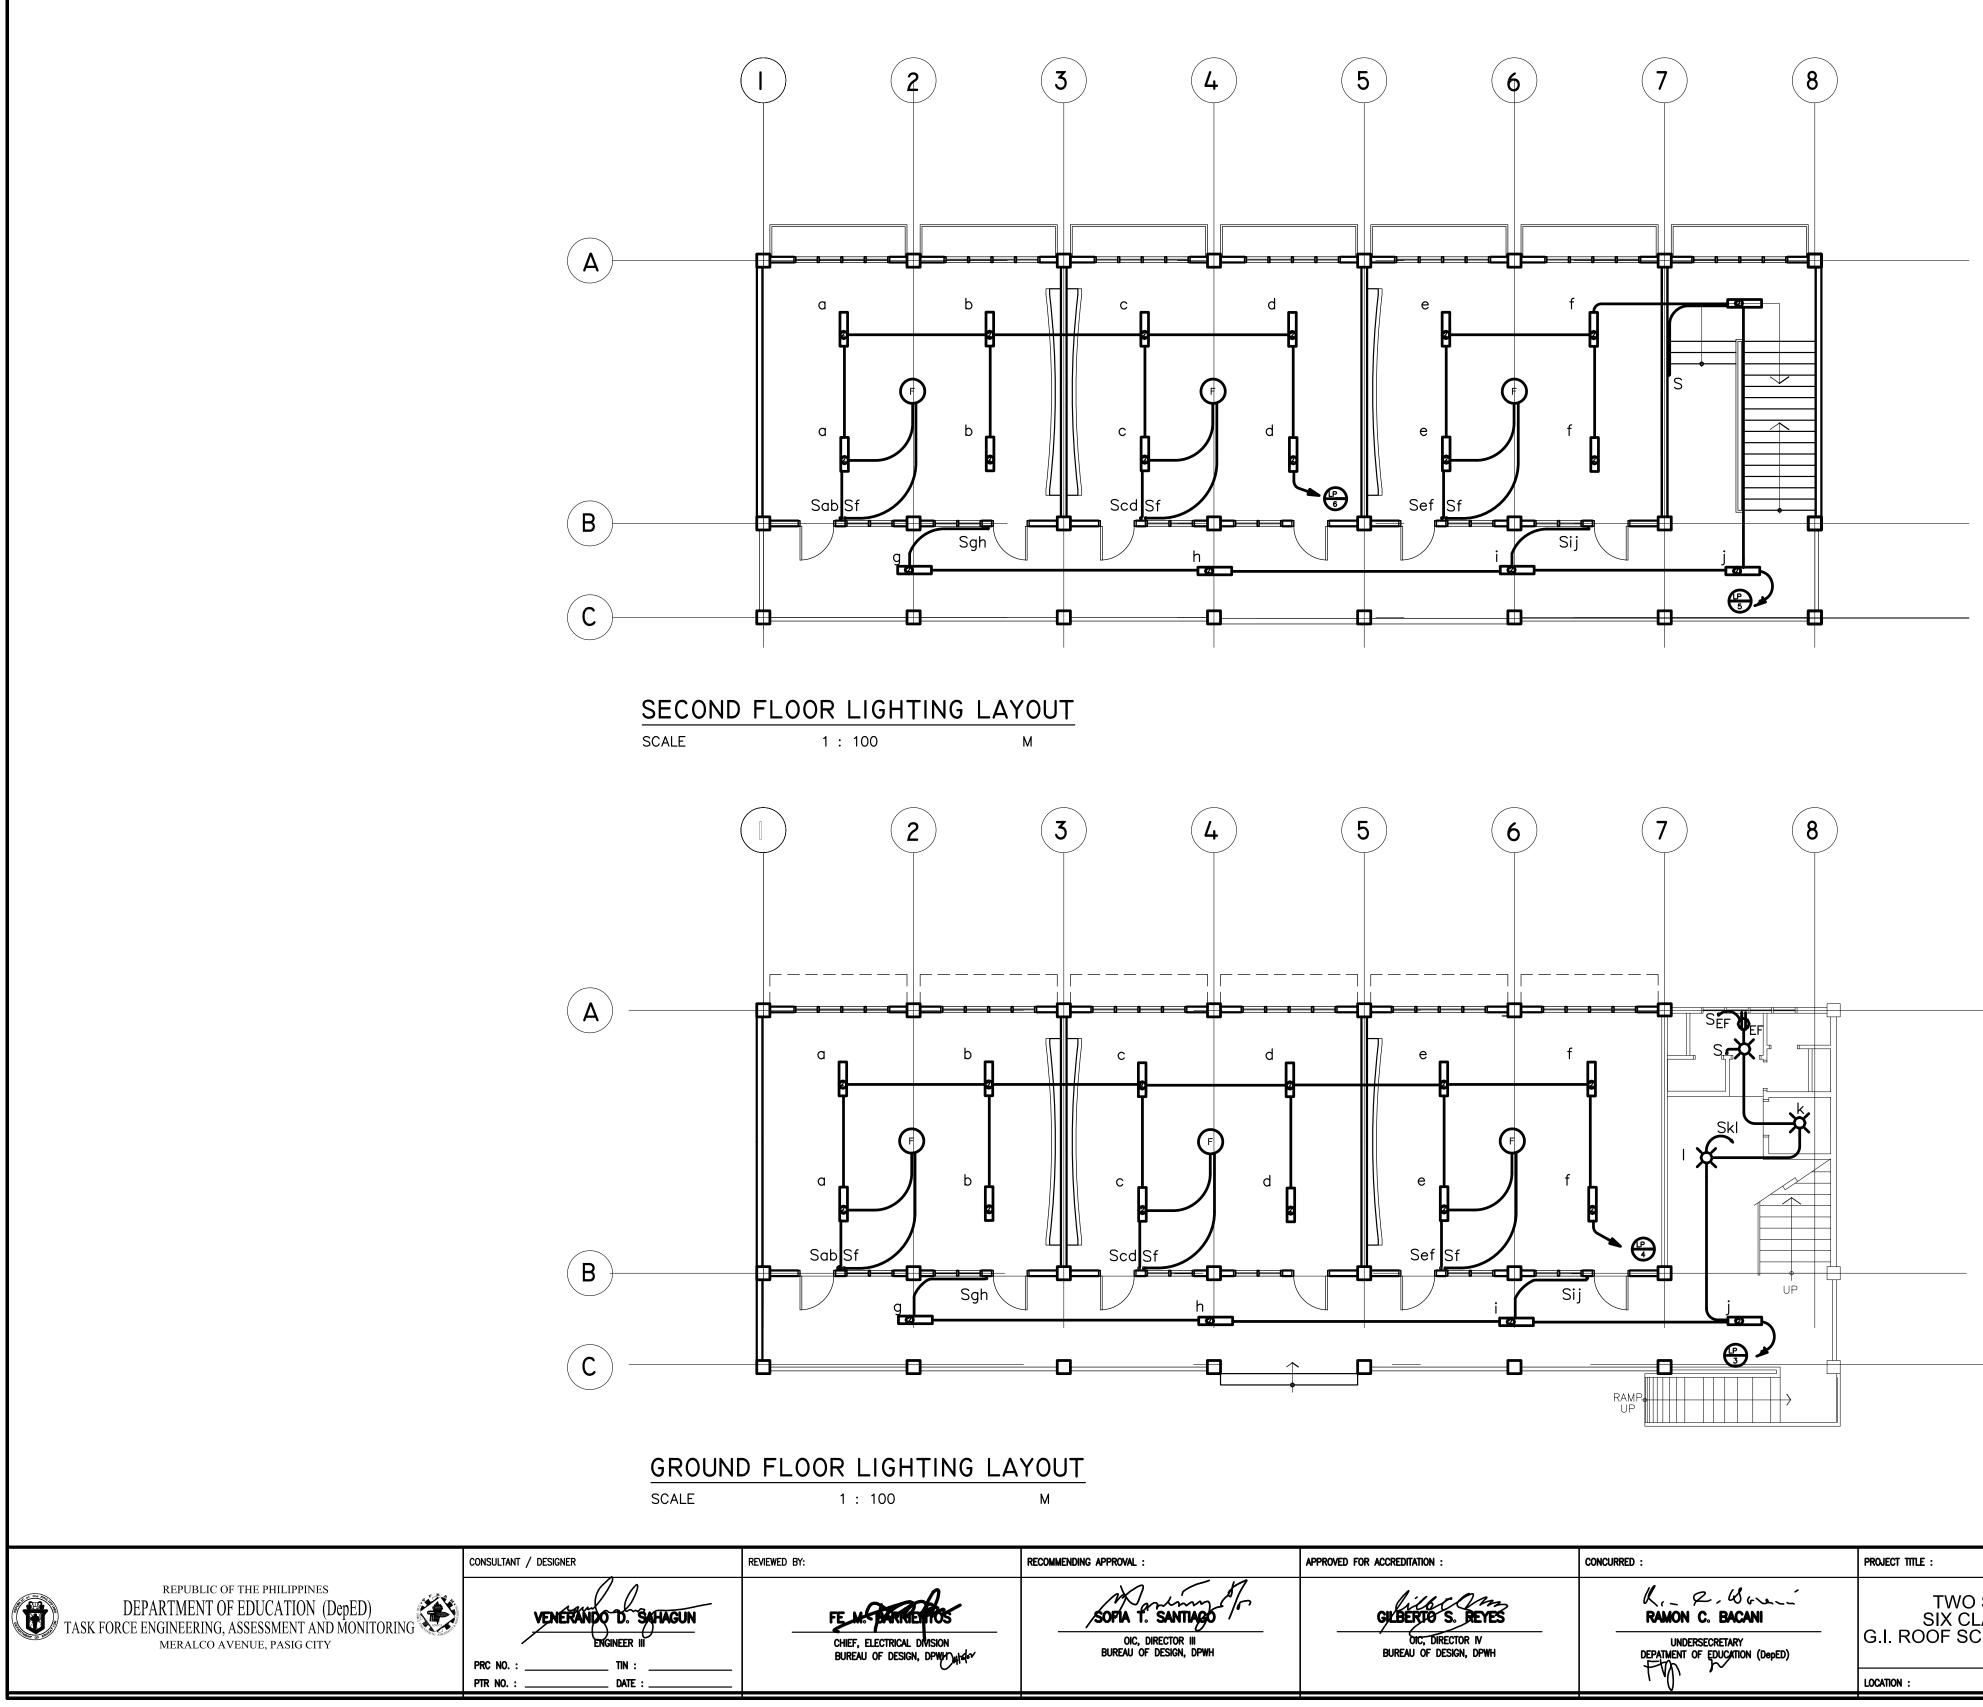

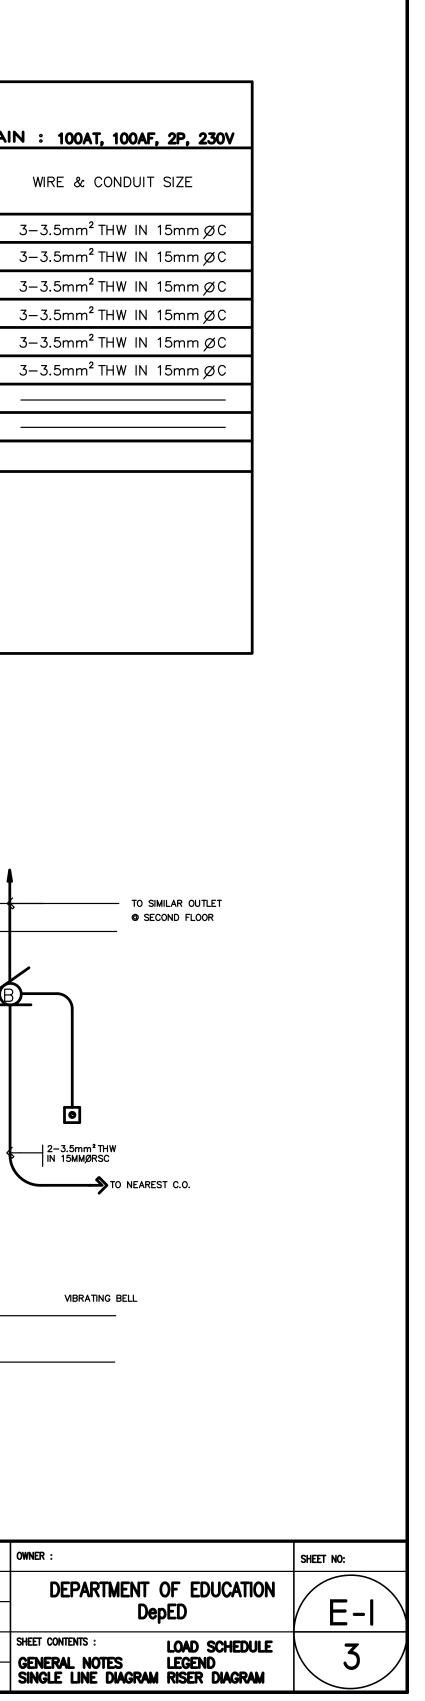
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sopia të santiago /*	GILBERTO S. REYES	RAMON C. BACANI		encocceleredybyrdigax C.	
OIC, DIRECTOR III BUREAU OF DESIGN, DPWH	dic, director IV Bureau of Design, DPWH	DEPATMENT OF EDUCATION (DepED)		Chenerene en de la company	SHEET C
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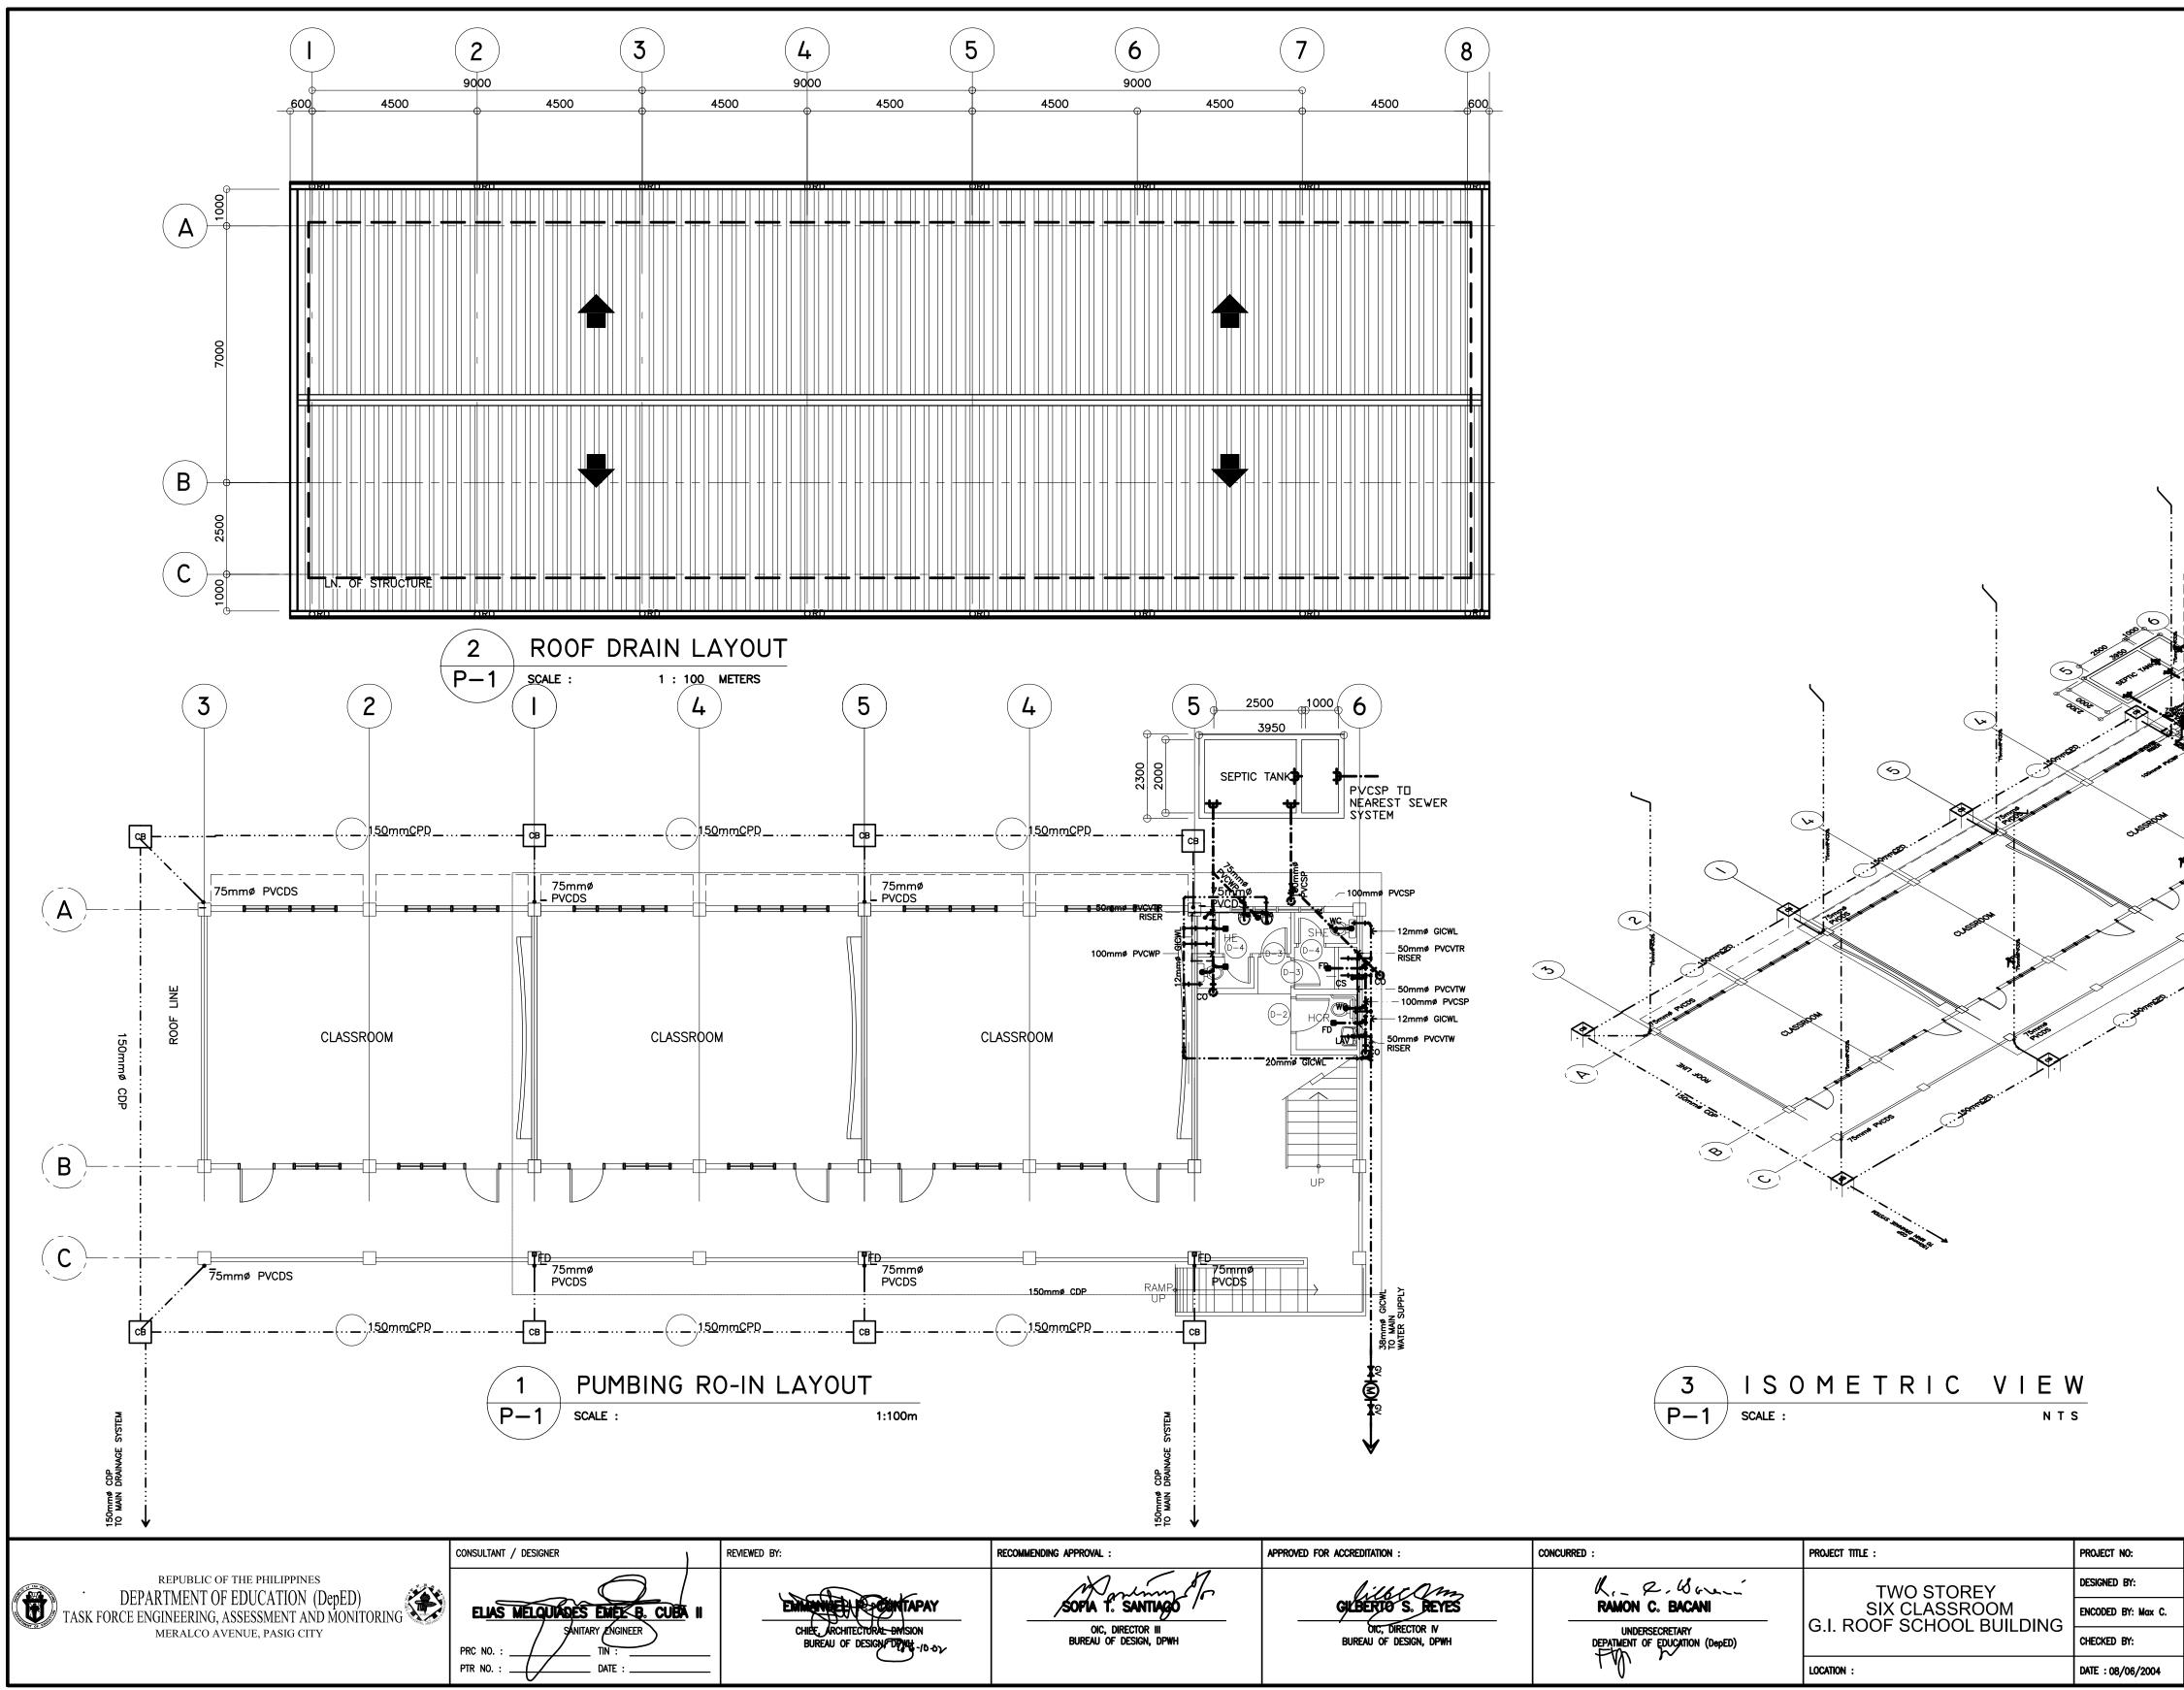
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CONTENTS : ND FLOOR POWER LAYOUT ND FLOOR POWER LAYOUT	3

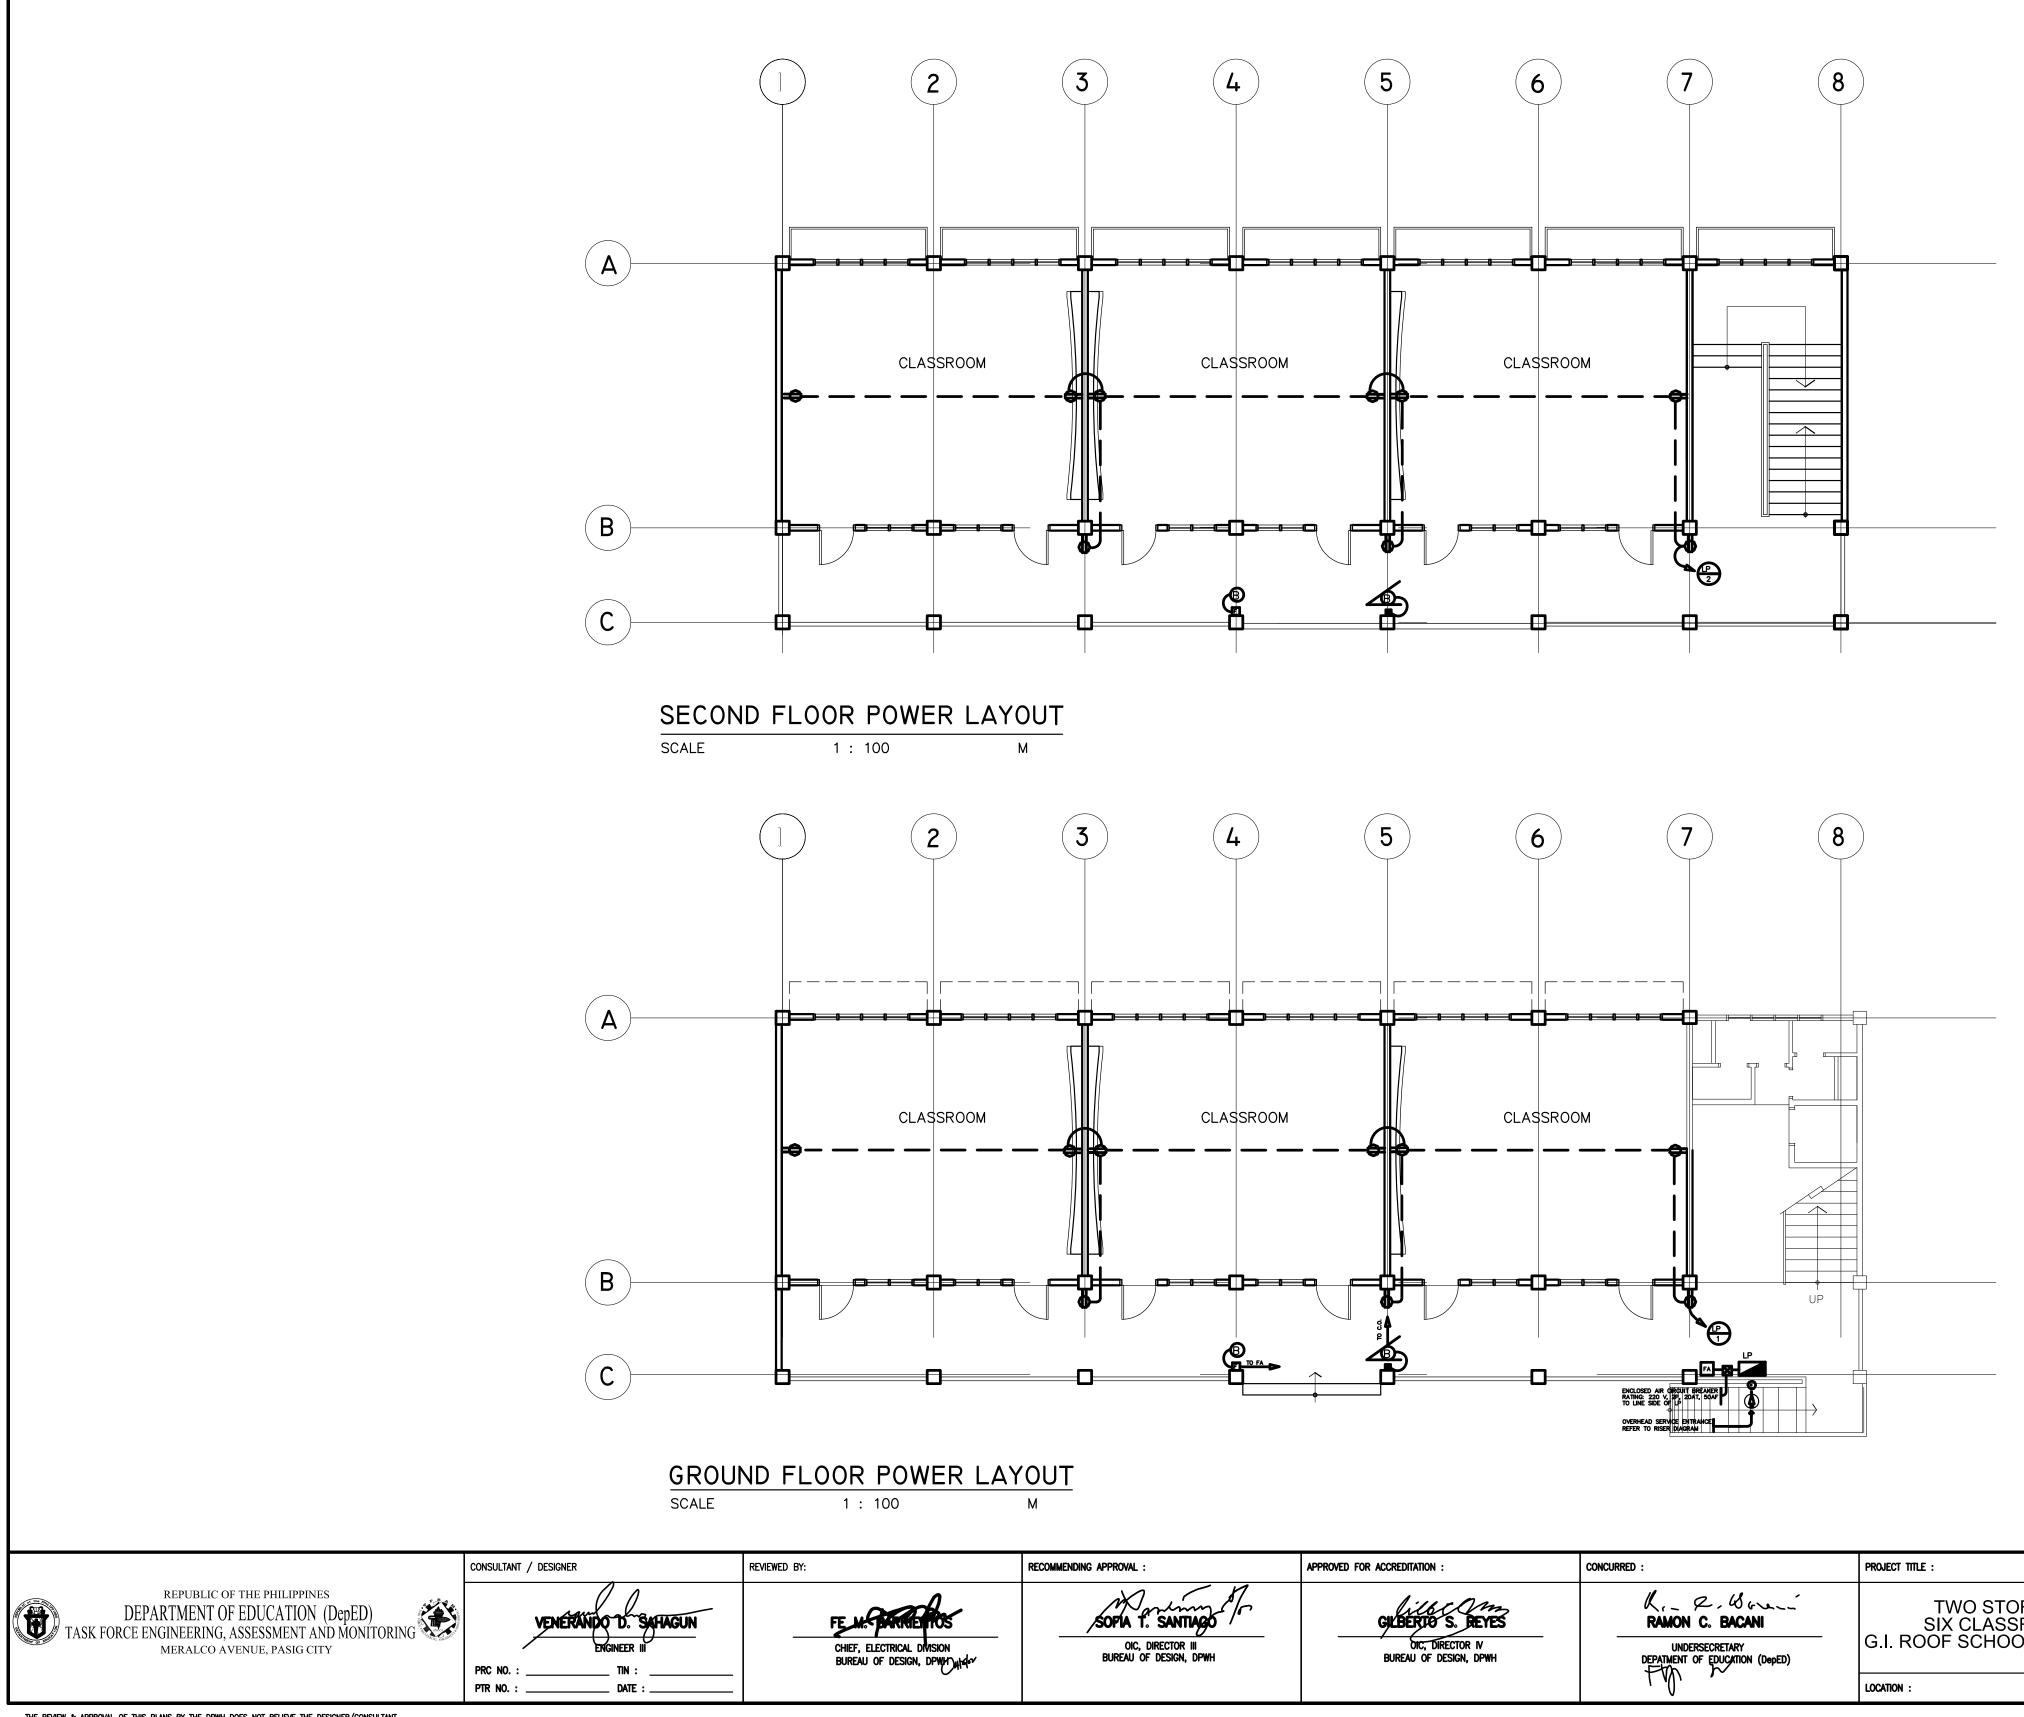


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Monim	lipeam	K. R. Brui	TWO STOREY	ESIGNED: BT:	
sopia t. santiago /	GILBERTIO S. REVES	RAMON C. BACANI		CODED BY: BRDS Max C.	
OIC, DIRECTOR III BUREAU OF DESIGN, DPWH	dic, Director IV Bureau of Design, DPWH	UNDERSECRETARY DEPATMENT OF EDUCATION (DepED)		HECKED BY:	Sheet Co Round
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A CONTRACT OF A	2 1 1 2 2 2 2 2 2 2 2 2 2 2 2 2 2 2 2 2
And	<b>,</b>
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PTR NO.

DATE :

## LEGEND:

CB CATCH BASIN

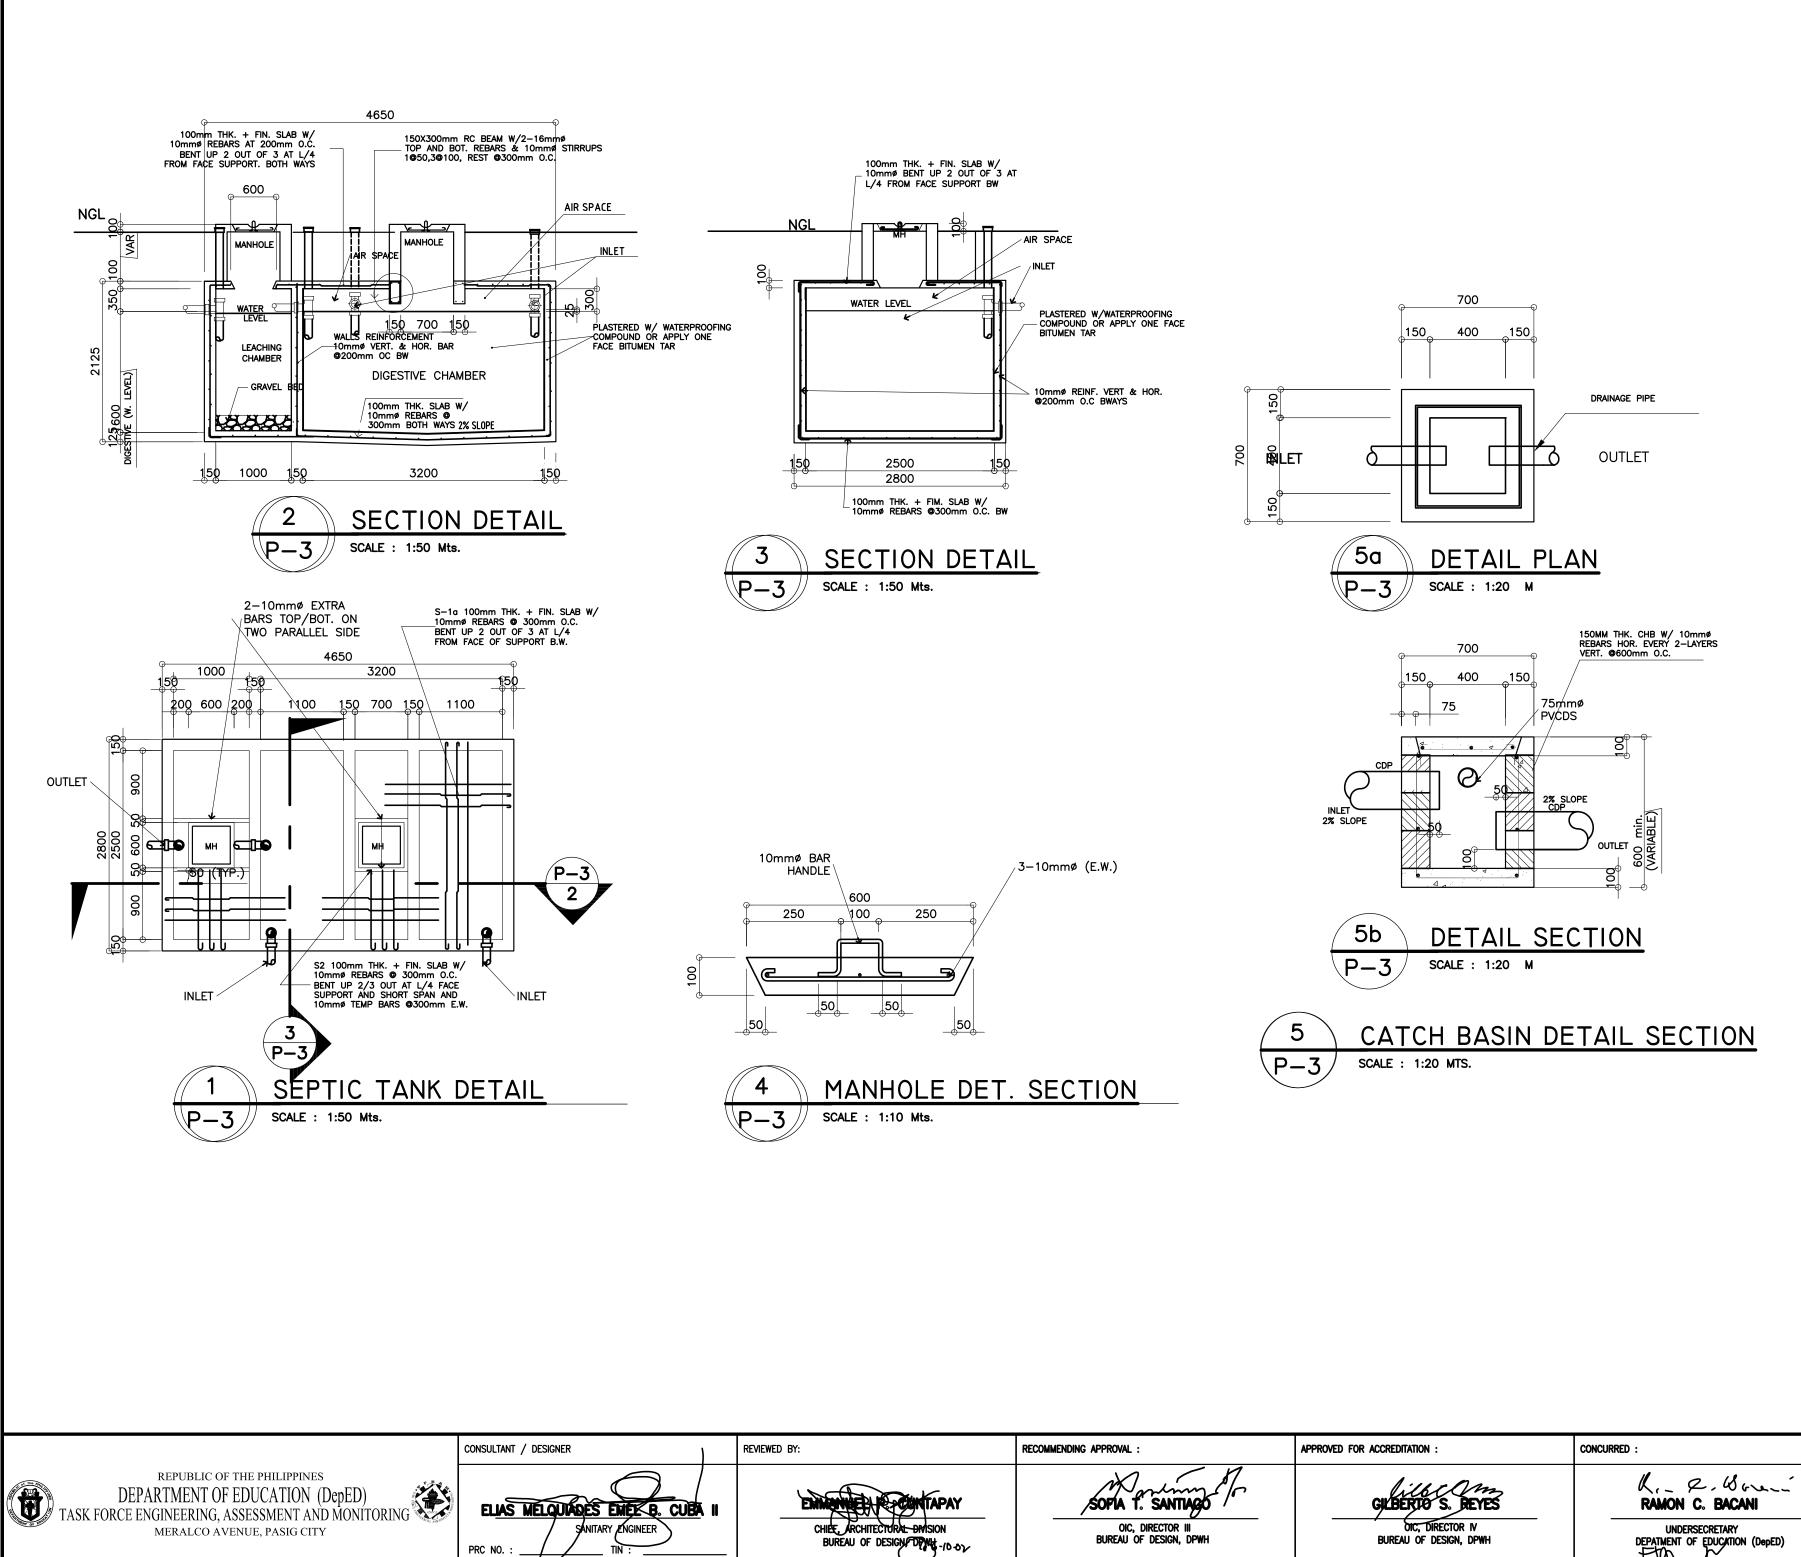CDP CONCRETE DRAIN PIPE
CO CLEAN OUT
CV CHECK VALVE
HB HOSE BIBB
FD FLOOR DRAIN
GICWL GALVANIZED IRON COLD WATER LINE (SCH. 40)
GICWR GALVANIZED IRON COLD WATER RISER (SCH. 40)
GV GATE VALVE
MH MANHOLE
PVCDS POLYVINYL CHLORIDE DOWNSPOUT
PVCDP POLYVINYL CHLORIDE DRAIN PIPE
PVCDS POLYVINYL CHLORIDE DOWNSPOUT
PVCSP POLYVINYL CHLORIDE SOIL PIPE
PVCVAC POLYVINYL CHLORIDE VENT. ACROSS CEILING
PVCVP POLYVINYL CHLORIDE VENT. PIPE
PVCVS POLYVINYL CHLORIDE VENT STACK
PVCVTR/W POLYVINYL CHLORIDE VENT TROUGH ROOF/WALL
PVCWP POLYVINYL CHLORIDE WASTE PIPE
PVCWS POLYVINYL CHLORIDE WASTE STACK
RD ROOF DRAIN
UD URINAL DRAIN
WC WATER CLOSET
LAV LAVATORY

#### COUNTER SINK CS

#### PLUMBING NOTES:

- 1. GRADES OF HORIZONTAL PIPINGS RUN ALL HORIZONTAL PIPINGS IN PERPECT ALIGNMENT AND AT A F
- 2. CHANGE IN DIRECTION ALL CHANGE IN DIRECTION SHALL BE MADE BY APPROPRIATE USE QUARTER BEND, SIXTH-EIIGHT OR SIXTEENTH BEND. WHEN THE CH. SINGLE 1/8 BEND COMBINATION MAYBE USED ON VERTICAL STACKS LINE, TEE AND CROSSES MAYBE USED IN BENT PIPES.
- PROHIBITED FITTINGS NO DOUBLE HUB OR TEE BRANCH SHALL BE USED ON HORIZONTAL OF HOUSE DRAIN, WASTE OR VENT PIPES AND USED OF SADDLE H 3.
- **4.** PIPE CLEAN-OUTS CLEAN-OUTS ARE REQUIRED UNDER THE FOLLOWING CONDITIONS: a) EVERY CHANGE OF HORIZONTAL DIRECTION EXCEEDING TWENTY b) ONE AND ONE-HALF METERS (1.50m.) INSIDE THE PROPERTY c) EVERY FIFTEEN METERS (15.00m) IN HORIZONTAL RUN OF PIPE d) AT THE END OF ANY HORIZONTAL PIPE LINES.
- 5. THE DIGESTION CHAMBER OF SEPTIC VAULT MUST BE WATERPROOF
- 6. NOT LESS THAN 0.30 METER OF AIR SPACE MUST BE LEFT BETWEE VAULT ROOF SLAB.
- 7. NO SEPTIC VAULT SHALL BE CONSTRUCTED UNDER THE BUILDING.
- 8. ALL PLUMBING WORKS SHALL BE UNDER THE SUPRVISION OF A LI CONTRACTOR.

#### DESIGN CRITERIA

i. LIVE LOAD	1000Pa
ii ALLOWABLE STRESSES	
1. CONCRETE	
a. FOR FOOTING, BEAMS A	ND SLABS
fc'' = 20 MPa	
2. CONCRETE MASONRY UNI	TS (LOAD BEARING CHB)
fm' =6.90 MPa, fm = 2.4	1 MPa
3. REINFORCING STEEL BARS	5
FOR BARS SMALLER THAI	N 16mmø
fy = 230 MPa	
4. ASSUMED ALLOWABLE B	EARING CAPACITY $Y = 100$ KPa
<u>NOTE:</u>	

WATER TABLE IS 1500 BELOW GROUND LEVEL.

DING APPROVAL :	APPROVED FOR ACCREDITATION :	CONCURRED :	PROJECT TITLE :	PROJECT NO:	OWNER :
SOPIA T. SANTIAGO OIC, DIRECTOR III BUREAU OF DESIGN, DPWH GILBERTO S. REYES OIC, DIRECTOR IV BUREAU OF DESIGN, DPWH	K. R. Borni	TWO STOREY	DESIGNED BY:	C	
		RAMON C. BACANI	SIX CLASSROOM G.I. ROOF SCHOOL BUILDING	ENCODED BY: Max C.	
	UNDERSECRETARY DEPATMENT OF EDUCATION (DepED)		CHECKED BY:	Sheet Co Septic	
		TW, ,	Location :	DATE : 08/06/2004	& DES

FORM GRADE NOT LESS THAN TWO PERCE	NT (2%)
OF FORTY—FIVE DEGREES (45°) WYES, LC IANGE OF FLOW IS FROM HORIZONTAL TO S AND SHORT QUARTER BENDS MAYBE US	VERTICAL A
AL SOIL AND WASTE LINES, THE DRILLINGS HUB AND BEND ARE PROHIBITED.	AND TAPPING
TWOAND ONE—HALF DEGREES (22 1/2°). LINES BEFORE THE HOUSE DRAINAGE CON ES.	NECTION.
ED.	INDER PART OF
ICENSED MASTER PLUMBER AND A LICENC	ED PLUMBING
DEPARTMENT OF EDUCATION DepED	SHEET NO:
contents : Tic Tank, catch basin detail, legend, notes Design criteria	2
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