

PERSPECTIVE VIEW A-1SCALE: NTS

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REPUBLIC OF THE PHILIPPINES

OFFICE OF THE CITY/MUNICIPAL ENGINEER/BUILDING OFFICIAL

DISTRICT/CITY/MUNICIPALITY

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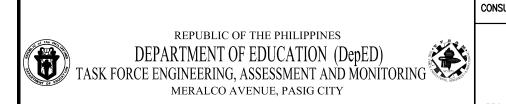
SANITARY

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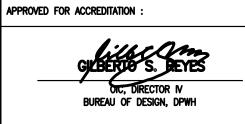
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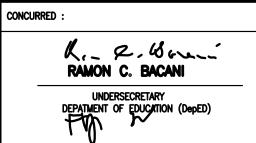
MECHANICAL



REVIEWED BY: CONSULTANT / DESIGNER ALBERT Z. DE BELEN PTR NO. : ______ DATE : _____ 27 OCT. 2002









	PROJECT TITLE
_	
ı	v
	LOCATION :

TITLE:
THREE STOREY SIX CLASSROOM w/MULTI-PURPOSE

	PROJECT NO: 01-002	OWNER:
OREY	DESIGNED BY: AZB	DEPART
SROOM	ENCODED BY: Max C	
IRPOSE	CHECKED BY:	SHEET CONTENTS :

PROJECT NO: 01-002	OWNER:	SHEET NO:
DESIGNED BY: AZB	DEPARTMENT OF EDUCATION	
ENCODED BY: Max C	DepED	/ A-
CHECKED BY:	SHEET CONTENTS :	\ 8
DATE : 01 03	PERSPECTIVE VIEW, TABLE OF CONTENTS	

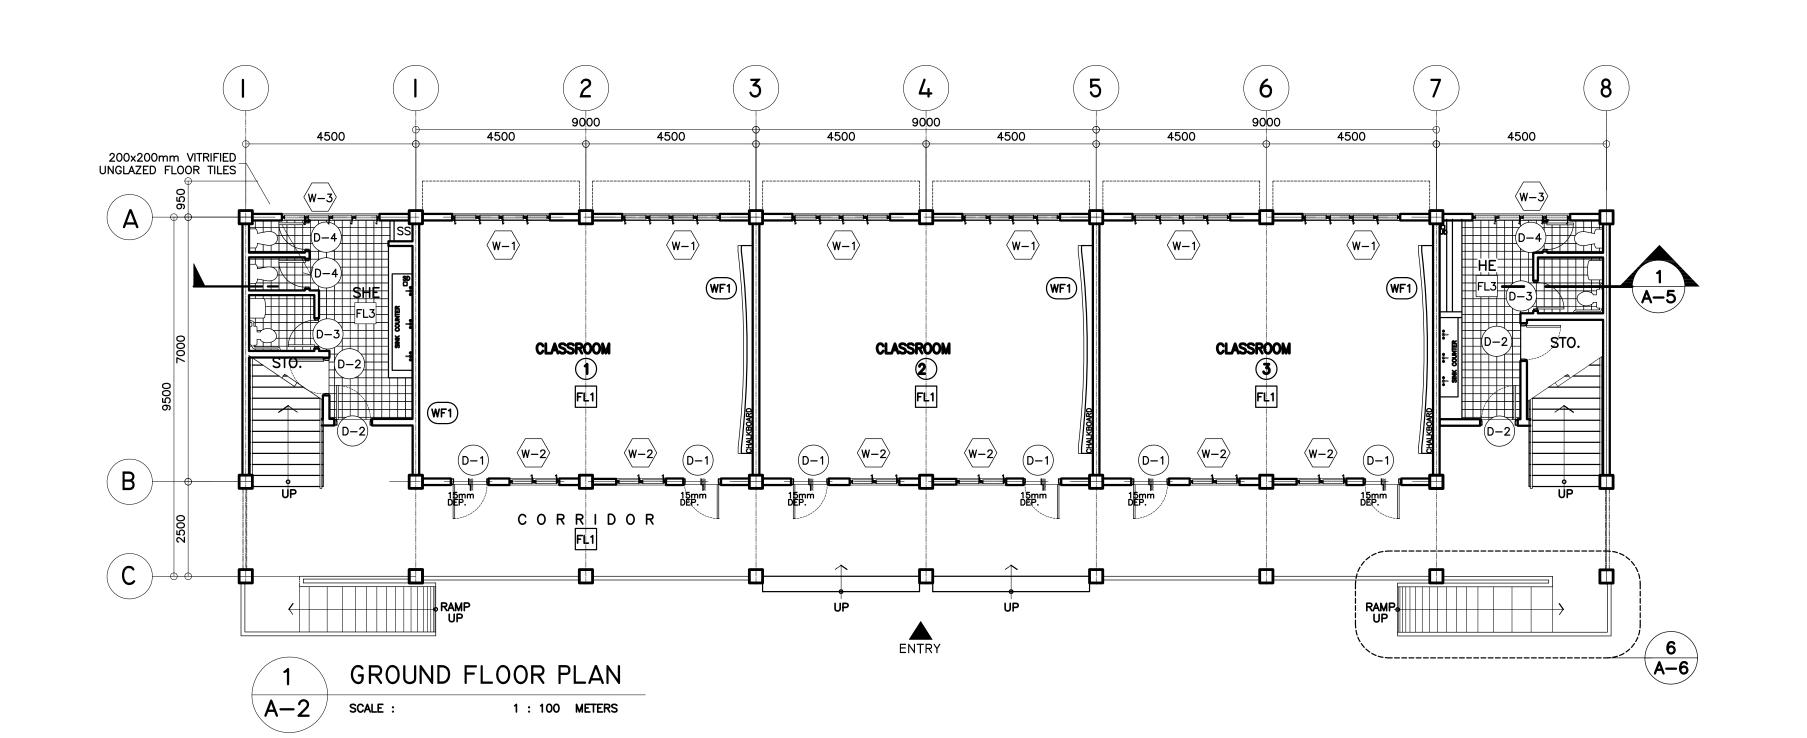

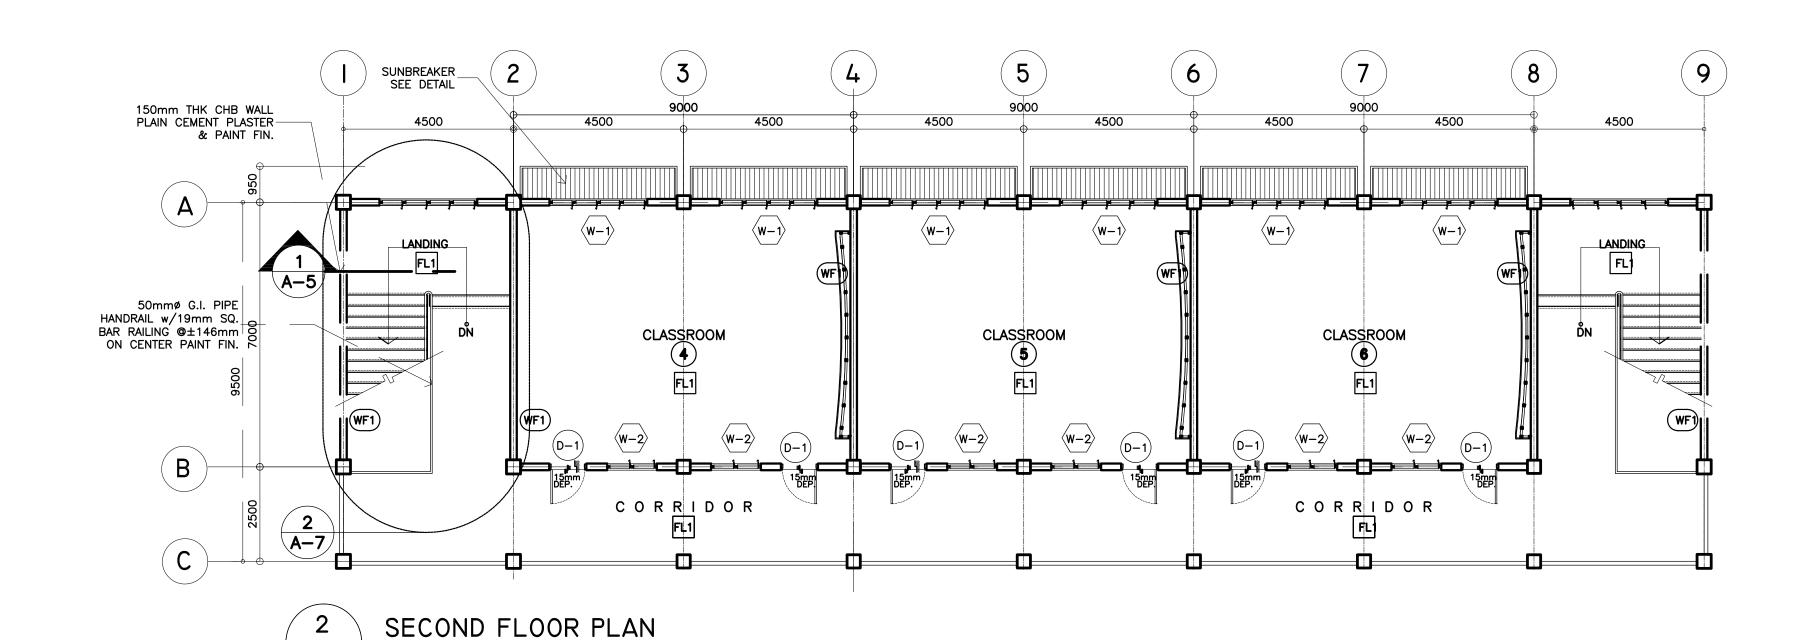

RECOMMENDING APPROVAL:

OIC, DIRECTOR III

BUREAU OF DESIGN, DPWH

APPROVED FOR ACCREDITATION :

BUREAU OF DESIGN, DPWH

CONCURRED:

K. 2. Bour

RAMON C. BACANI

UNDERSECRETARY
DEPAIMENT OF EDUCATION (DepED)

REVIEWED BY:

A-2

REPUBLIC OF THE PHILIPPINES

MERALCO AVENUE, PASIG CITY

DEPARTMENT OF EDUCATION (DepED)
TASK FORCE ENGINEERING, ASSESSMENT AND MONITORING

SCALE :

CONSULTANT / DESIGNER

ALBERT Z. DE BELEN

PTR NO. : ______ DATE : _____ 27 OCT. 2002

___ TIN : ___149 460 161

DEPARTMENT OF EDUCATION THREE STOREY DepED A-2SIX CLASSROOM ENCODED BY: Max C w/MULTI-PURPOSE SHEET CONTENTS: CHECKED BY: GROUND & SECOND FLOOR PLAN DATE: 01 03

PROJECT NO: 01-002 OWNER:

DESIGNED BY: AZB

PROJECT TITLE :

LOCATION :

SCHEDULE OF FINISH

| FL1 | - PLAIN CEMENT FLOOR FINISH

FL2 - PLAIN CEMENT FLOOR ROUGH WITH GROOVES

FL3 - 200X200 VITRIFIED FLR TILES

FL5 - PLAIN CEMENT FLOOR FINISH WITH WATER PROOFING

(WF1) - 150 MM THK. CHB W/ PLAIN

WF2) - 150 MM THK. CHB W/ PLAIN CEMENT PLASTER FIN (PAINTED)

PROVIDE GROOVES

(GLAZED)

(WF3) - 200X200 VITRIFIED WALL TILES

WF4) - 100 MM THK. CHB W/ PLAIN CEMENT PLASTER FIN (PAINTED)

(WF5)- 50 MM SQ. CYCLONE WIRE ON 75mmø G.I. PIPE VERT

@1200mm O.C. & 50mmø G.I. PIPE HOR. @600mm O.C.

CEMENT PLASTER FIN (PAINTED)


(UNGLAZED)


|FL4| - 300X300 VINYL TILES


FLOORS:


WALLS:


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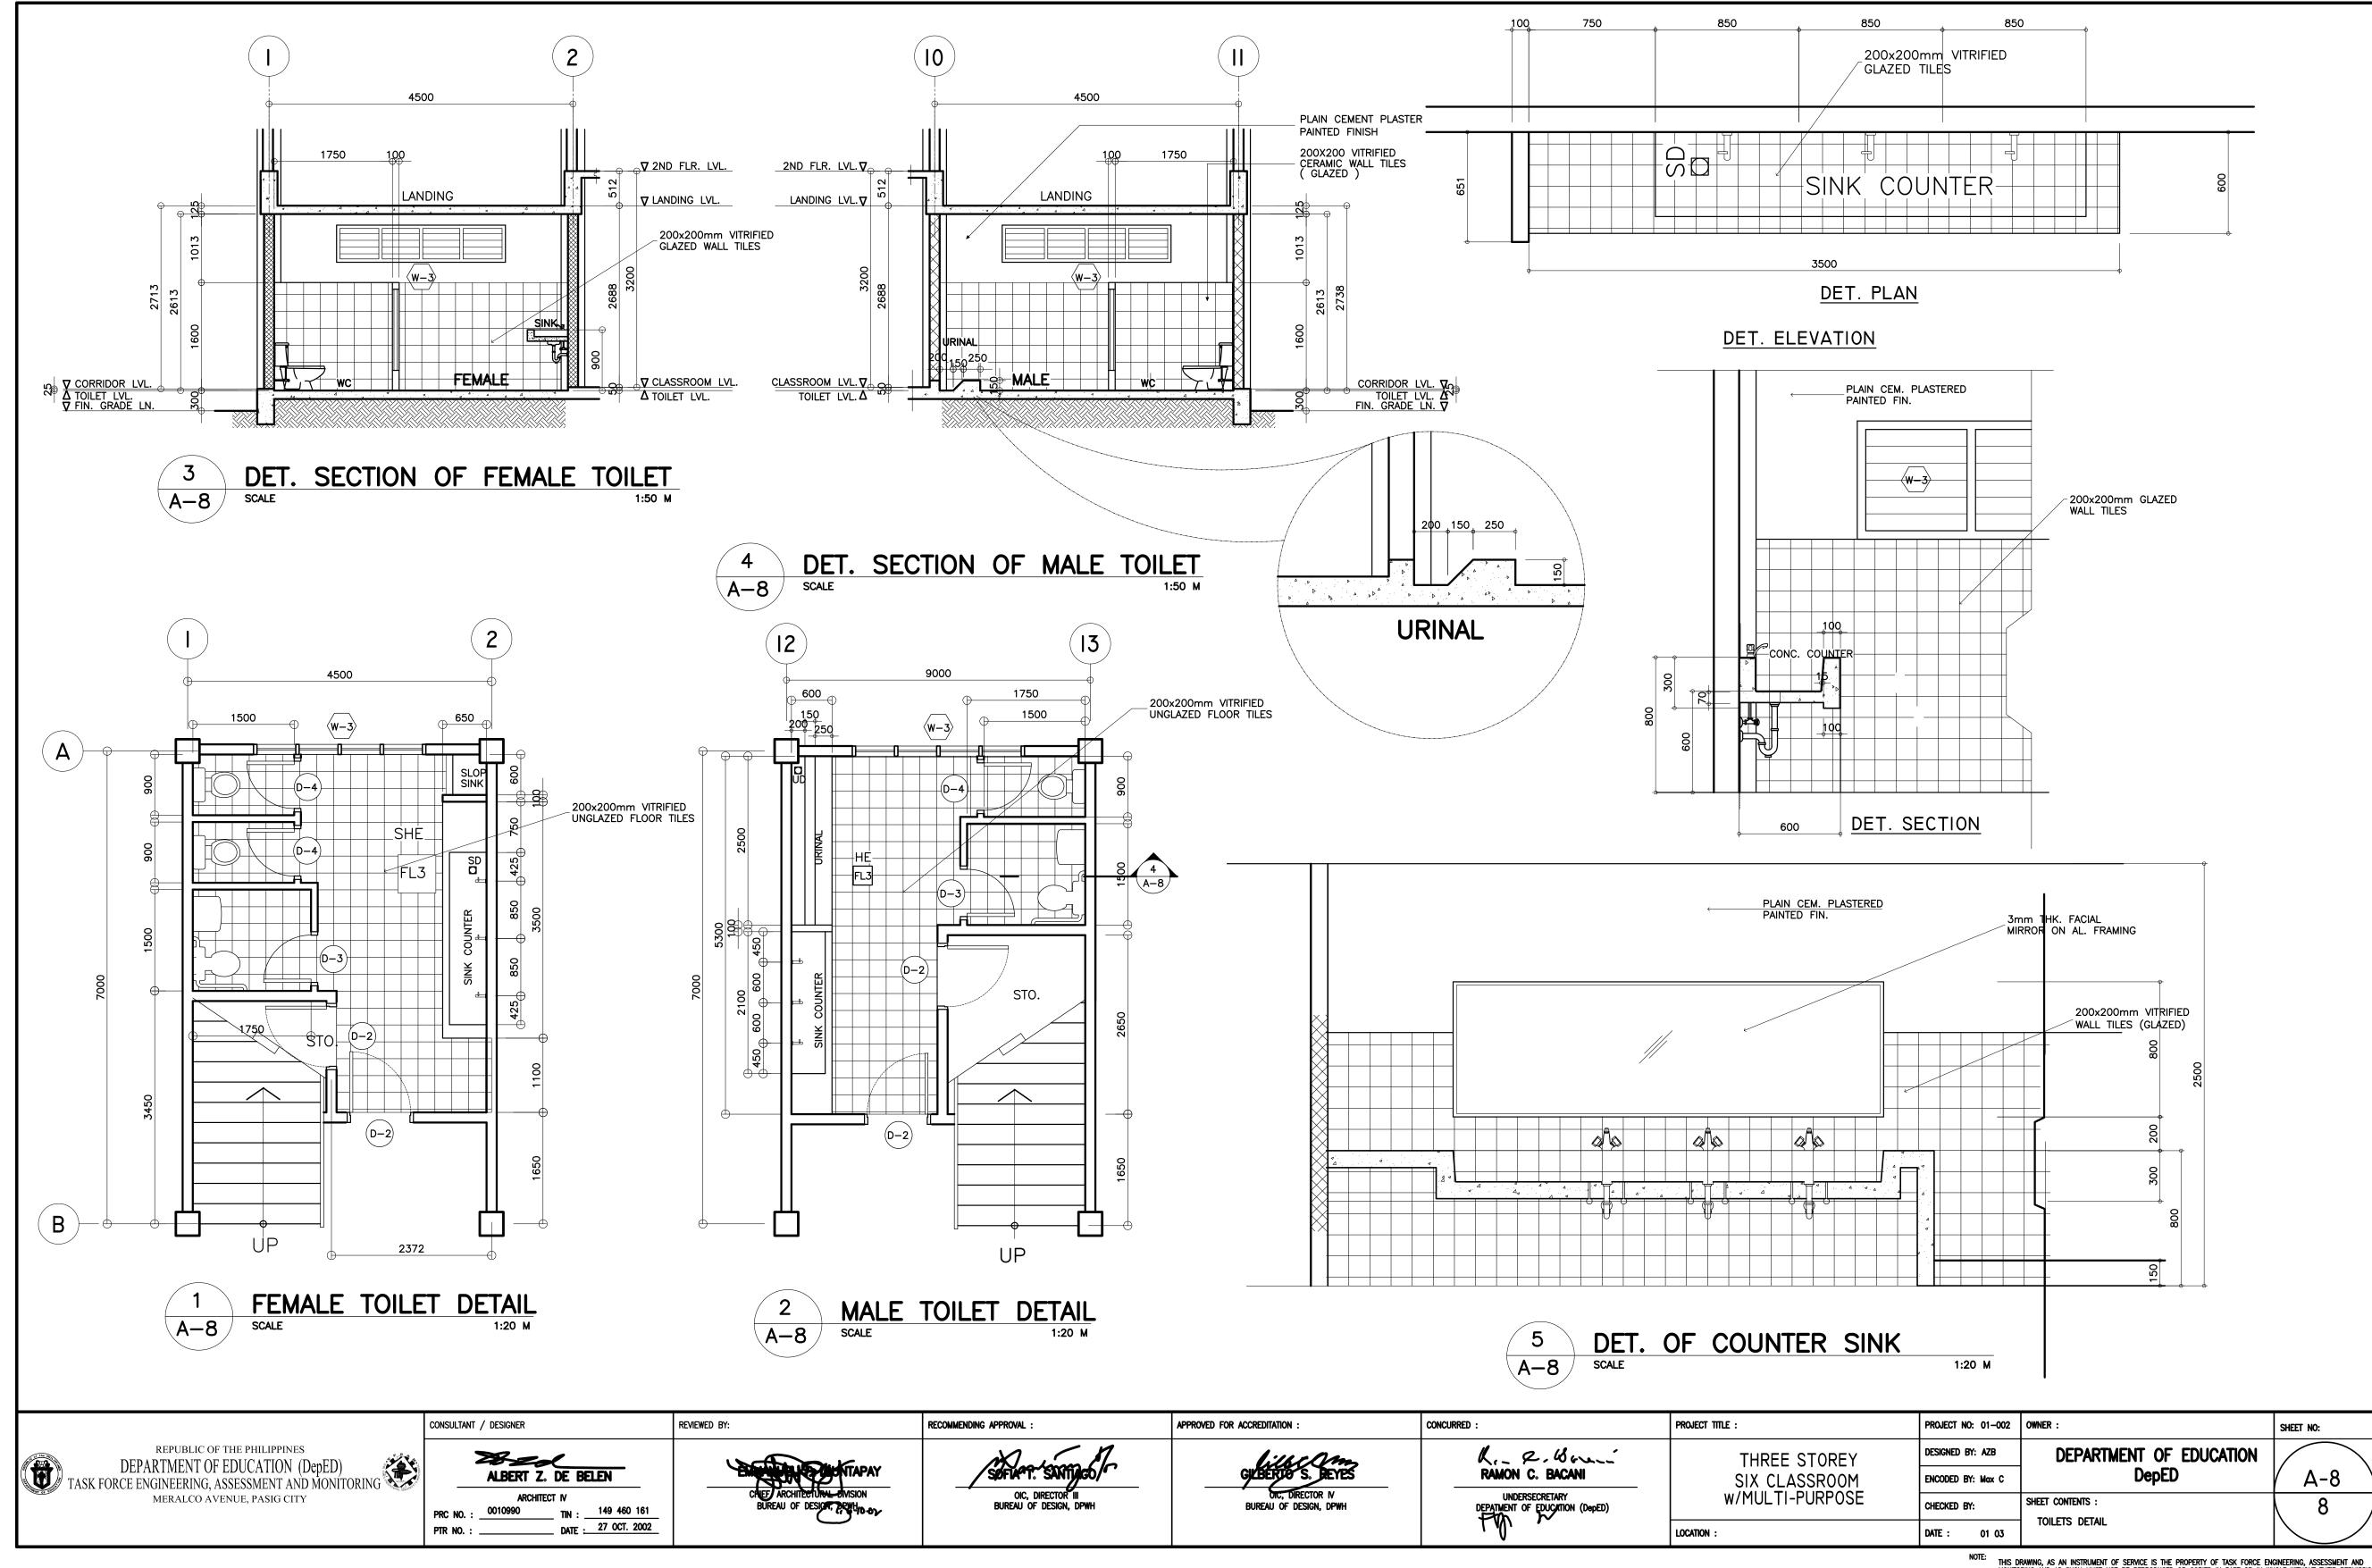


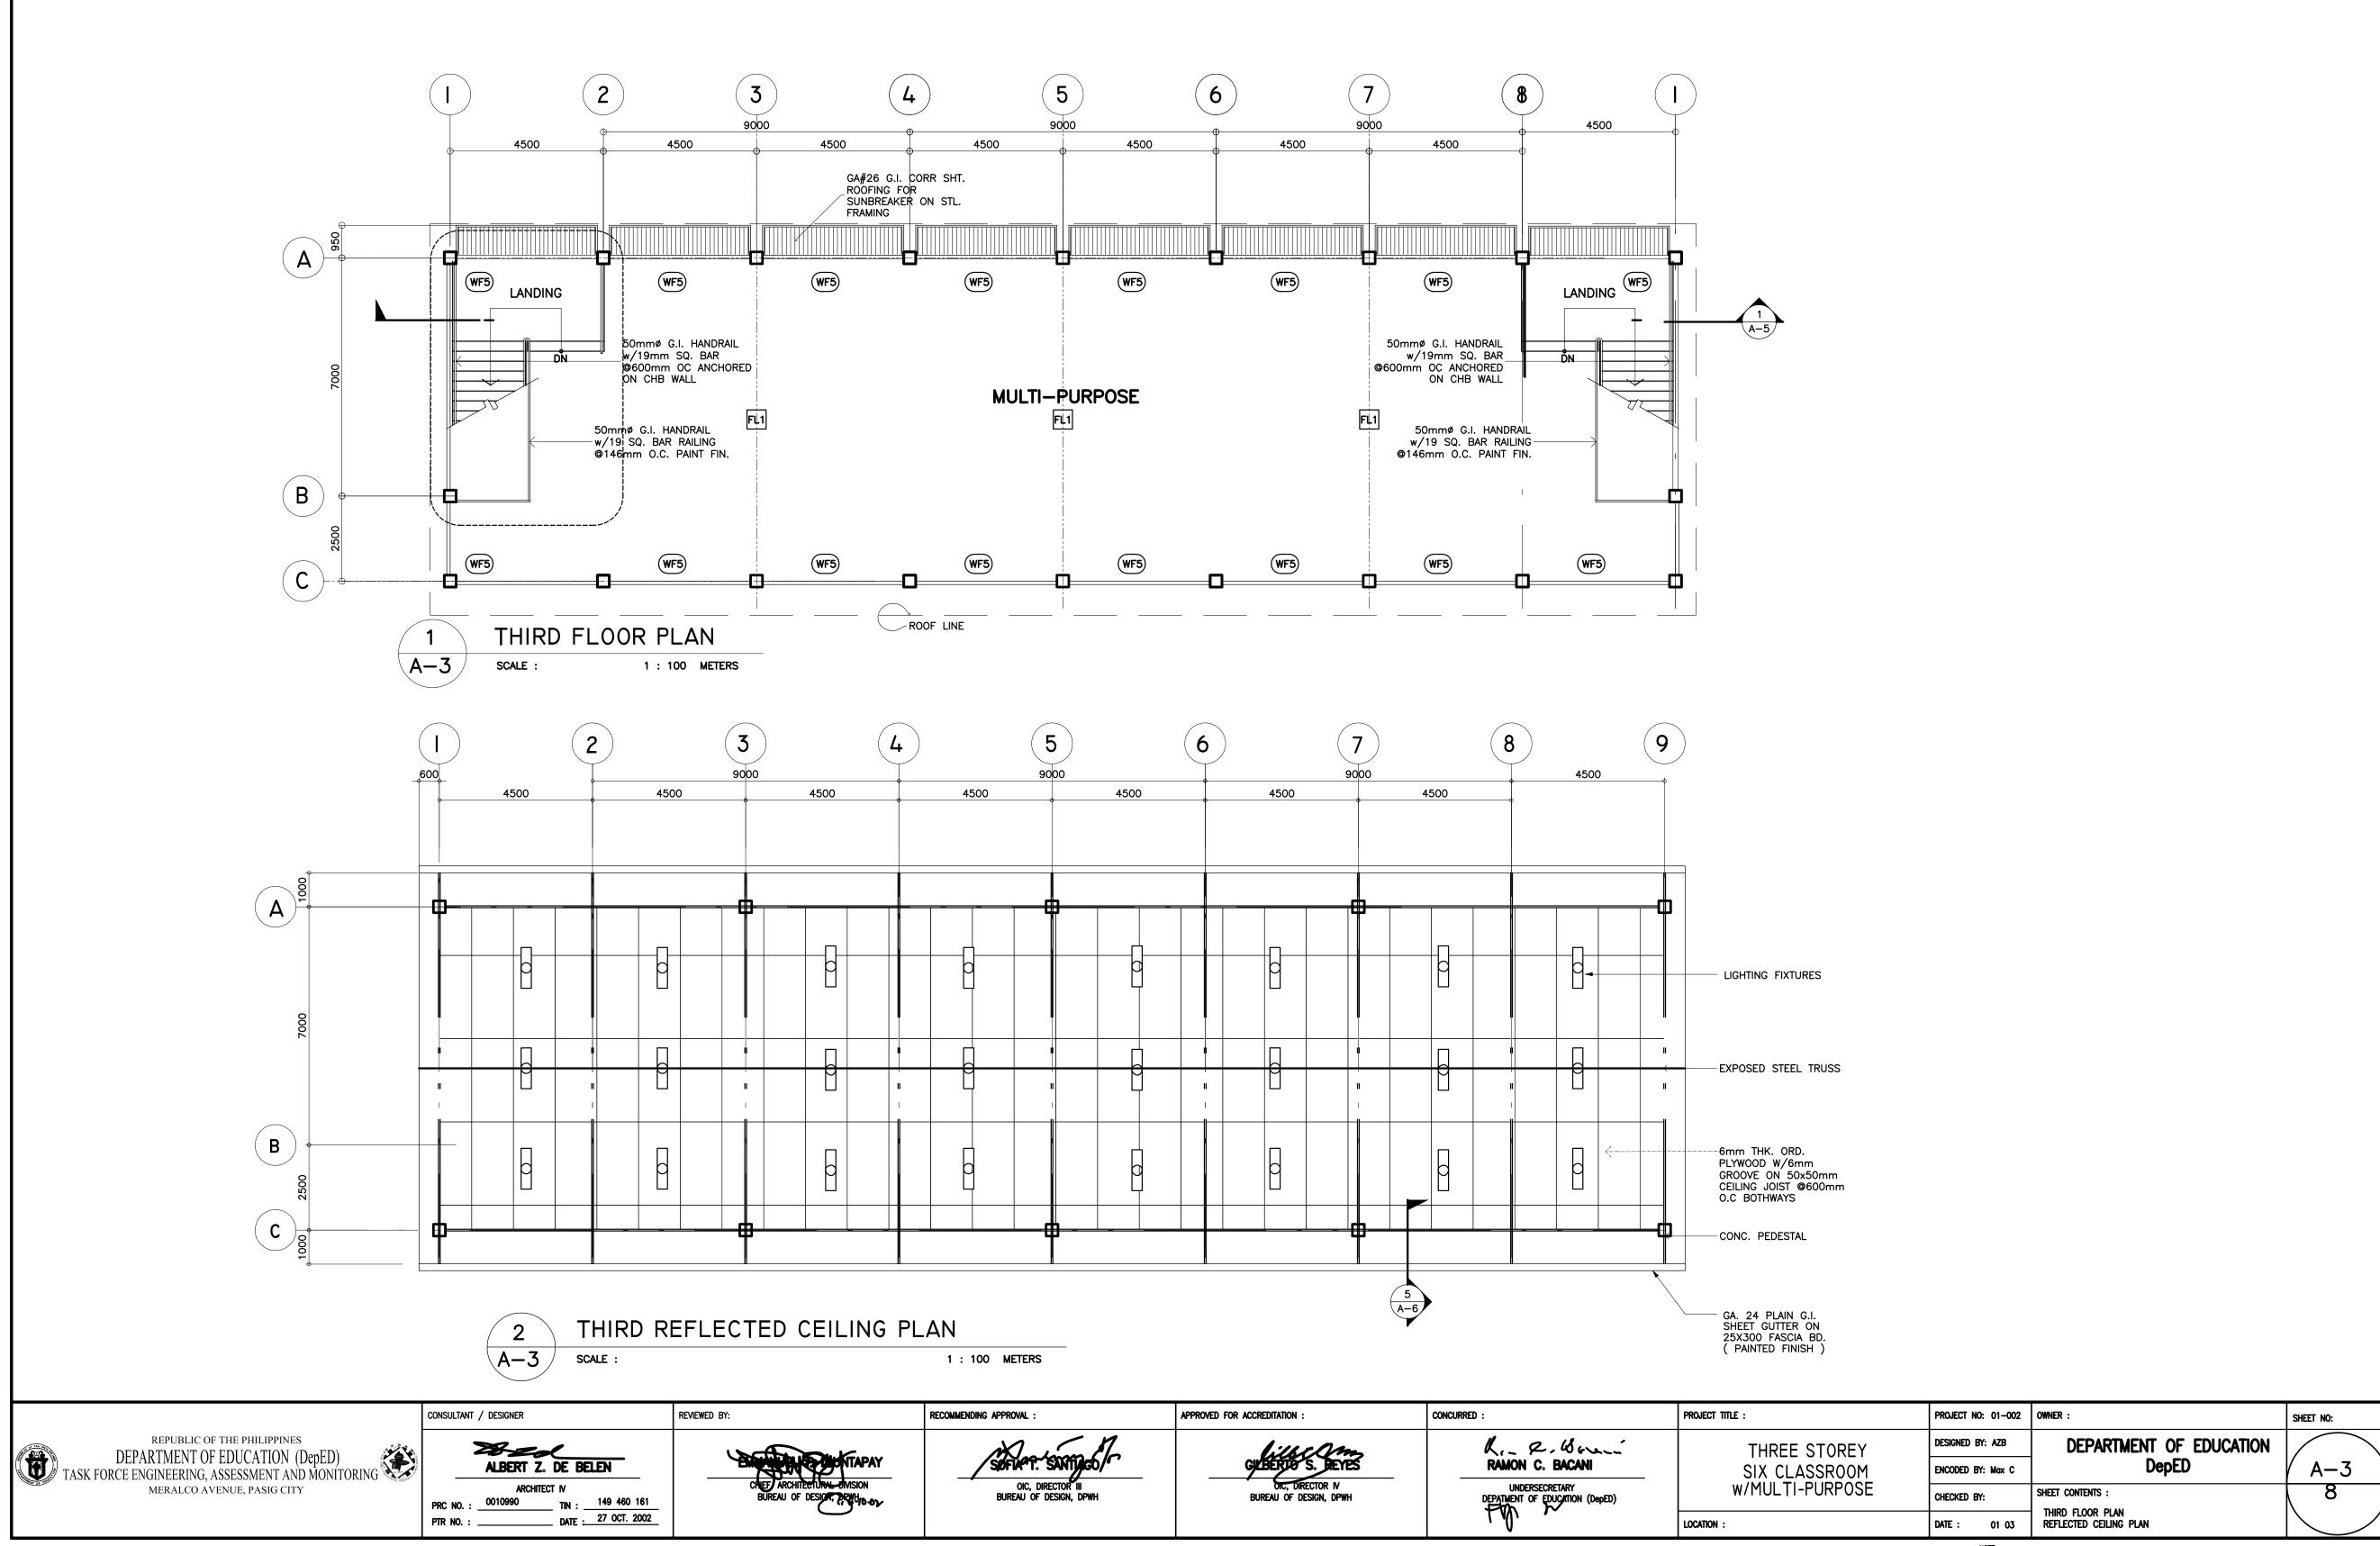


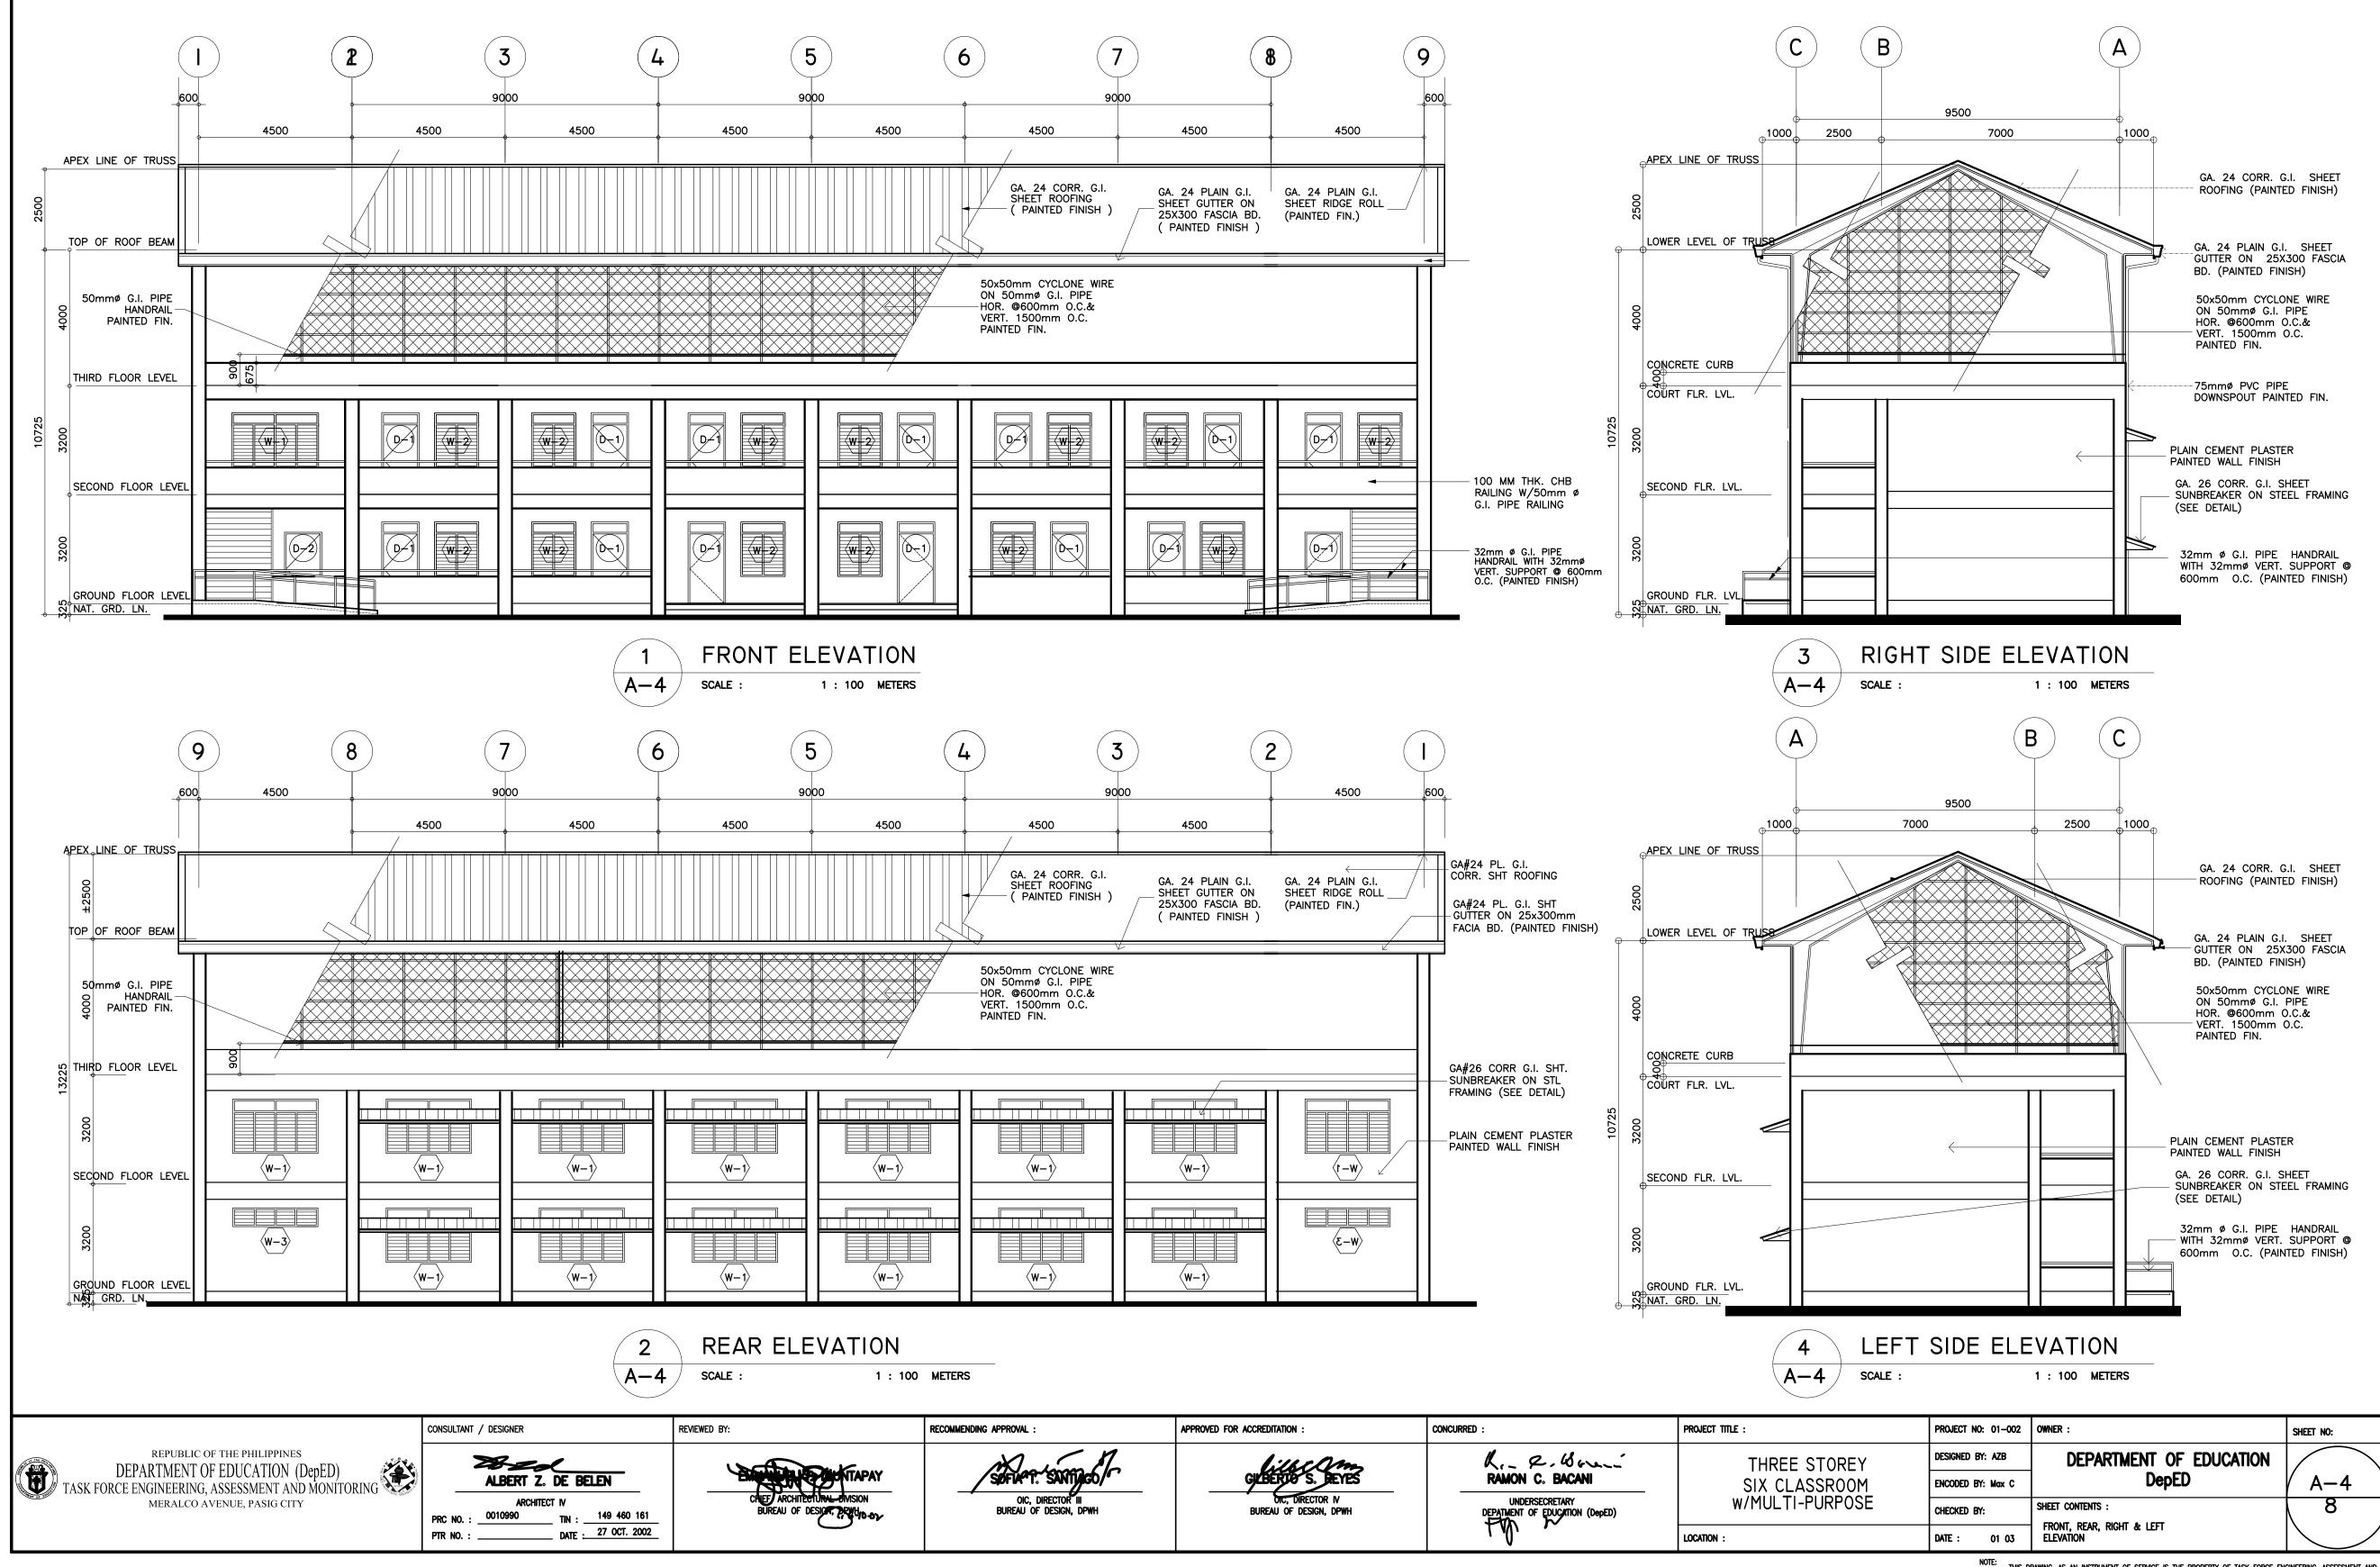


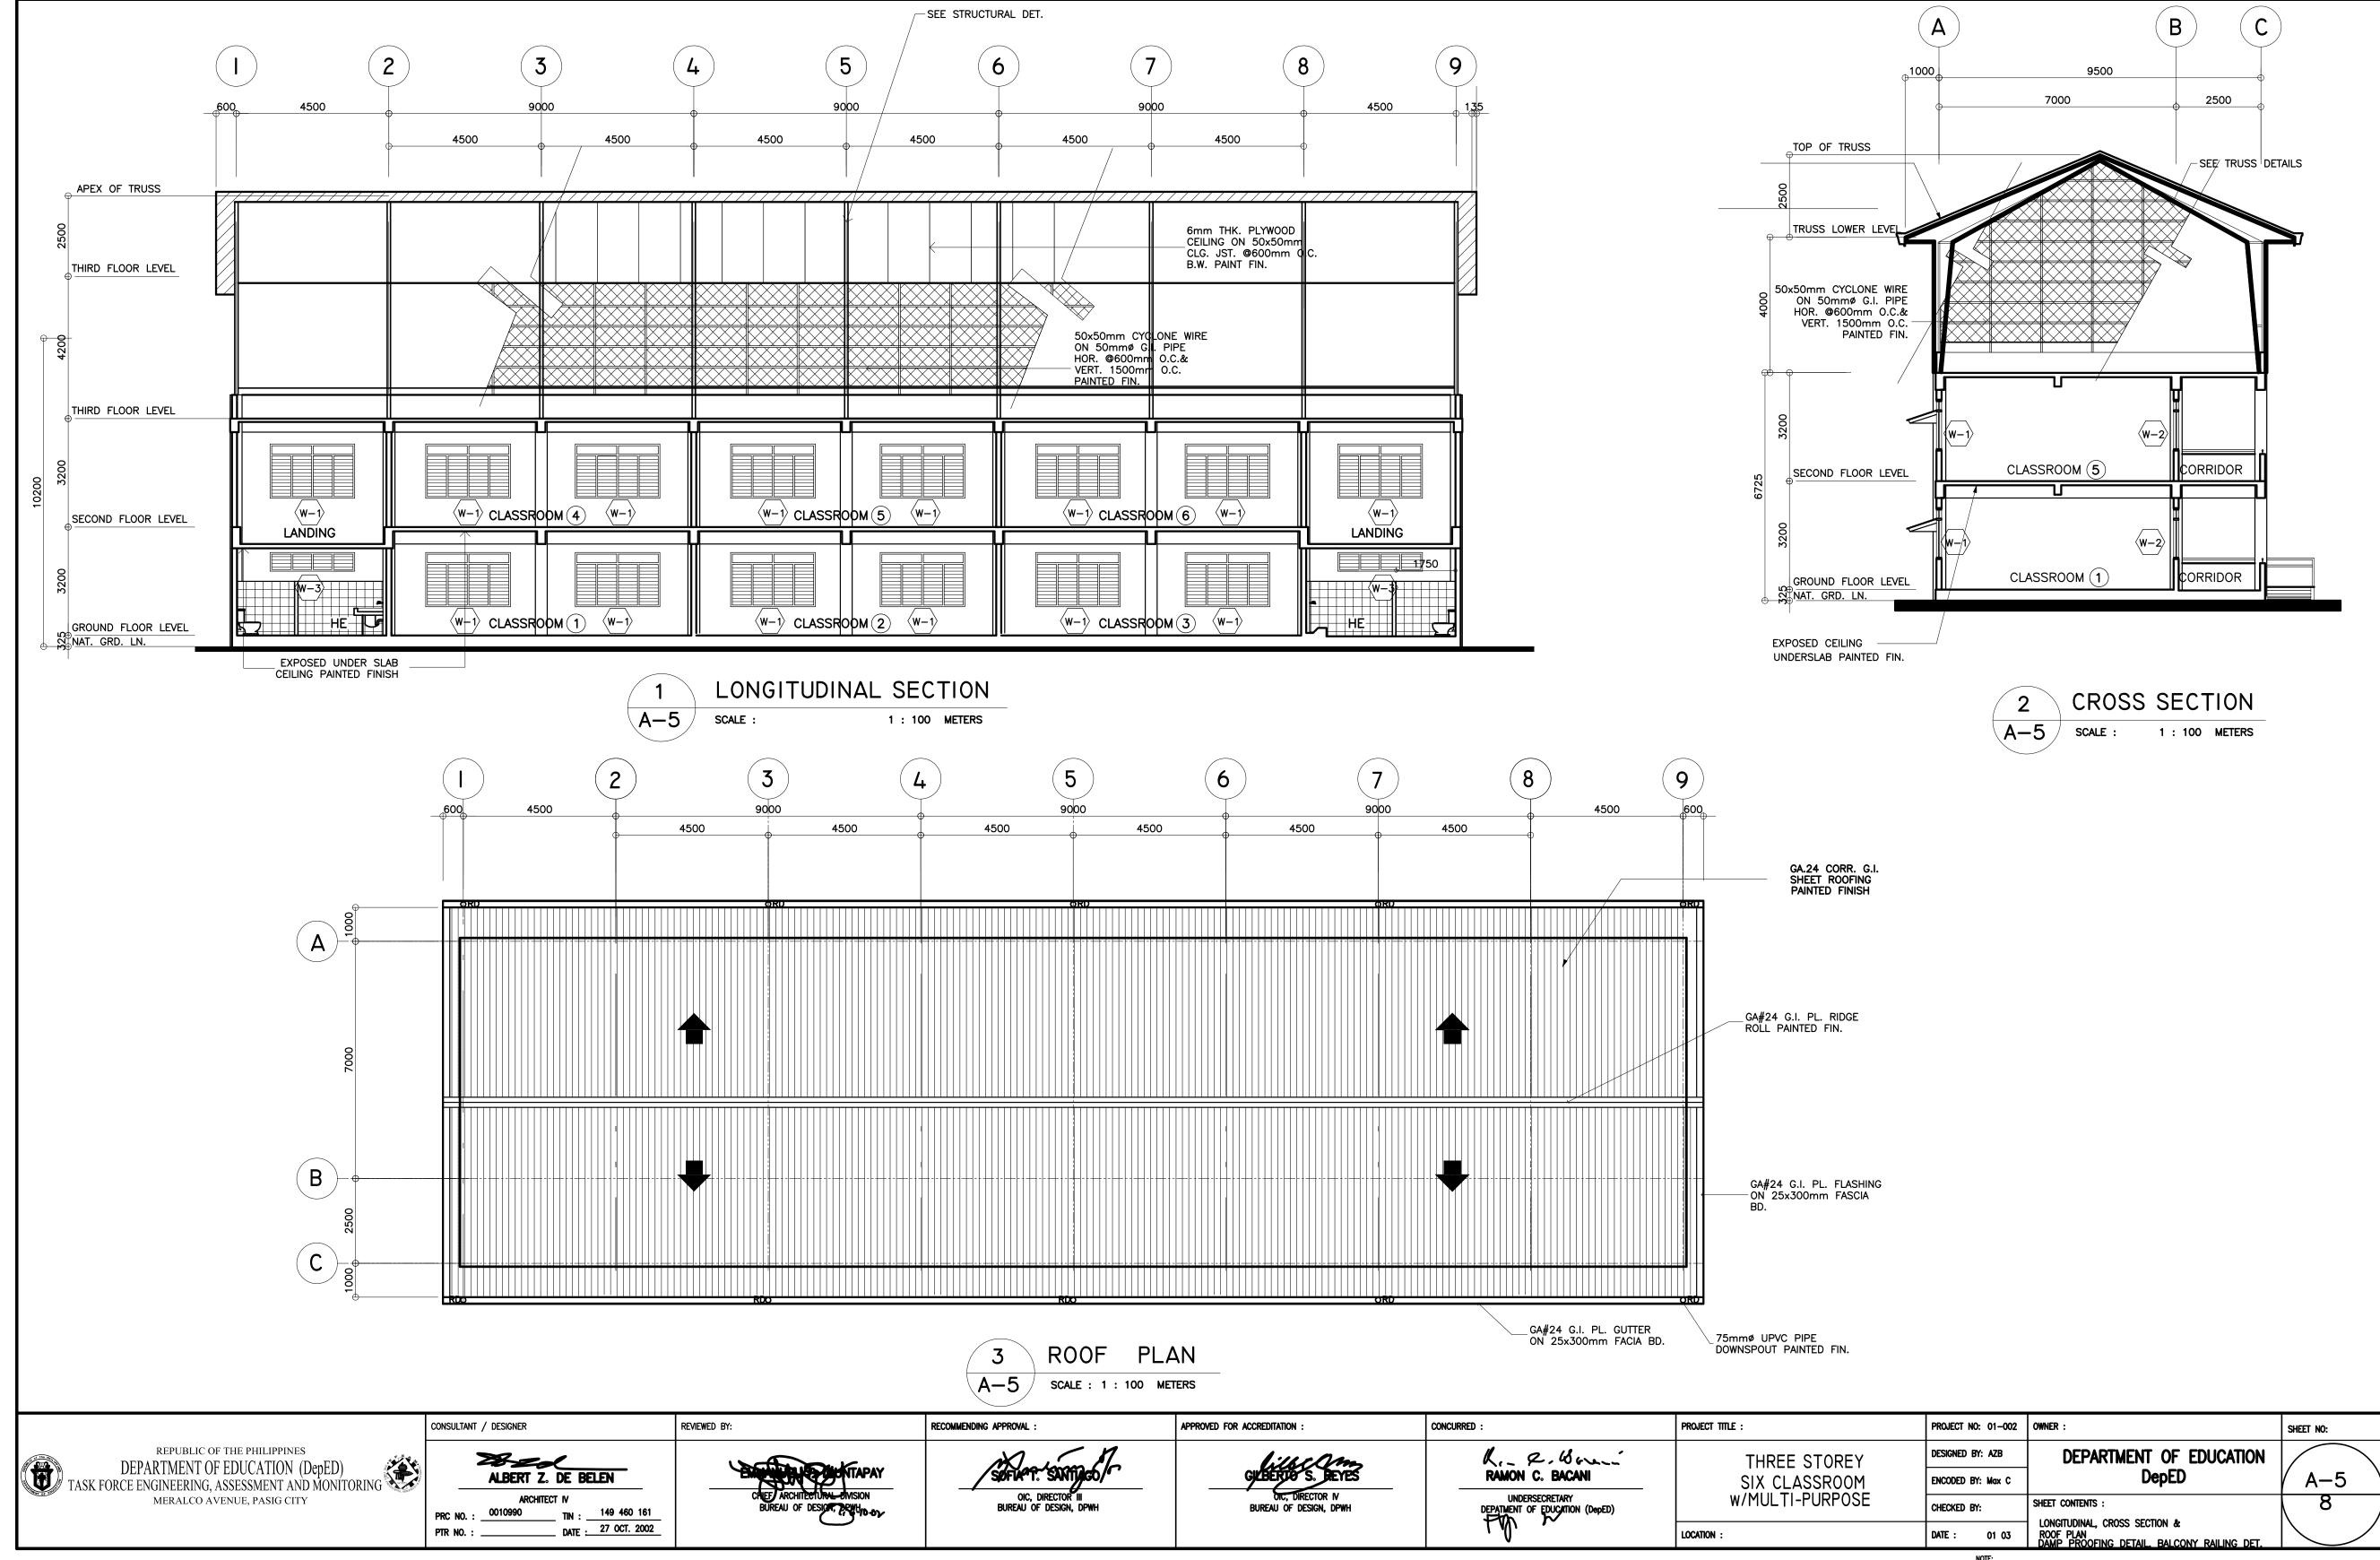


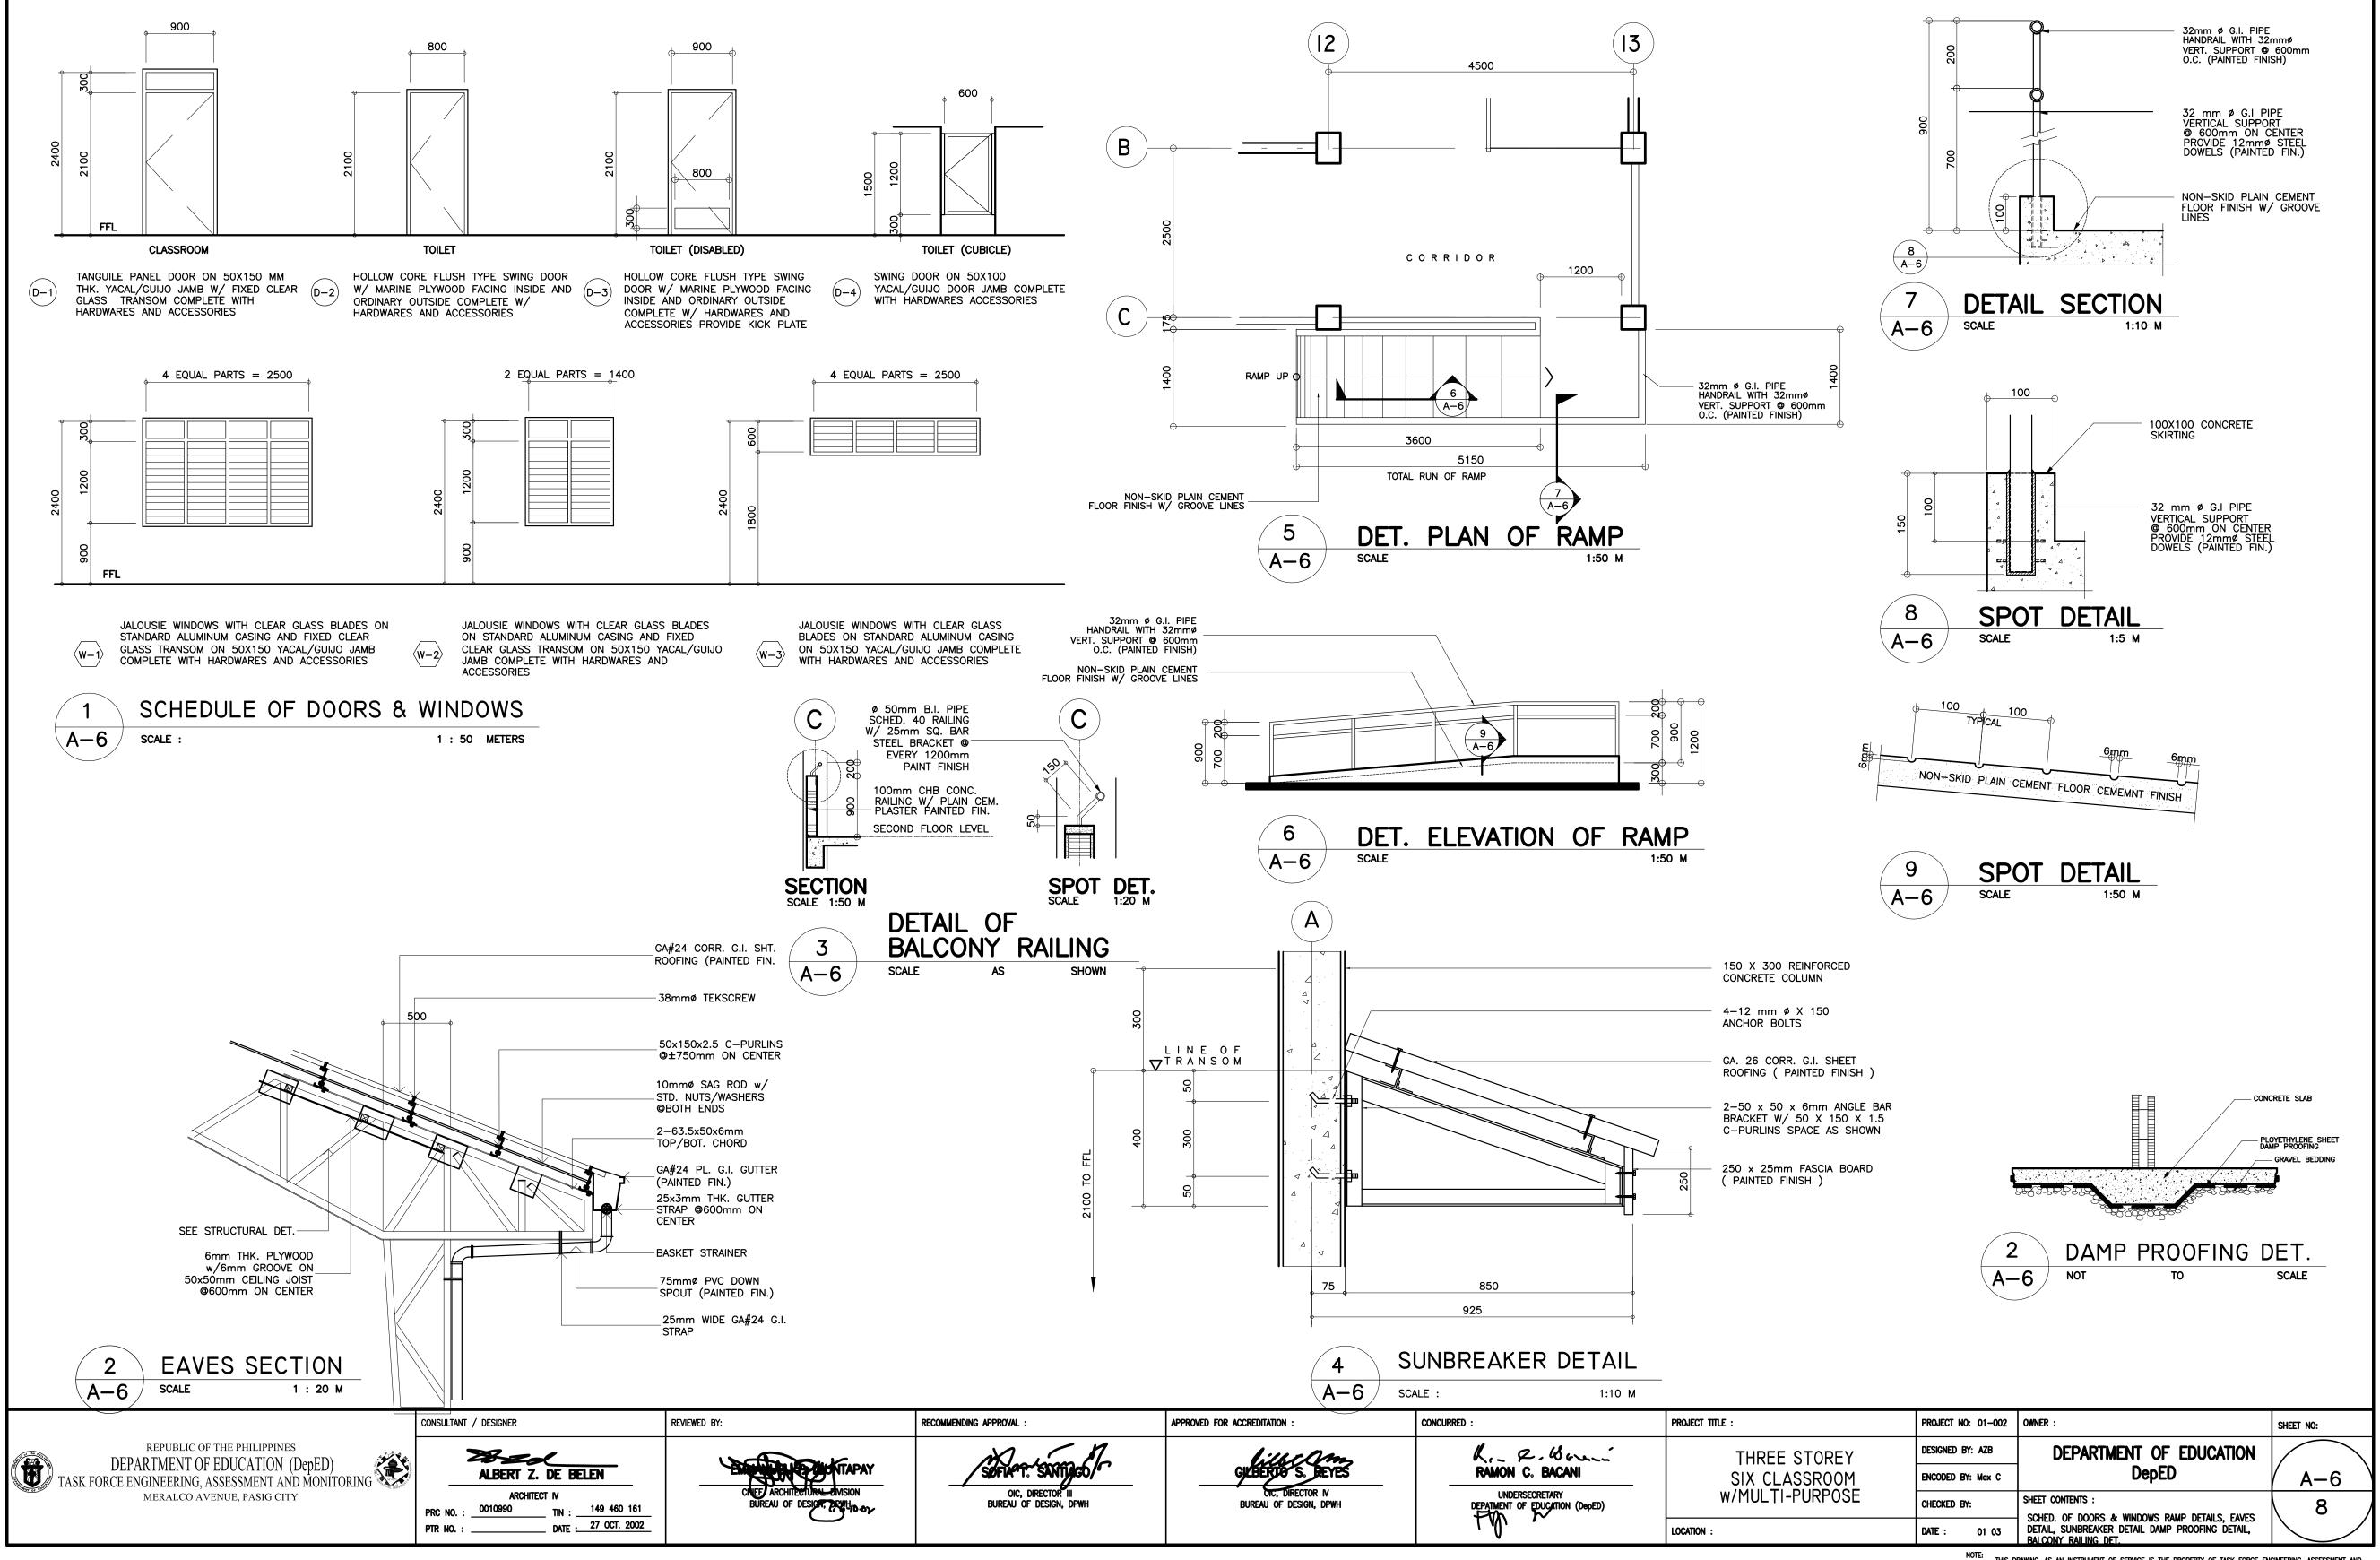

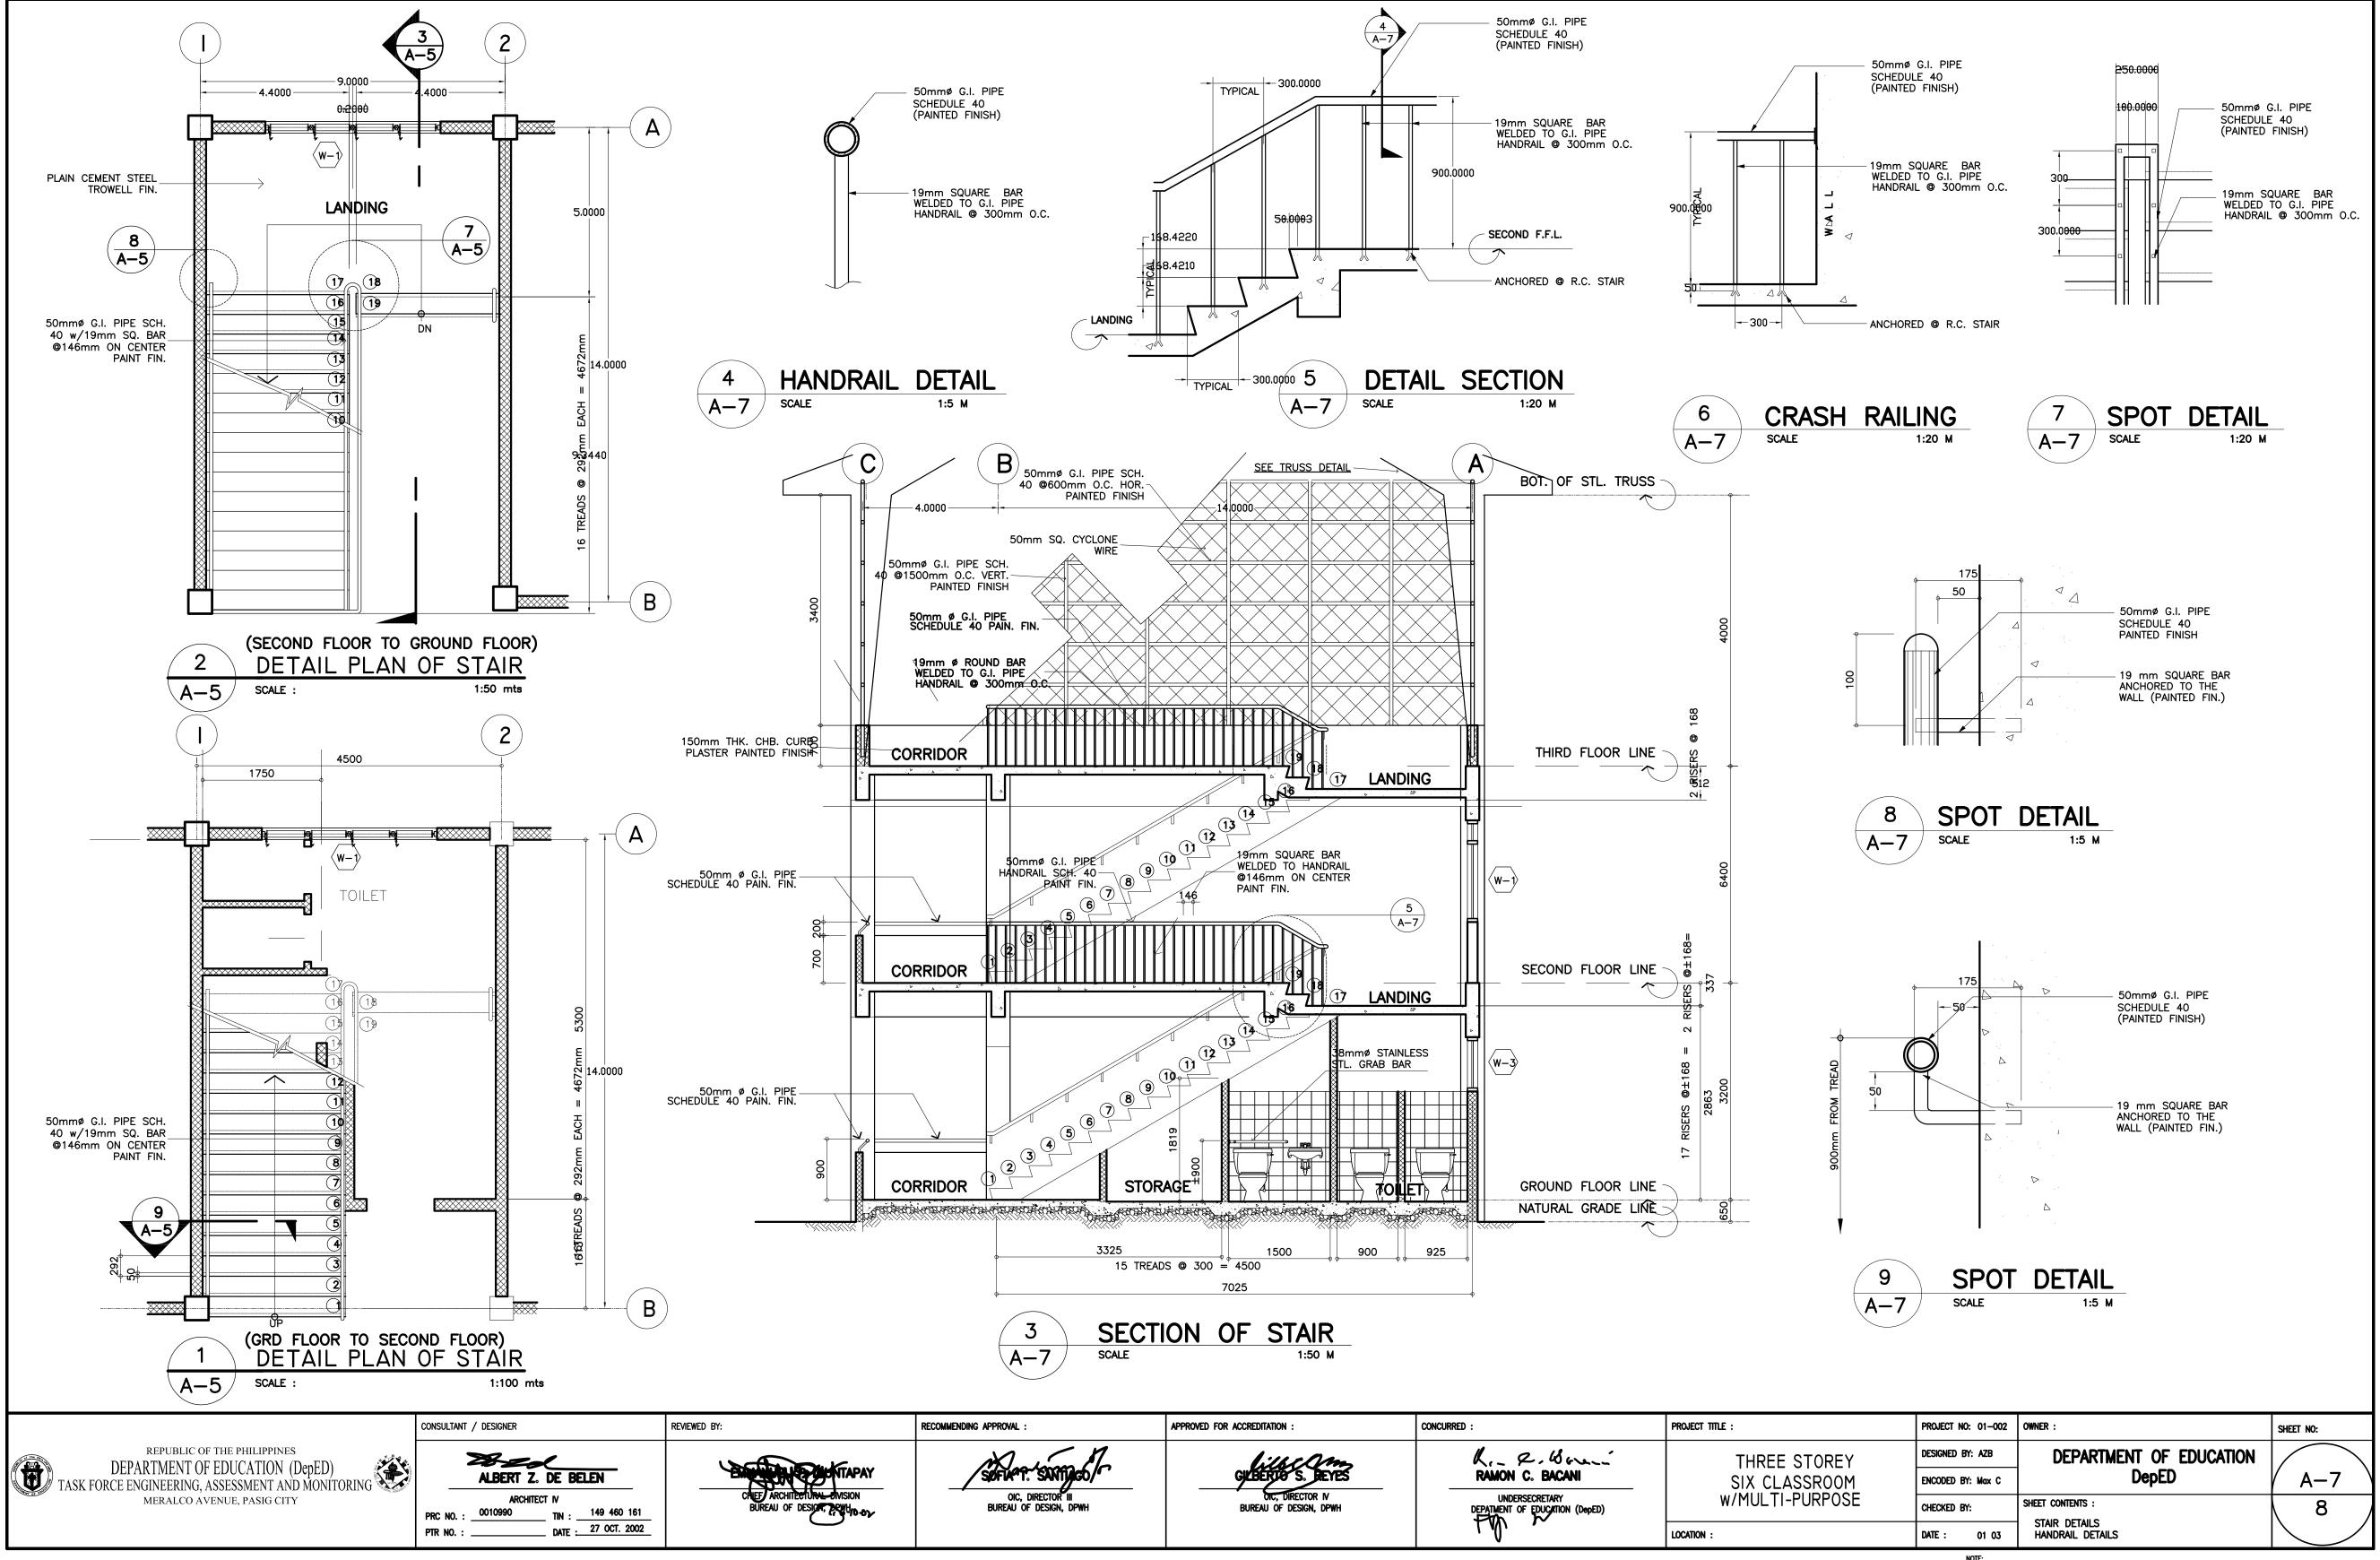

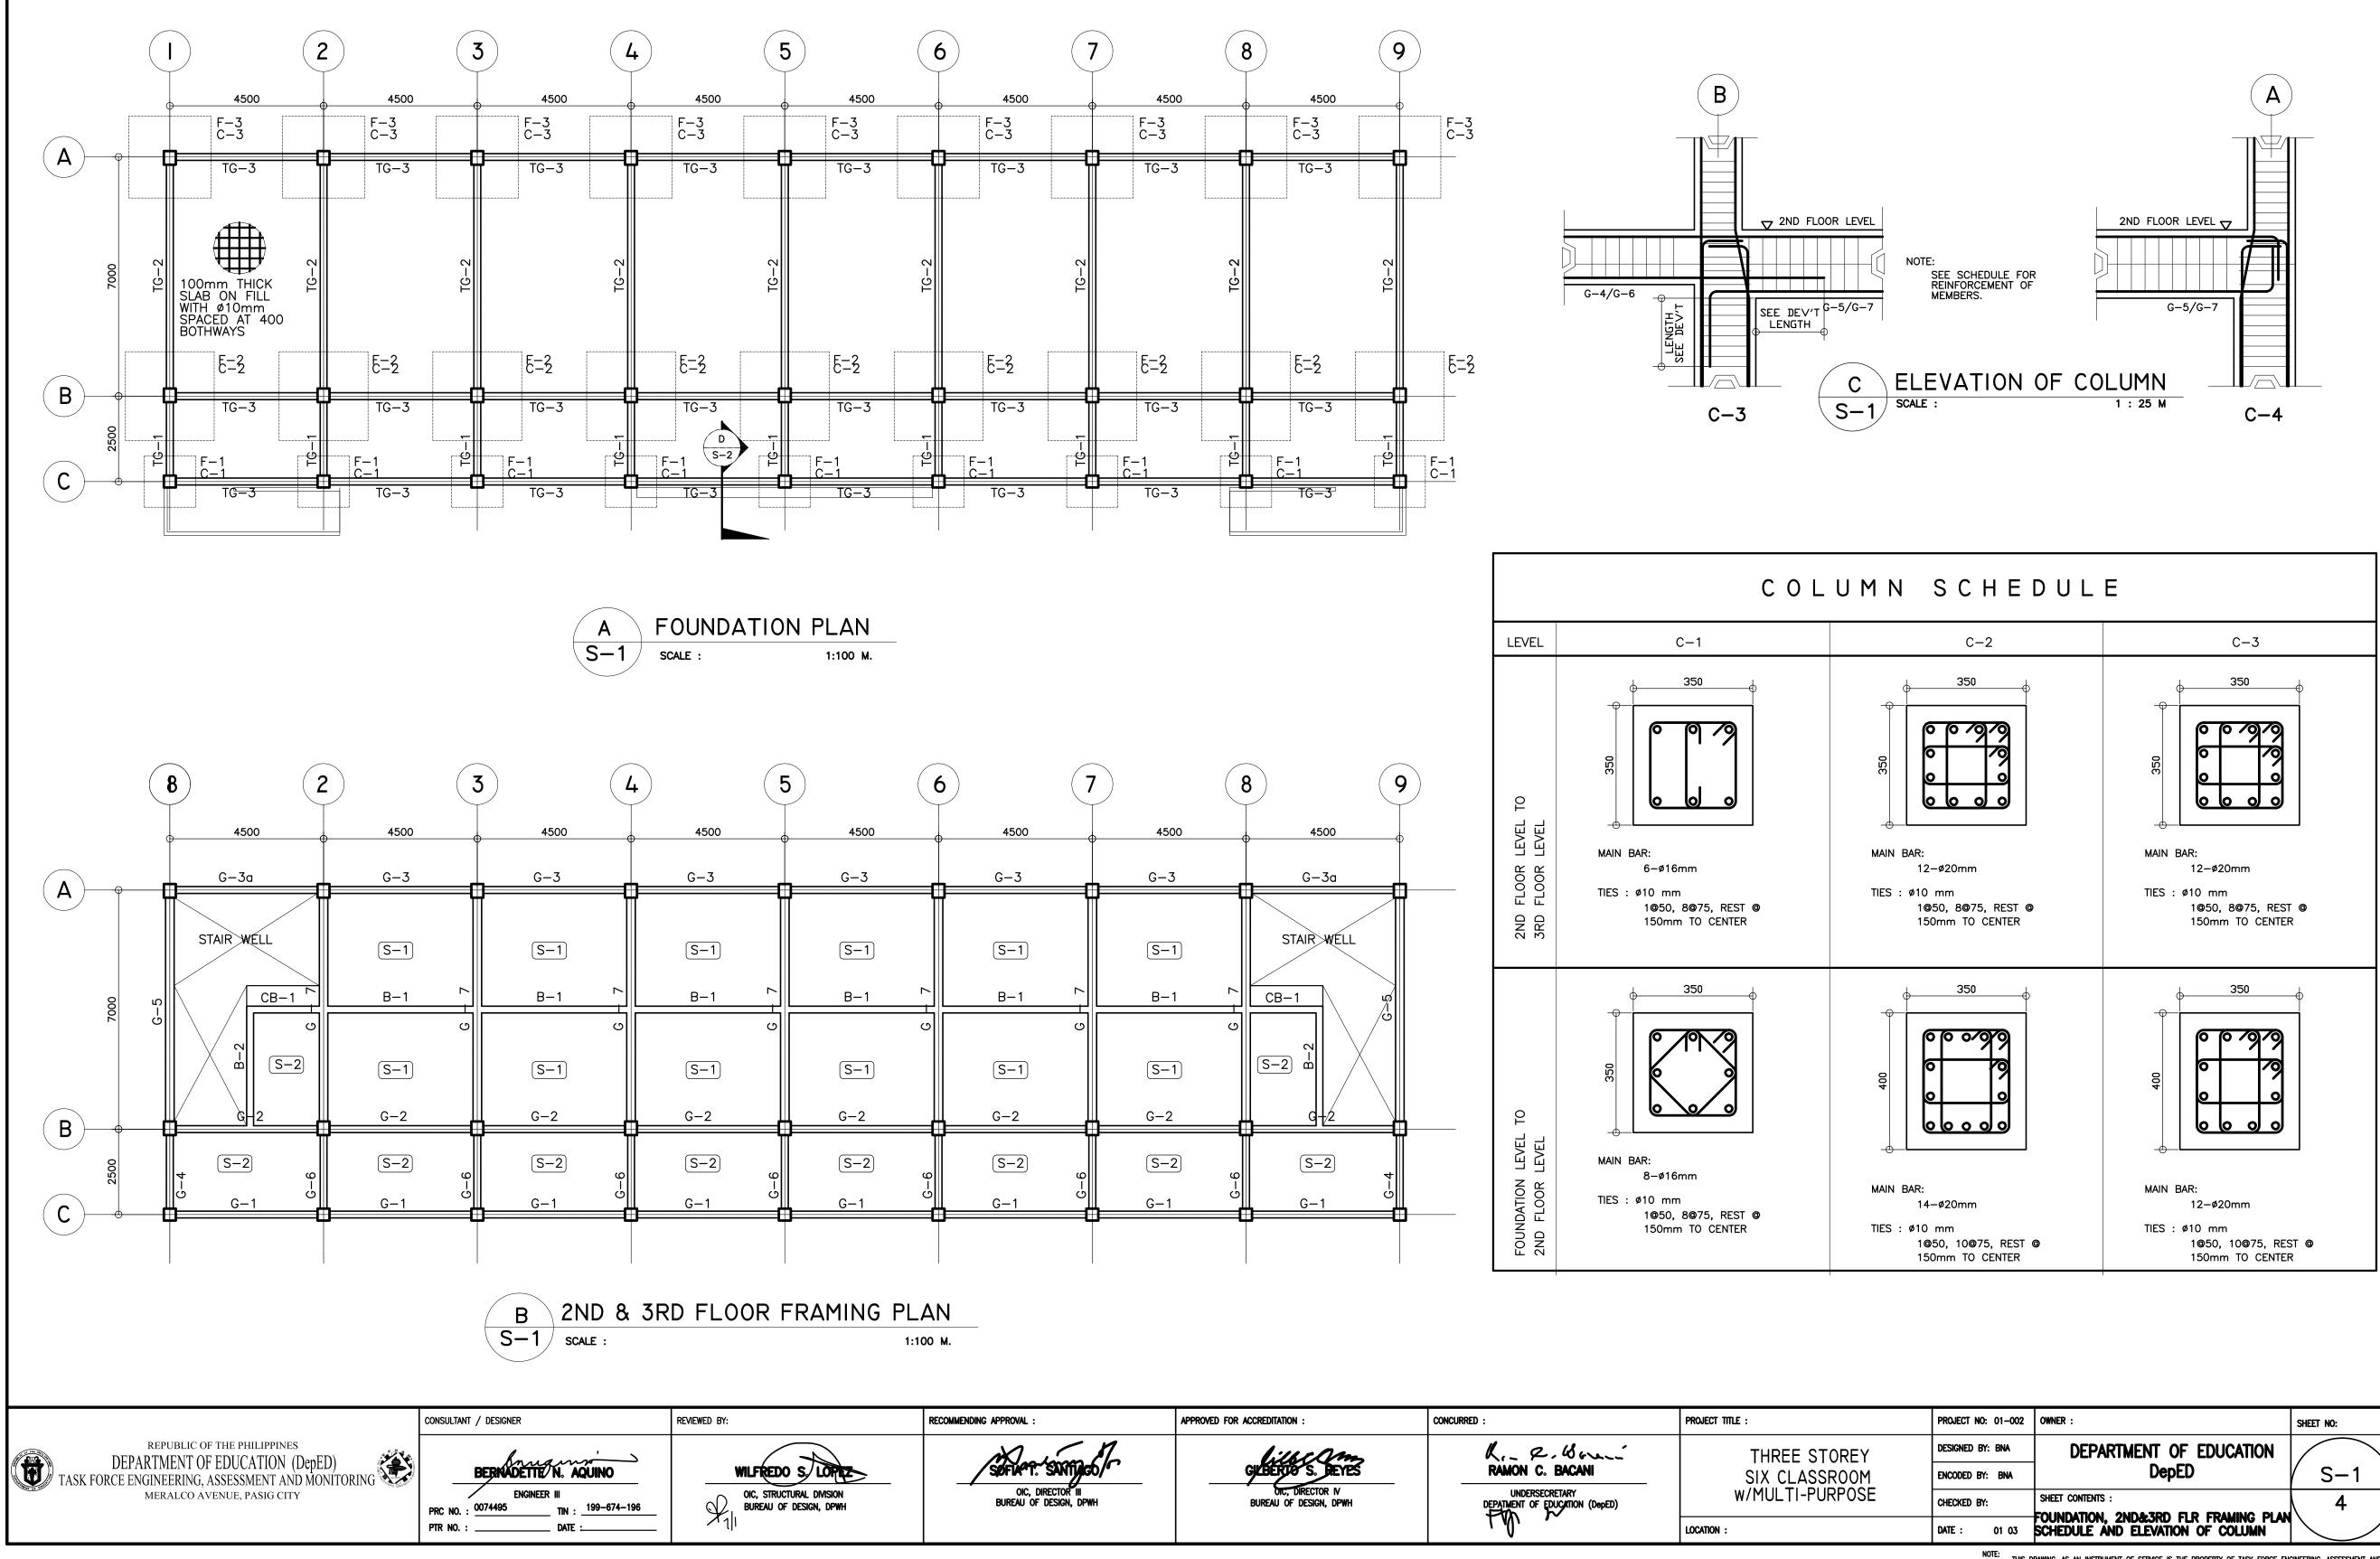


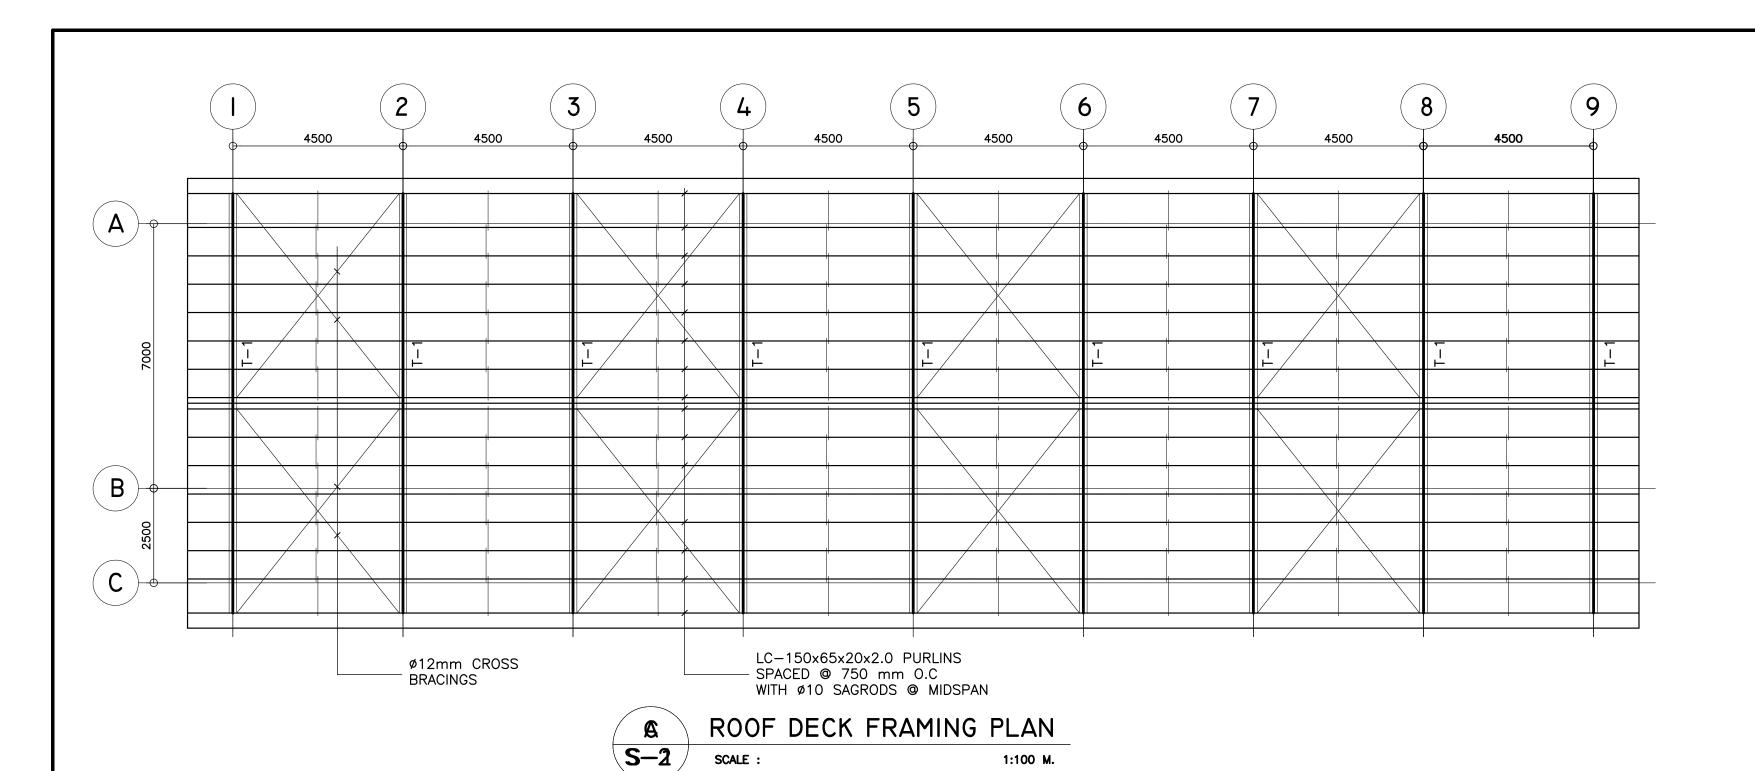


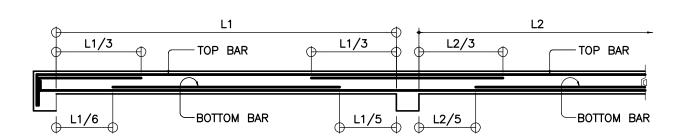

TYPICAL SLAB ELEVATION S-2


	SCHEDULE OF SLABS																	
		—	REB	REBAR SPACING ALONG SHORT DIRECTION REBAR SPACING ALONG LONG DIRECTION						ON								
FLOOR SLAB LEVEL MARK		THICK- NESS	REBAR	LEFT SUPPORT		MIDSPAN		RIGHT SUPPORT	REBAR	LEFT SUPPORT		MIDSPAN		RIGHT SUPPORT		REMARKS		
		in	in mm	SIZE	ТОР	вотт.	ТОР	вотт.	ТОР	вотт.	SIZE	ТОР	вотт.	ТОР	вотт.	ТОР	вотт.	
ר ם																		
OND	S-1	100	10ø	200	300	_	300	200	300	10ø	250	300	_	300	250	300	TWO-WAY	
SEC	S-2	100	10ø	300	300	_	300	300	300	10ø	300	300	_	300	300	300	TWO-WAY	

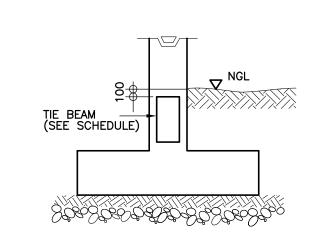


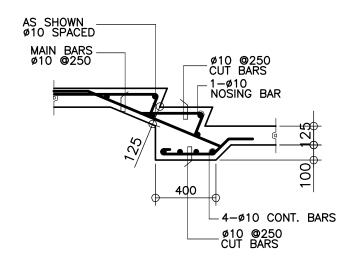


DETAIL OF TIE BEAM C S-2

DETAIL OF STAIR ON GRADE S-2 SCALE

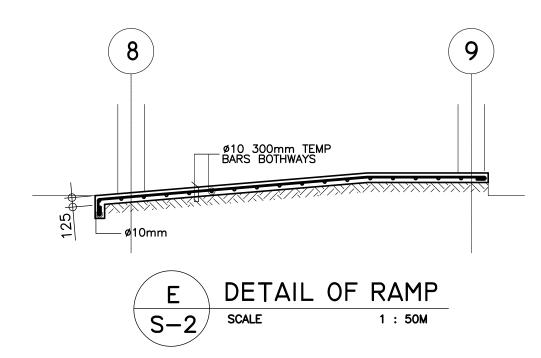


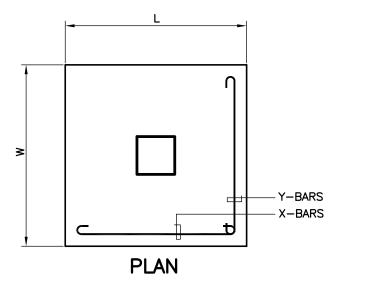

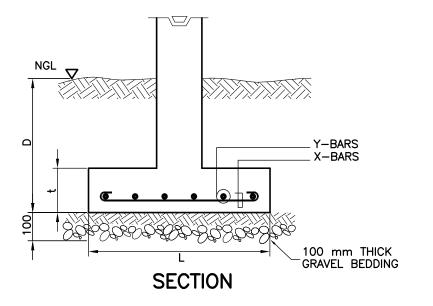



TYP. FOOTING DETAIL


	S C	HE) U L	E 0	F FO	OTING	
FOOTING	FOOTI	NG DIMEN	ISIONS (mm)	REINF	REMARKS	
MARK	LENGTH (L)	WIDTH (W)	DEPTH (D)	Thickness (t)	BAR X	BAR Y	
F-1	1500	1500	1500	250	8 — 16mmø	8 — 16mmø	SQUARE FOOTING
F-2	2600	2600	1500	350	11 – 20mmø	11 – 20mmø	SQUARE FOOTING
F-3	2400	2400	1500	300	11 – 20mmø	11 – 20mmø	SQUARE FOOTING

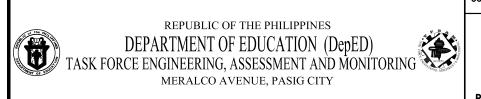

CONSULTANT / DESIGNER	
BERNADETTE	N. AQUINO
ENGINEER	• •••
PRC NO. : 0074495	_ TIN : <u>199-674-196</u>
PTR NO. :	

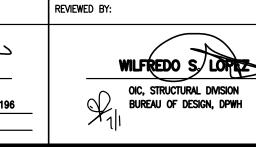

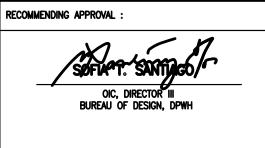

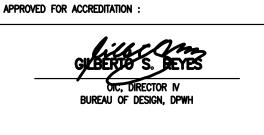


CONCUI	RRED:	
	RAMON C. BACANI	
	UNDERSECRETARY DEPATMENT OF EDUCATION (DepED)	

PROJECT TITLE :
THRE SIX C w/MUL
LOCATION:


E:	PROJECT NO: 01-002	OWNER:
THREE STOREY	DESIGNED BY: BNA	DEPARTMEN
SIX CLASSROOM	ASSROOM ENCODED BY: BNA	
w/MULTI-PURPOSE	CHECKED BY:	SHEET CONTENTS :
	DATE	ROOF FRAMING, SC


PROJECT NO: 01-002	OWNER:	
PROJECT NO: UT-002	OWNER:	SHEET NO:
DESIGNED BY: BNA	DEPARTMENT OF EDUCATION	
ENCODED BY: BNA	DepED	√ S−2
CHECKED BY:	SHEET CONTENTS:	4
DATE : 01 03	ROOF FRAMING, SCHED OF SLAB&FOOTING DET OF TIE BEAM, STAIR ON GRADE&RAMP	

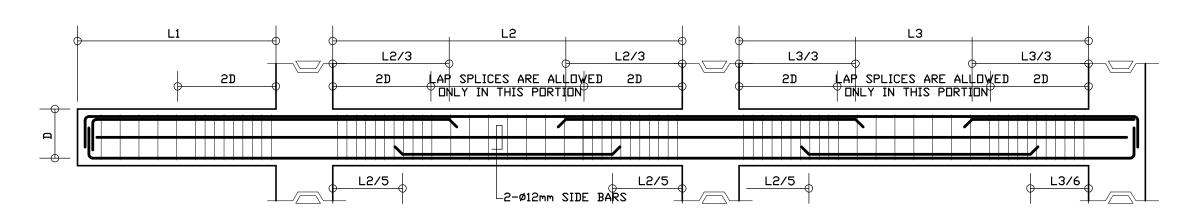


TYPICAL BEAM ELEVATION


			В	E A	M	S	С	H E	D	U L	E
FI 005	DE414	BI	EAM NSIONS	ST	EEL	REI	NFO	RCE	MEN	TS	STIRRUPS
FLOOR LEVEL	BEAM MARK		mm)	REBAR	LEFT	•	MID	SPAN	RIGHT		ø10mm
		b	h	(mm ø)	TOP	воттом	TOP	воттом	TOP	воттом	(UNLESS NOTED OTHERWISE)
	G-1	200	400	ø20mm	3	2	2	2	3	2	1@50, 6@100, REST@200
	G-2	200	400	ø20mm	4	3	2	2	4	3	1@50, 6@100, REST@200
	G-3	200	400	ø20mm	3	3	2	2	3	3	1@50, 6@100, REST@200
	G-4	200	400	ø20mm	3	2	2	2	6	4	1@50, 6@100, REST@200
LEVEL	G-5	250	500	ø20mm	6	4	2	4	6	4	1@50, 8@100, REST@200
	G-6	200	400	ø20mm	4	3	2	2	6	4	1@50, 6@100, REST@200
FLOOR	G-7	250	500	ø20mm	6	4	2	6	6	4	1@50, 8@100, REST@200
2ND	B-1	200	400	ø16mm	4	2	2	2	4	2	1@50, 6@100, REST@200
21	B-2	200	400	ø16mm	2	2	2	4	2	2	1@50, 6@100, REST@200
	CB-1	200	400	ø16mm	4	2	4	2	4	2	1@50, 6@100, REST@200
	G-1	200	400	ø20mm	2	2	2	2	2	2	1@50, 6@100, REST@200
	G-2	200	400	ø20mm	3	2	2	2	3	2	1@50, 6@100, REST@200
	G-3	200	400	ø20mm	3	2	2	2	3	2	1@50, 6@100, REST@200
급	G-4	200	400	ø20mm	3	2	2	2	5	3	1@50, 6@100, REST@200
LEVEL	G-5	250	500	ø20mm	5	3	2	4	5	3	1@50, 8@100, REST@200
A.C	G-6	200	400	ø20mm	3	2	2	2	6	4	1@50, 6@100, REST@200
FLO	G-7	250	500	ø20mm	6	4	2	6	6	4	1@50, 8@100, REST@200
3RD 1	B-1	200	400	ø16mm	4	2	2	2	4	2	1@50, 6@100, REST@200
35	B-2	200	400	ø16mm	2	2	2	3	2	2	1@50, 6@100, REST@200
	CB-1	200	400	ø16mm	4	2	4	2	4	2	1@50, 6@100, REST@200
	TG-1	300	500	ø20mm	5	4	2	2	6	4	1@50, 8@100, REST@200
TIE	TG-2	300	500	ø20mm	6	4	2	3	6	4	1@50, 8@100, REST@200
	TG-3	300	500	ø20mm	3	3	2	2	3	3	1@50, 6@100, REST@200
STAIR	STB-1	200	400	ø16mm	3	2	2	4	3	2	1@50, 6@100, REST@200
ST, BE											

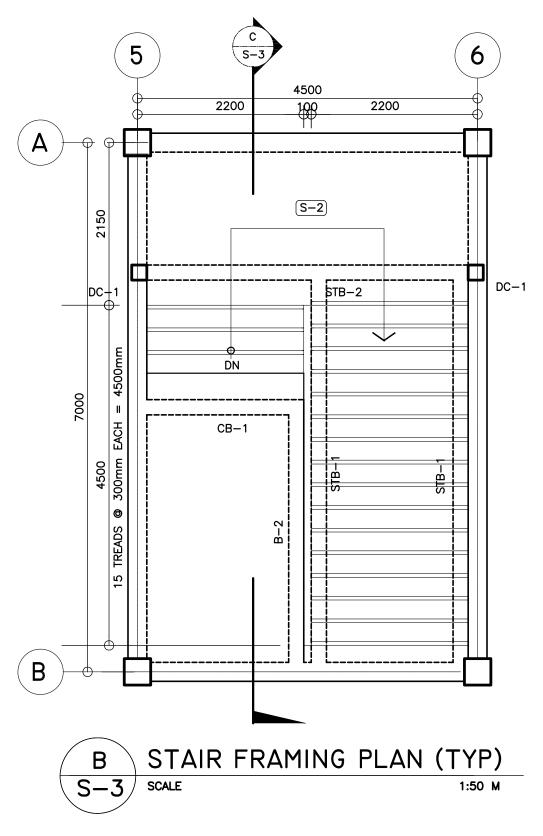


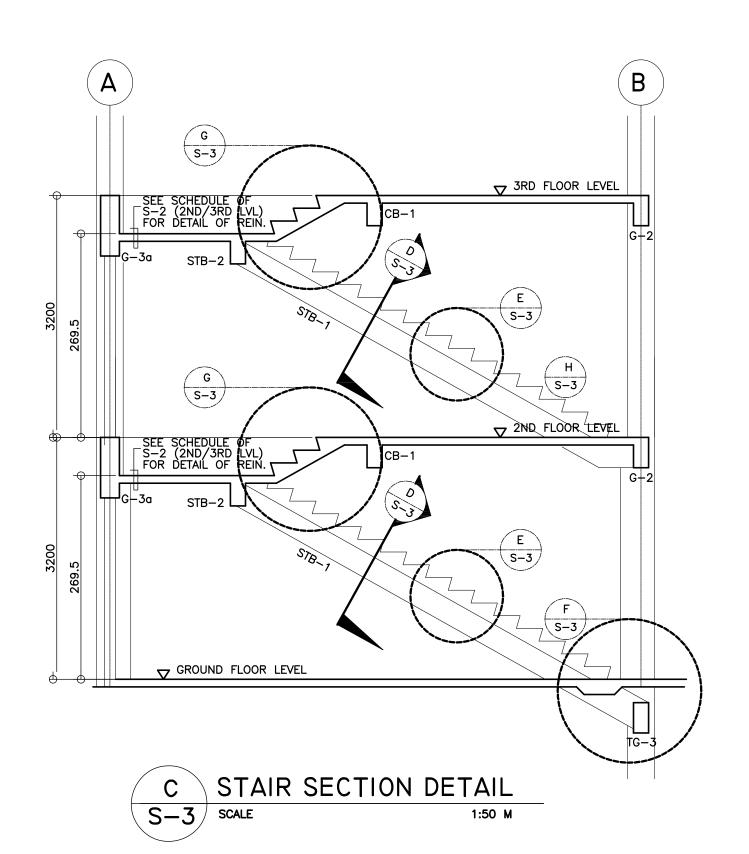


MAIN BAR: 4-ø16mm

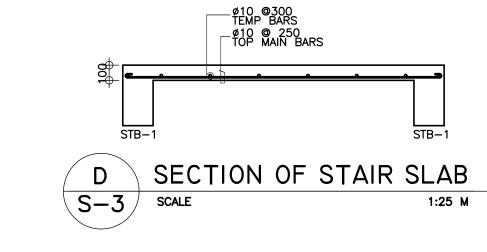


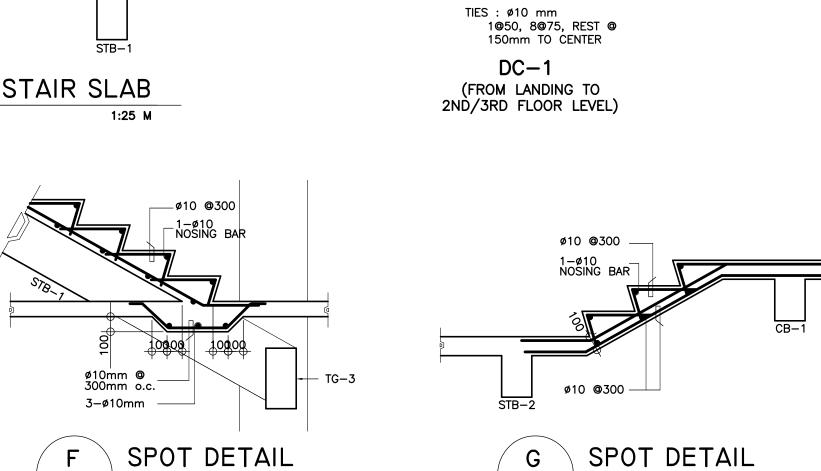

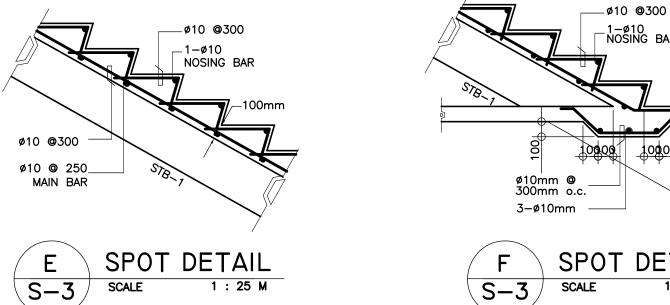

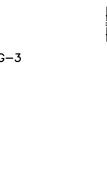



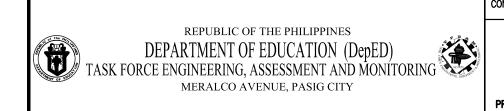


CONSULTANT / DESIGNER BERNADETTE N. AQUINO


REVIEWED BY: WILFREDO S, LOPREZ OIC, STRUCTURAL DIVISION BUREAU OF DESIGN, DPWH


RECOMMENDING APPROVAL: OIC, DIRECTOR III BUREAU OF DESIGN, DPWH APPROVED FOR ACCREDITATION : OIC, DIRECTOR IV BUREAU OF DESIGN, DPWH CONCURRED : K. 2. Bour RAMON C. BACANI UNDERSECRETARY
DEPARTMENT OF EDUCKTION (DepED)


PROJECT TITLE : THREE STOREY SIX CLASSROOM w/MULTI-PURPOSE LOCATION :

PROJECT NO: 01-002 OWNER: SHEET NO: DEPARTMENT OF EDUCATION DESIGNED BY: BNA DepED S-3ENCODED BY: BNA SHEET CONTENTS: CHECKED BY: DATE: 01 03 SCHEDULE OF BEAMS/GIRDERS DETAIL OF STAIR

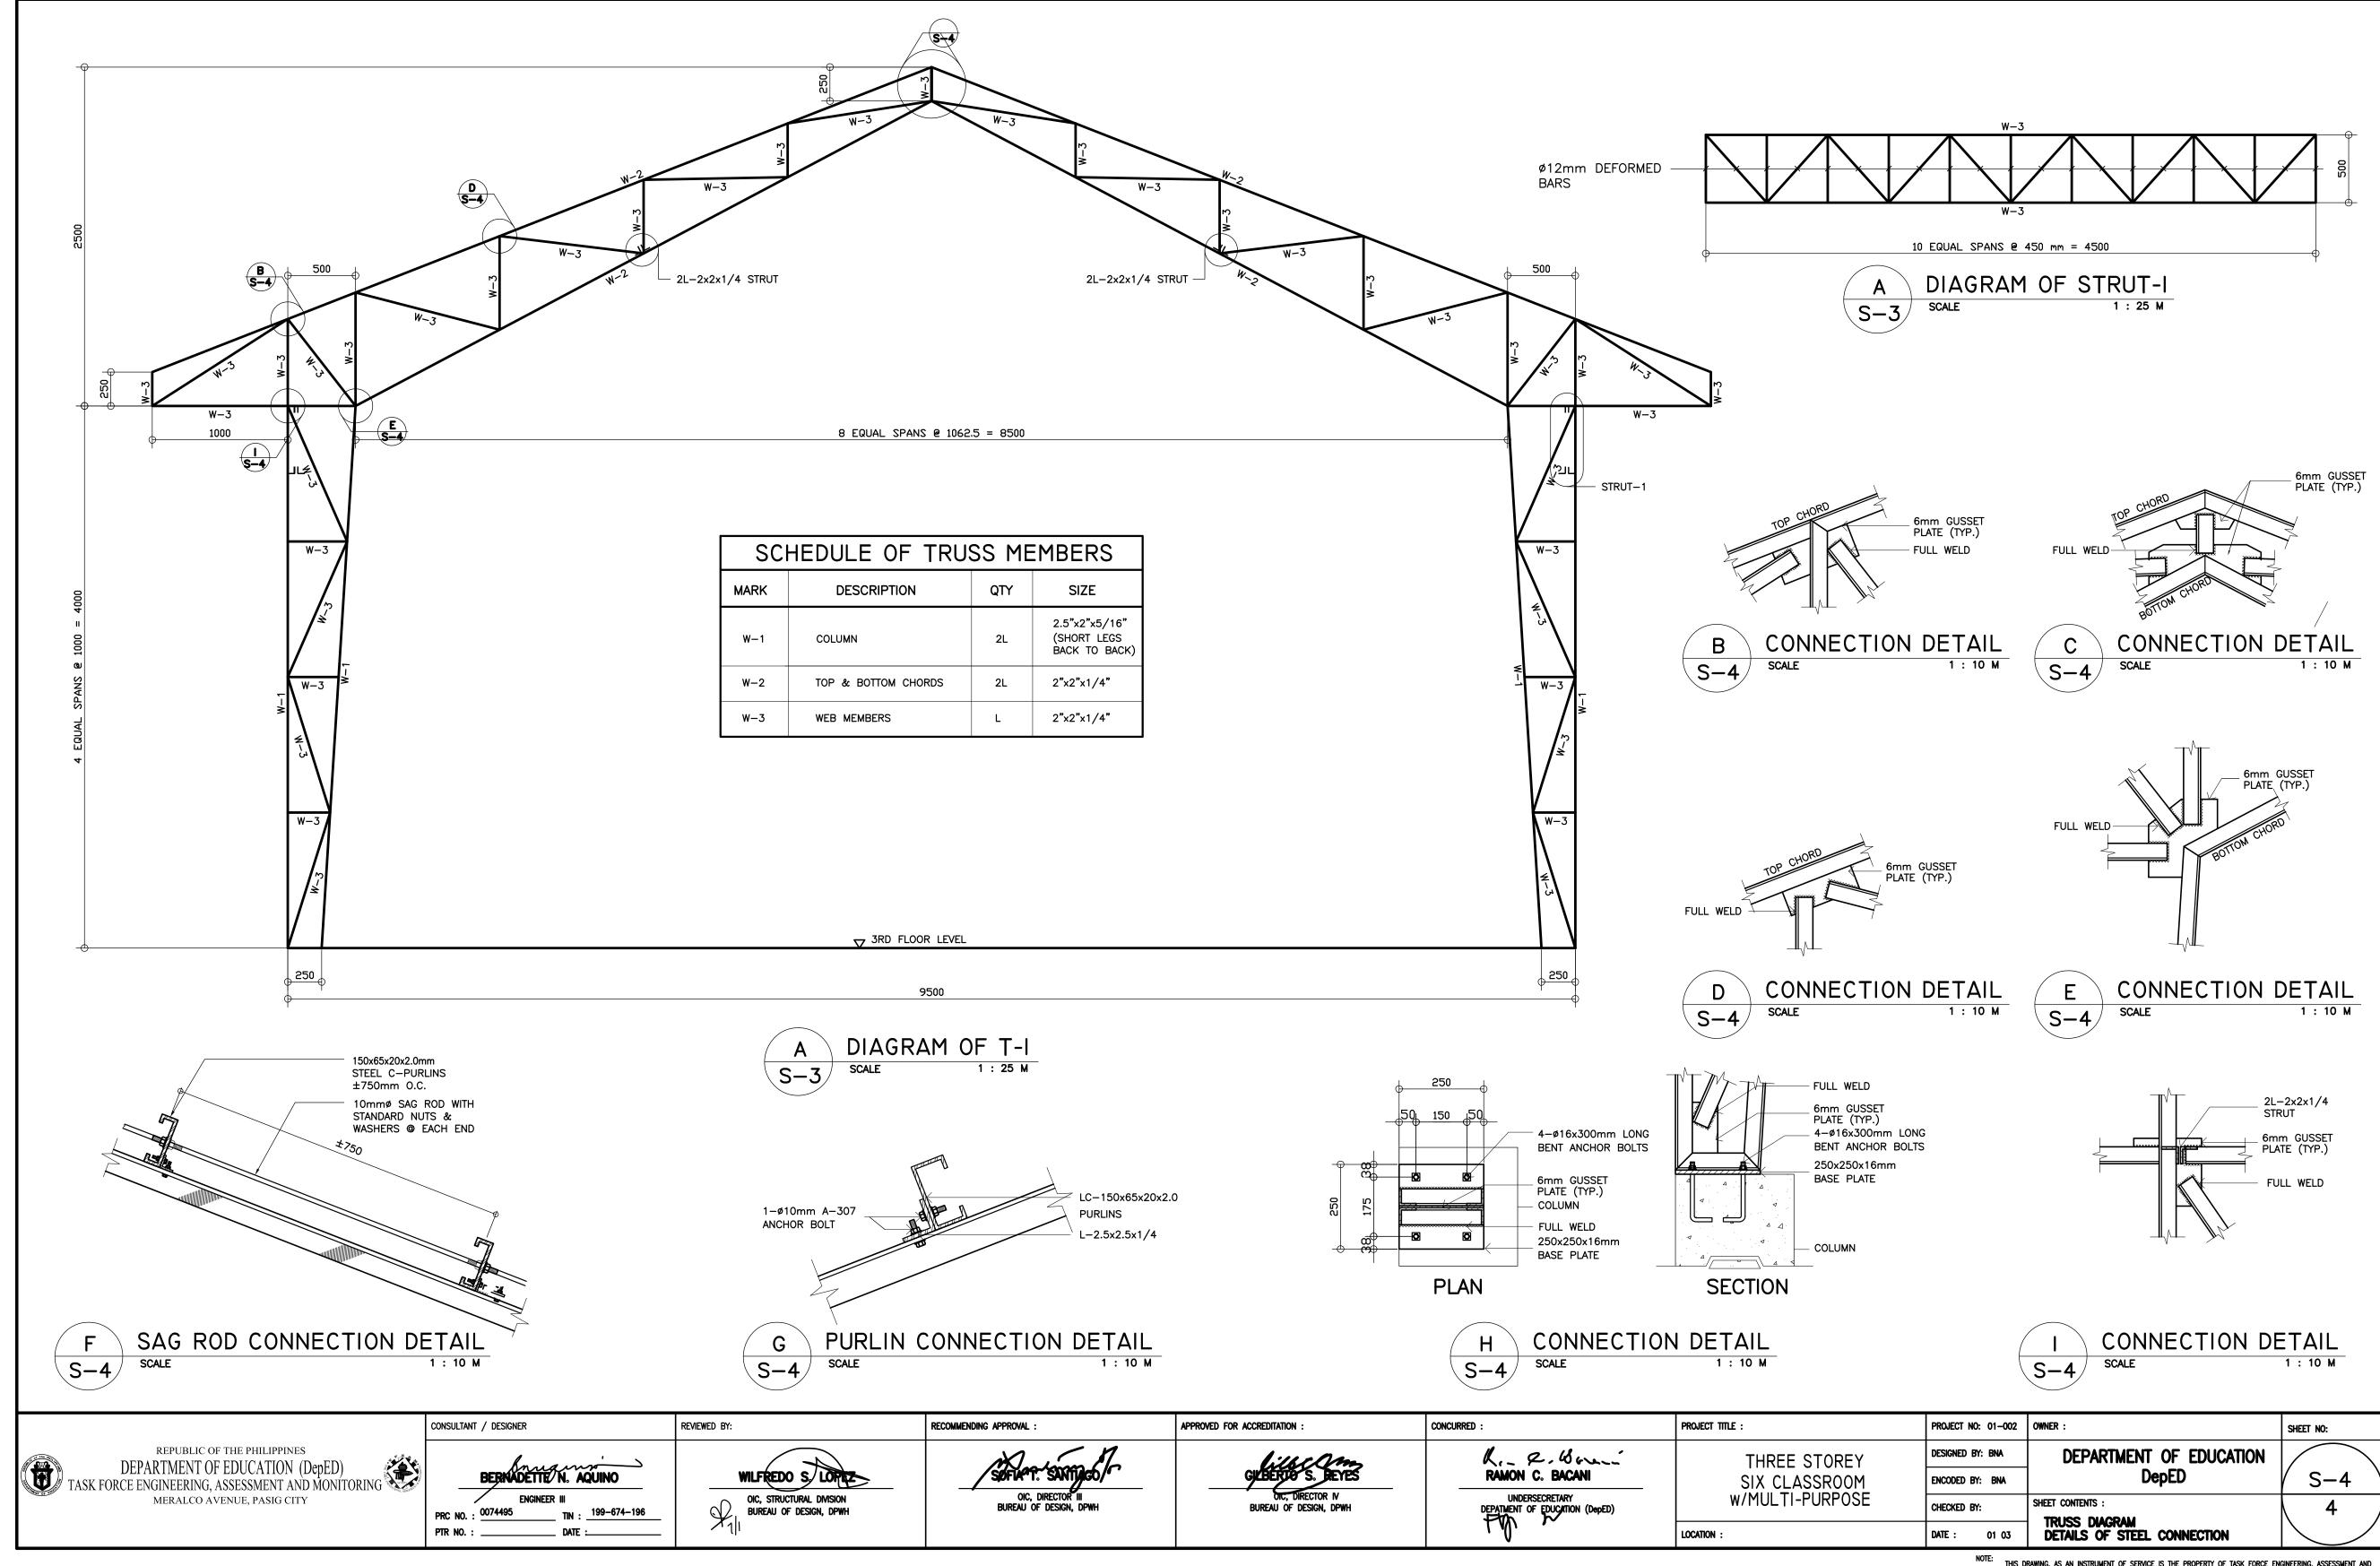

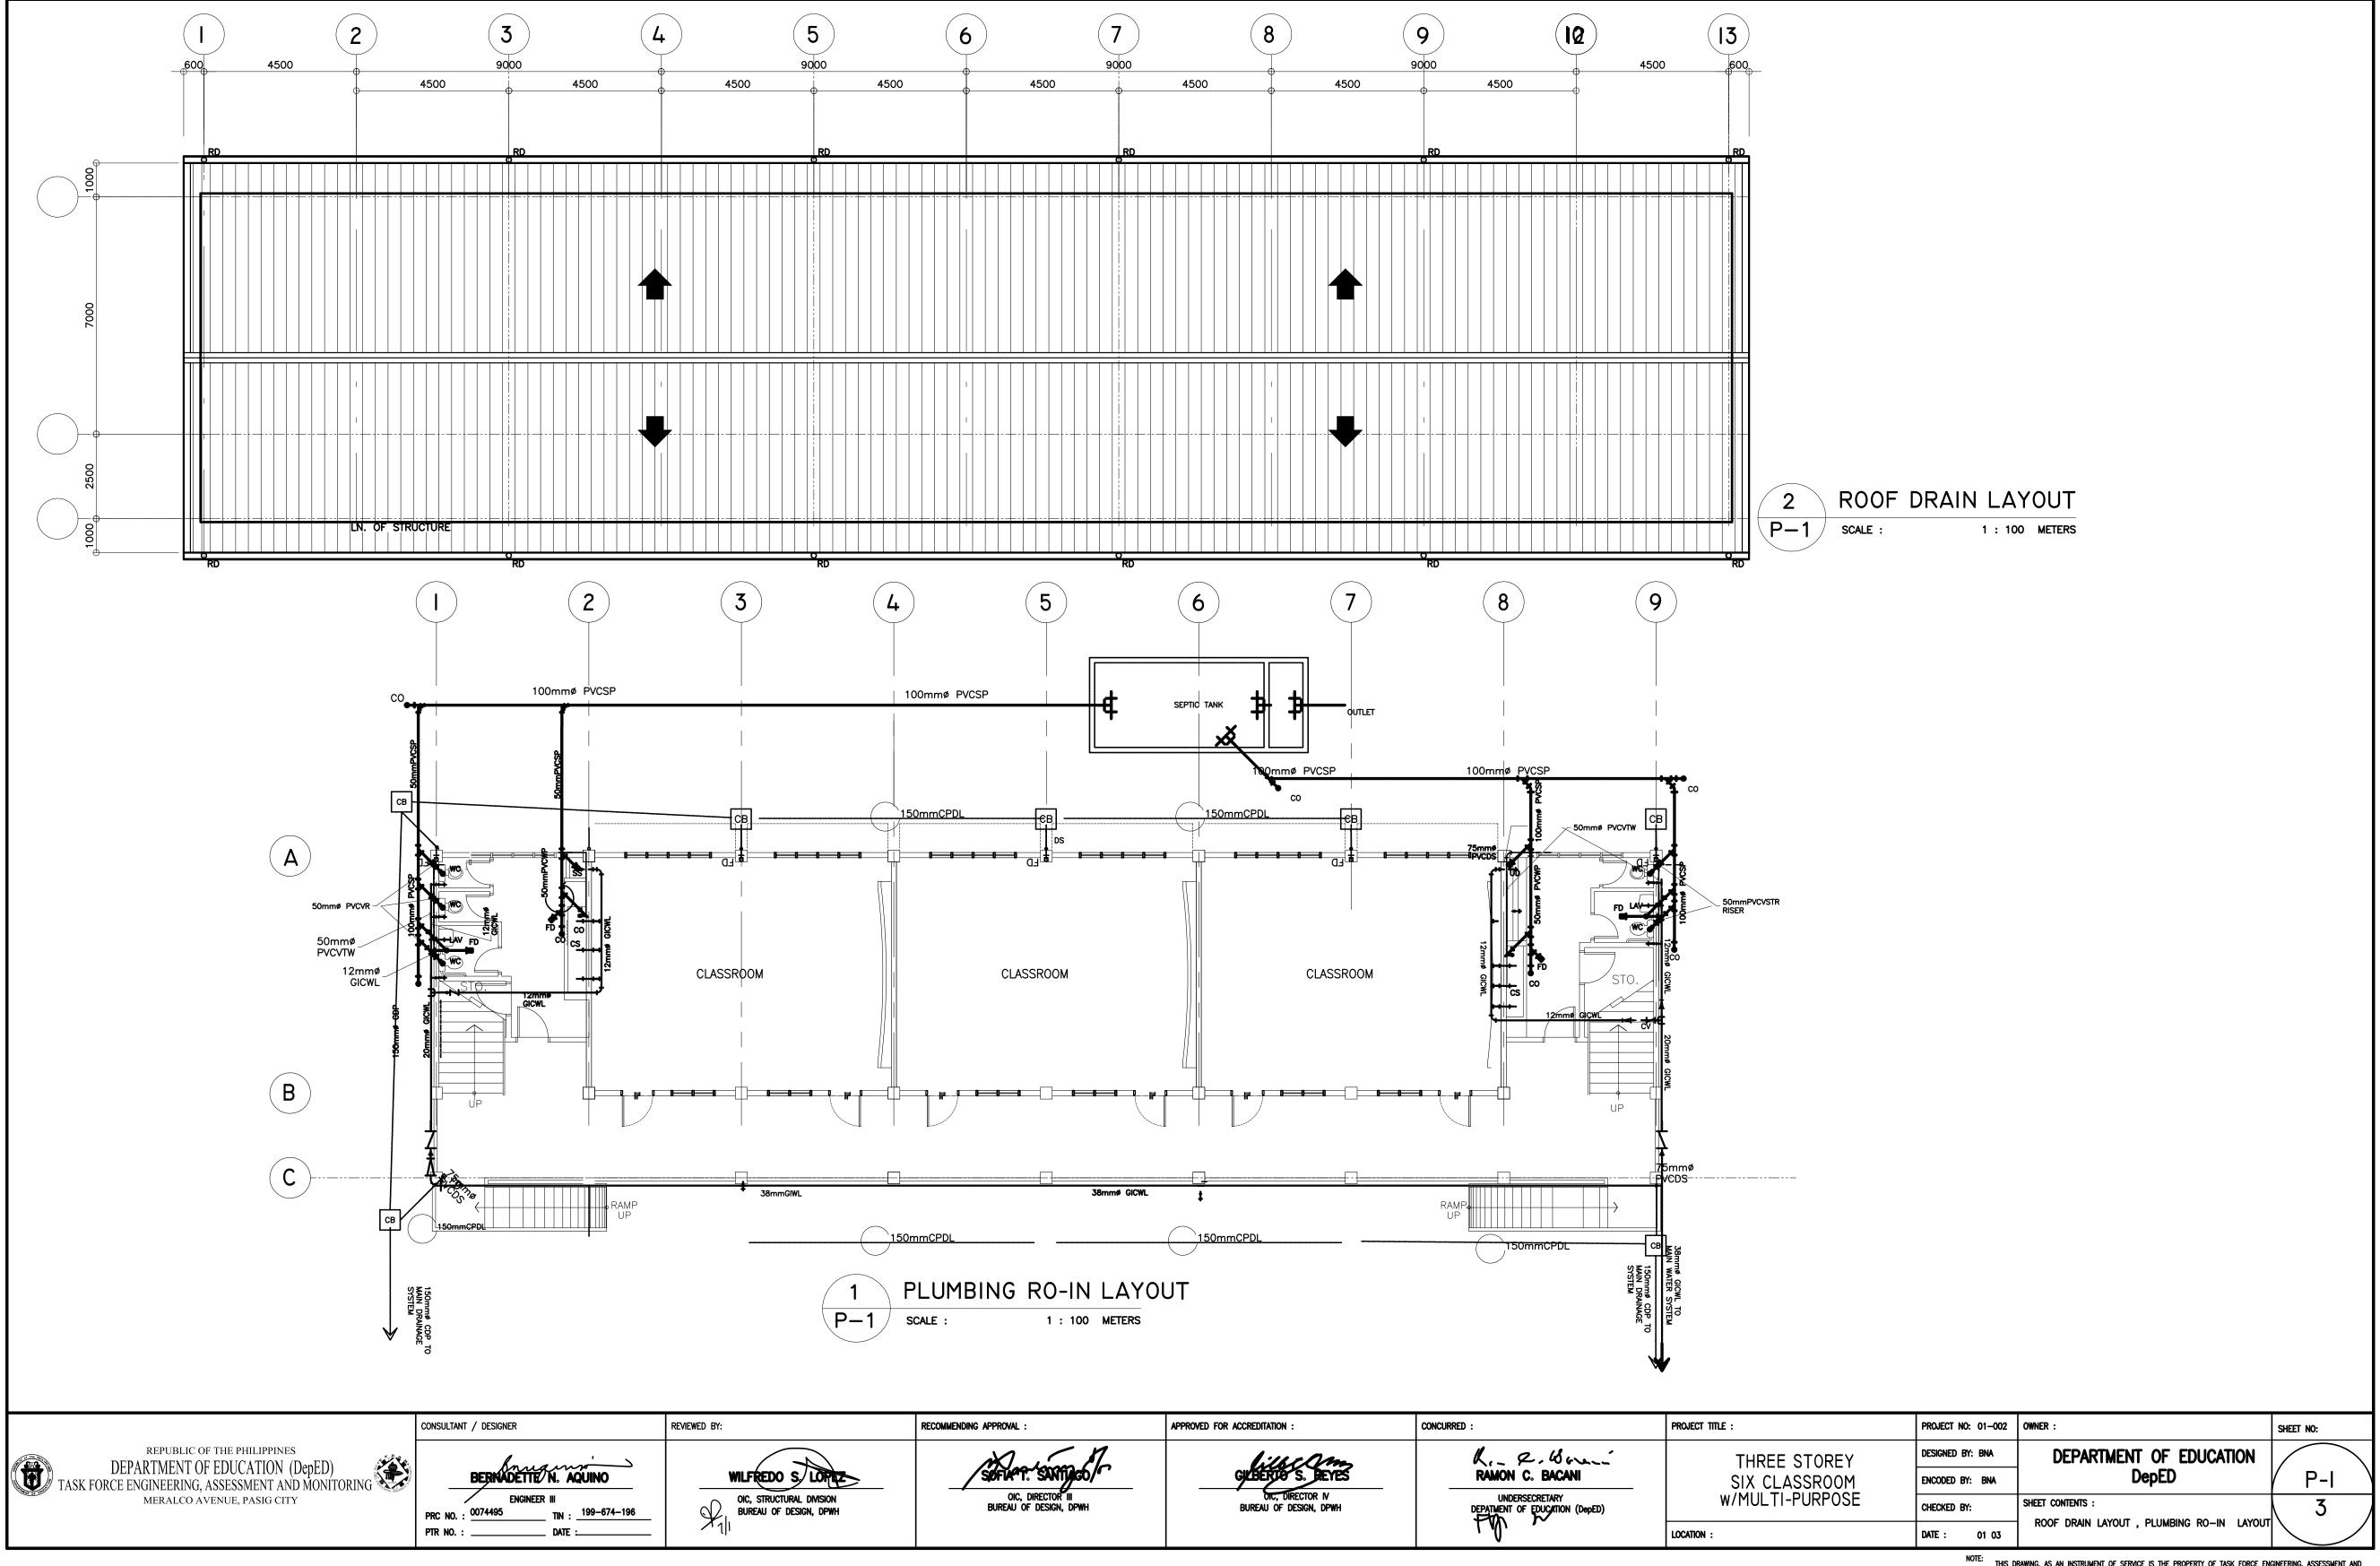

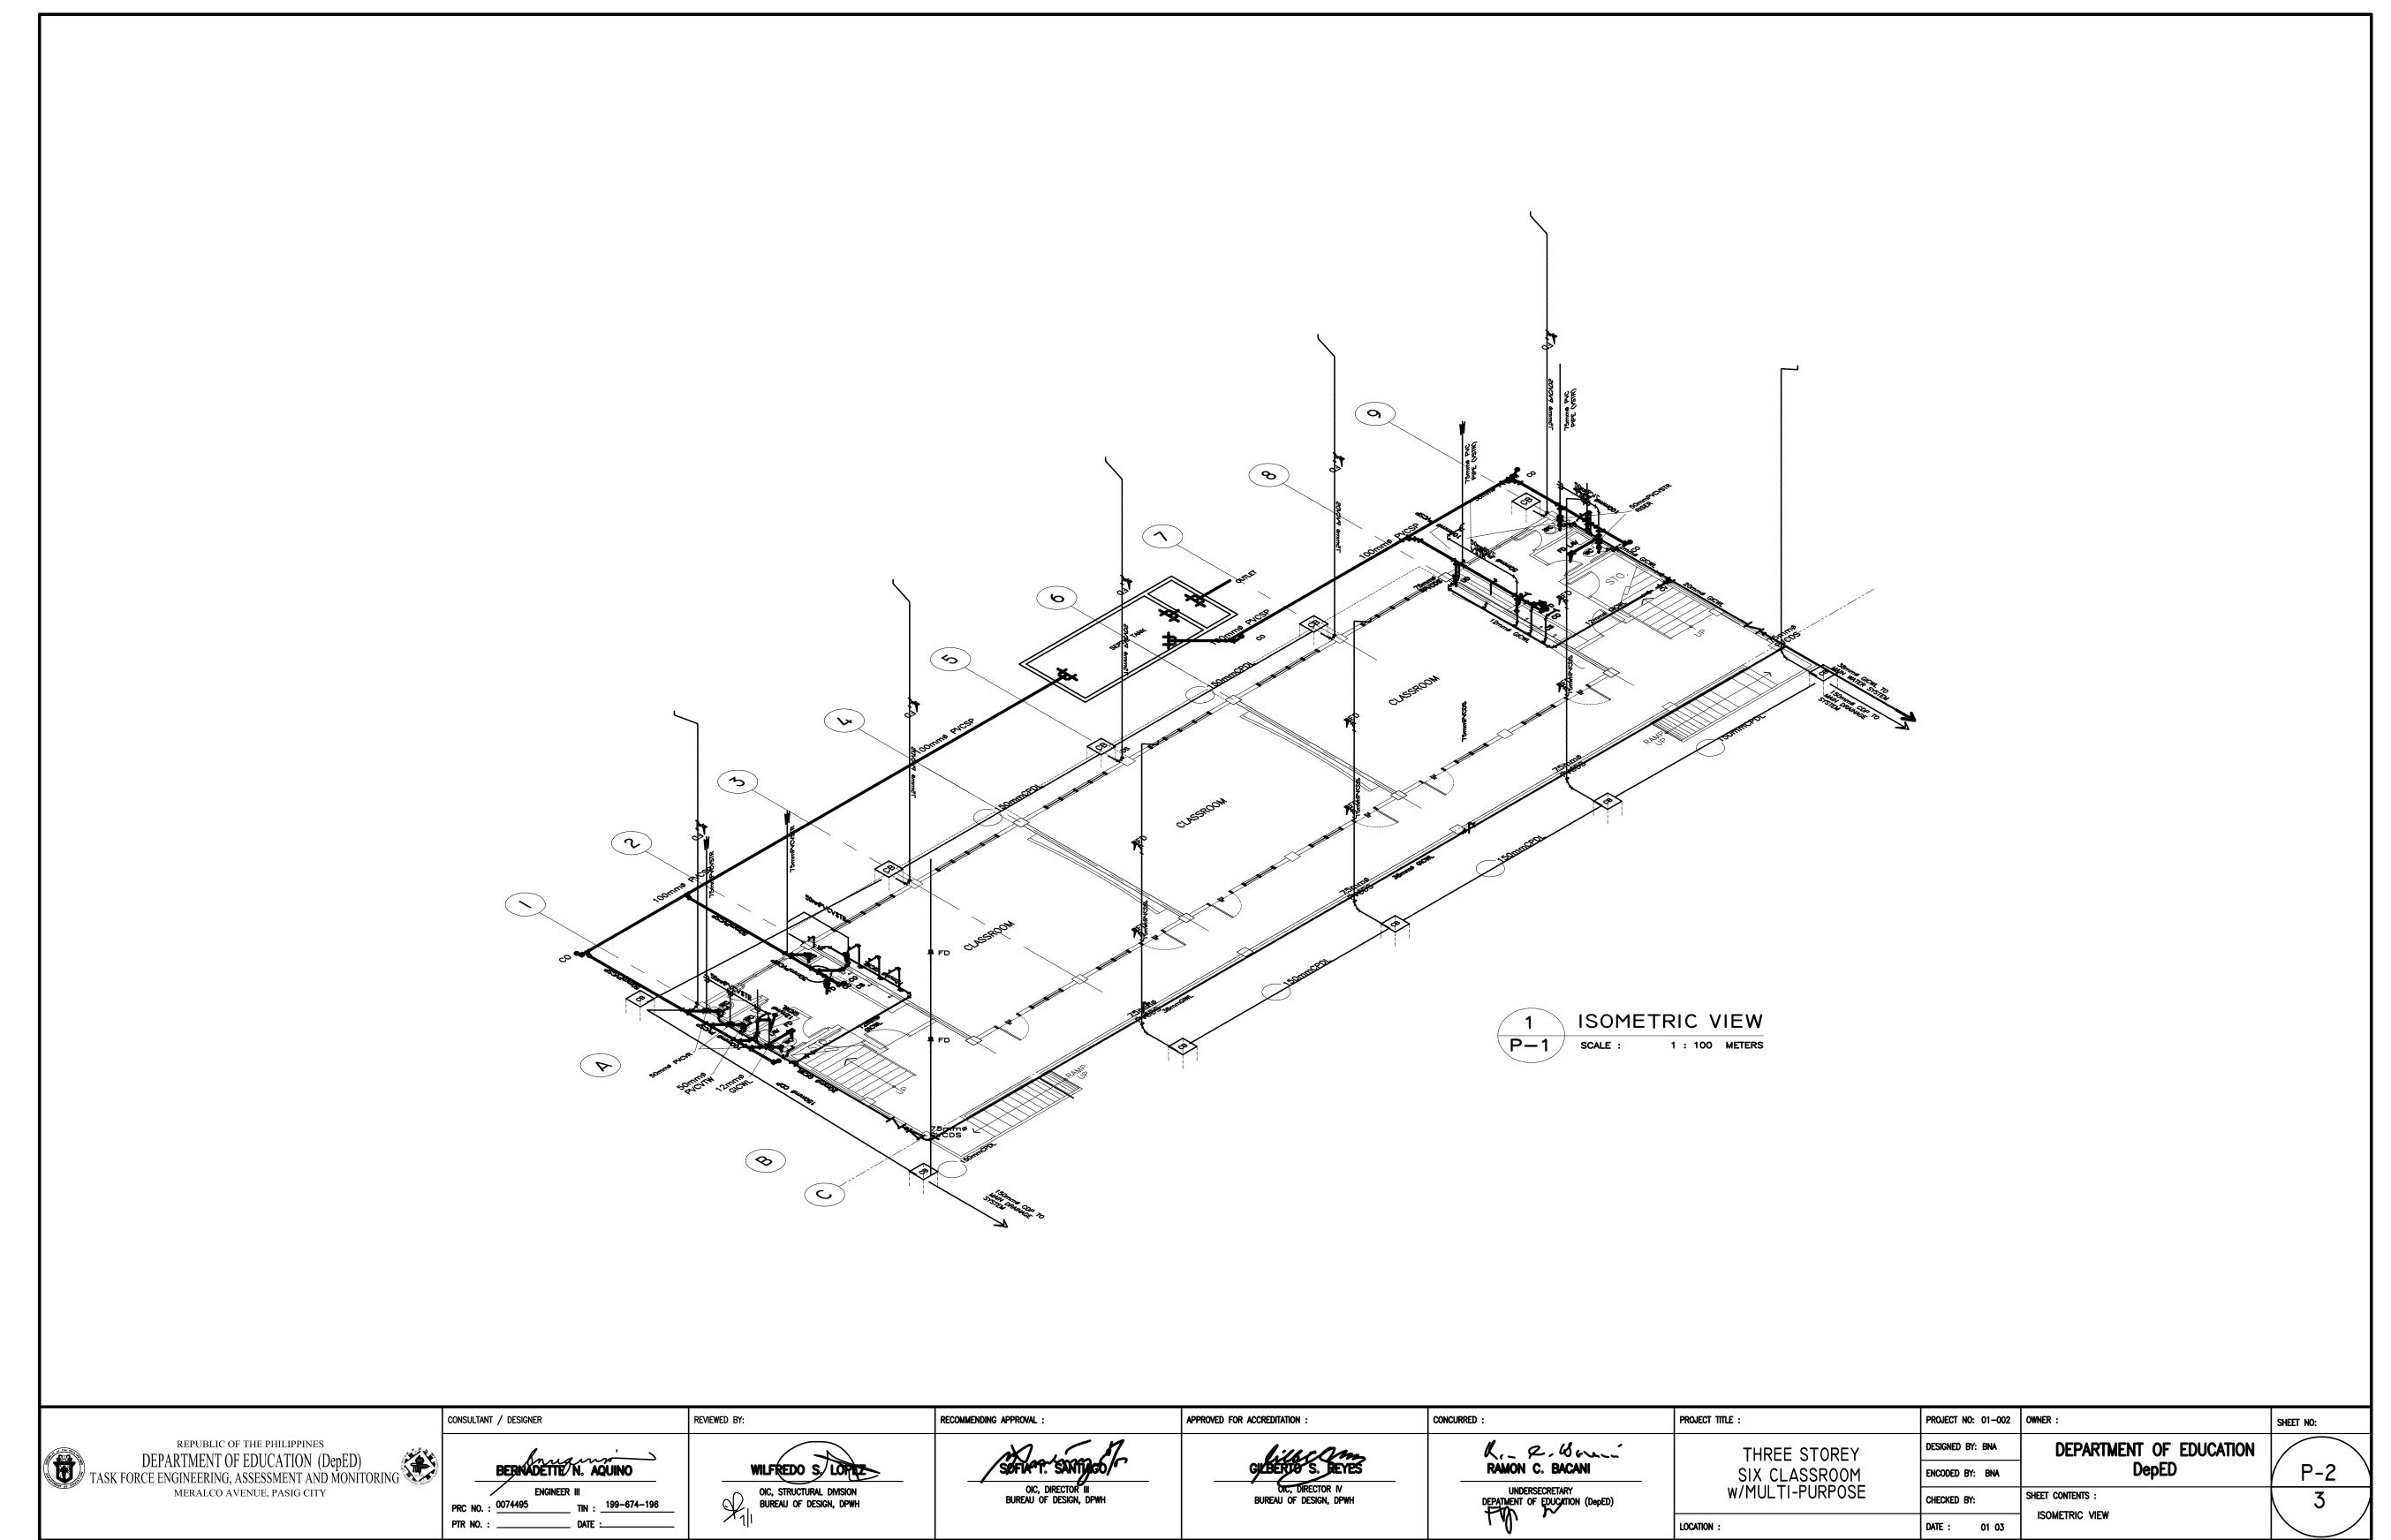

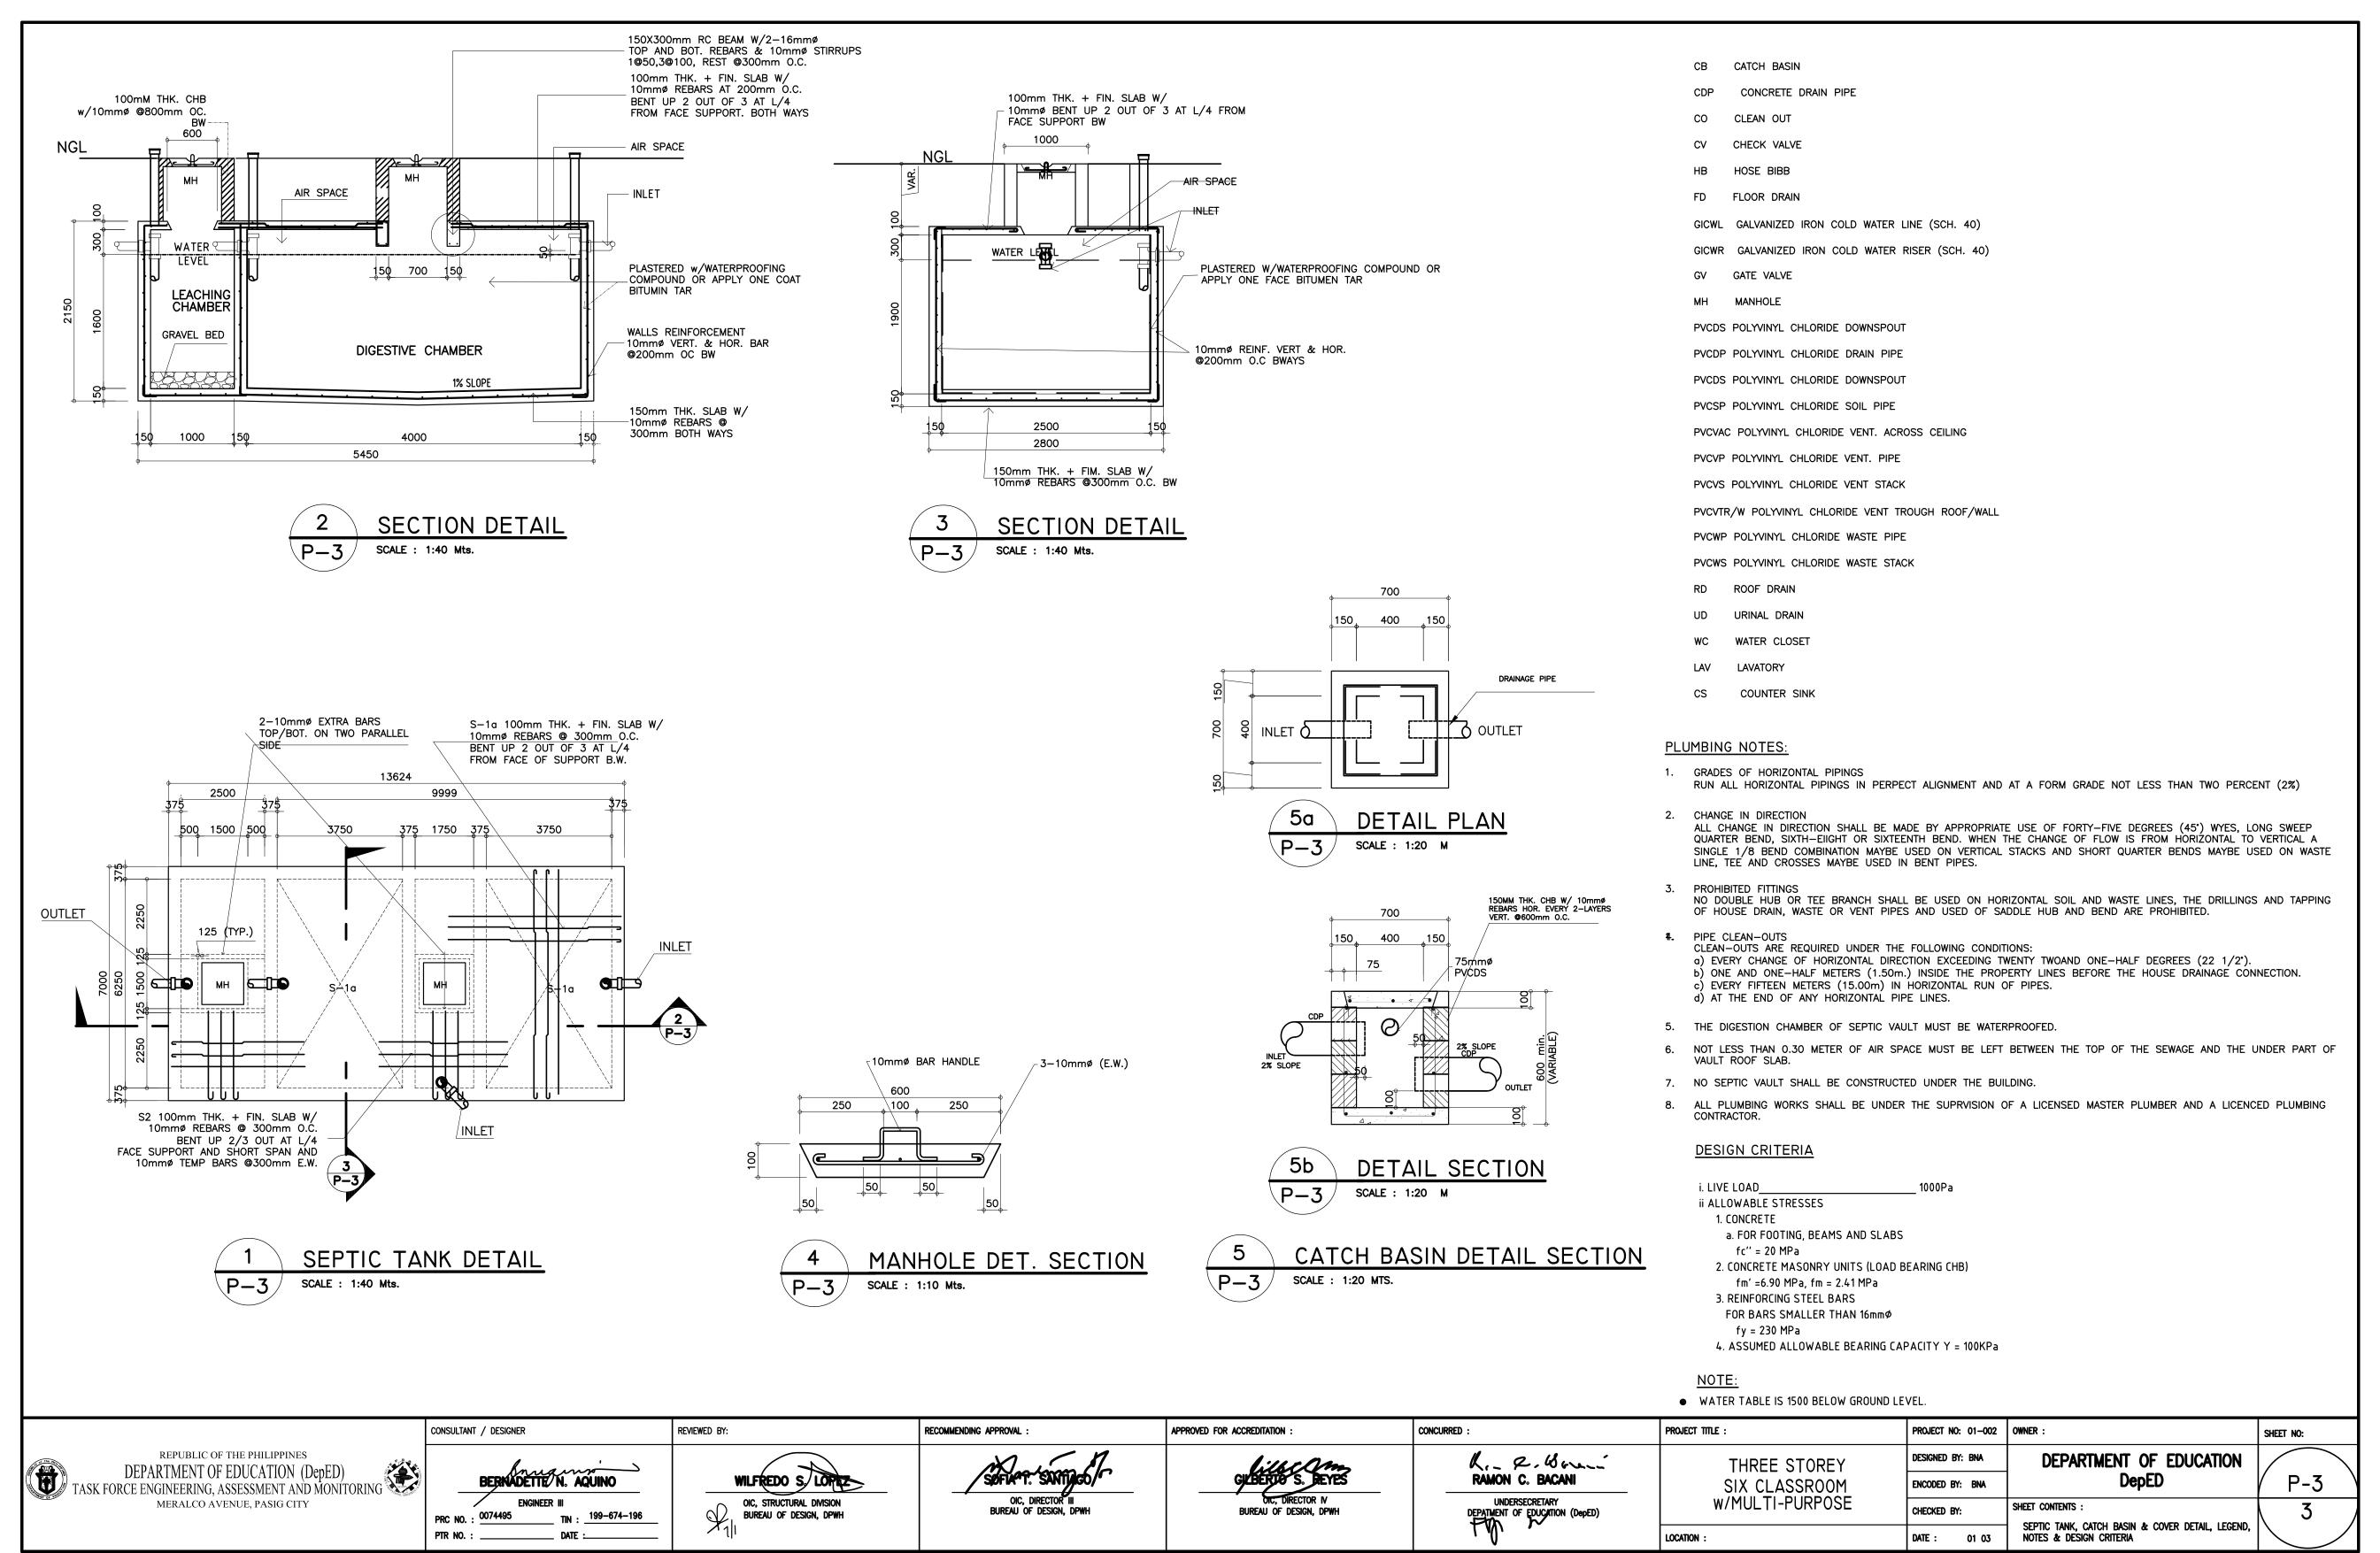

GENERAL NOTES

- 1. ALL ELECTRICAL WORKS SHALL COMPLY IN ACCORDANCE WITH THESE PLANS AND SPECIFICATIONS. THE APPLICABLE PROVISIONS OF THE LATEST EDITION OF THE PHILIPPINE ELECTRICAL CODE (PEC). THE RULES AND REGULATION OF THE LOCAL ENFORCING AUTHORITY AND THE REQUIREMENTS OF THE LOCAL POWER COMPANY. THE ELECTRICAL WORKS SHALL BE DONE UNDER THE IMMEDIATE SUPERVISION OF A DULY REGISTERED ELECTRICAL ENGINEER.
- 2. THE ELECTRICAL SERVICE POWER IS 1-PHASE, 2-WIRE, 230 V AC, 60 Hz.
- 3. WIRING METHOD SHALL BE AS FOLLOWS :

a. LIGHT SWITCH

- a. FEEDERS AND RISERS INTERMEDIATE METALLIC CONDUIT
- b. LIGHTING, POWER RECEPTACLE POLYVINYL CHLORIDE CONDUIT SCH. 40 BRANCH CKT., & AUXILIARY
- 4. ALL WIRES SHALL BE COPPER AND THERMOPLASTIC INSULATED TYPE "THW" UNLESS OTHERWISE INDICATED IN THE PLAN. THE MINIMUM SIZE OF WIRE FOR POWER AND LIGHTING CIRCUIT HOMERUN SHALL BE 3.5mm2 AND INSULATED FOR 600 VOLTS. SMALLEST RACEWAY SHALL BE 15mmØ TRADE/NOMINAL SIZE. I
- 5. ALL OUTLET BOXES SHALL BE GALVANIZED GAGE NO. 16 DEEP TYPE WITH FACTORY KNOCKOUTS.
- 6. ALL MATERIALS TO BE USED SHALL BE BRAND NEW AND APPROVED TYPE FOR THE PARTICULAR LOCATION AND PURPOSE OF USAGE.

- 1.20 M ABOVE FINISH FLOOR

- 7. GROUNDING SYSTEM SHALL BE PROVIDED TO ALL LIGHTING AND POWER CIRCUIT AS PER PHILIPPINE ELECTRICAL CODE REQUIREMENT.
- 8. MOUNTING HEIGHT OF WIRING DEVICES SHALL BE AS FOLLOWS:


b. CONVENIENCE OUTLET 0.30 M ABOVE FINISH FLOOR. c. PANELBOARD - 1.50 M ABOVE FINISH FLOOR d. FIRE ALARM STATION OUTLET - 1.50 M. ABOVE FINISH FLOOR e. PUSH BUTTON OUTLET 1.20 M ABOVE FINISH FLOOR f. FIRE ALARM & VIBRATING BELL - 0.30 M BELOW CEILING LINE

LEGEND

SYMBOL	DESCRIPTION
¤	- CEILING LIGHT OUTLET
Ø .	- 2 x 40 WATTS FLUORESCENT LAMP
F	- CEILING FAN OUTLET
S/S _a	- ONE GANG DEVICE SWITCH
Sab	- TWO GANG DEVICE SWITCH
Scde	- THREE GANG DEVICE SWITCH
S 3W	- THREE WAY DEVICE SWITCH
Sf	- FAN CONTROL SWITCH
SEF	- EXHAUST FAN SWITCH
	- RACEWAY CONDUIT CONCEALED IN CEILING
	- RACEWAY CONDUIT CONCEALED UNDER FLOOR
	- PANELBOARD
-	- CKT. BREAKER, RATING AS INDICATED
⇒	 DUPLEX CONVENIENCE OUTLET, GROUNDING TYPE 10 AMPS, 250 VOLT WITH MODERN PLATE COVER
● EF	 EXHAUST FAN OUTLET, SINGLE, GROUNDING TYPE 10 AMPS, 250 VOLT WITH MODERN PLATE COVER
(LP)	- HOMERUN DIRECT TO PANELBOARD
0	- PUSH BUTTON
	- ENCLOSED AIR CIRCUIT BREAKER
FA	- FIRE ALARM CONTROL PANEL
F	- FIRE ALARM STATION OUTLET
B	- VIBRATING BELL OUTLET
$oldsymbol{\mathbb{B}}$	- FIRE ALARM BELL
M	- SERVICE METER OVERHEAD SERVICE ENTRANCE
\Rightarrow	- SERVICE ENTRANCE CONNECTED TO 220V AC, 10, 2 WIRE, 60 Hz FITTED WITH 32mmØ TYPE "F" CONDULET
	Suilding wall


LOAD SCHEDULE

KT.		VA	CIRCUIT BREAKER					
10.	DESCRIPTION	LOAD	VOLT POLE		AT AF		- WIRE & CONDUIT SIZE	
1	CONVENIENCE OUTLET - 9x180w	1860	230	2	20	50	3.35mm² THW IN 15mmØ C	
2	CONVENIENCE OUTLET - 9x180w	1860	230	2	20	50	3.35mm² THW IN 15mmØ C	
3	CONVENIENCE OUTLET - 6x180w	1080	230	2	20	50	3.35mm² THW IN 15mmØ C	
4	LIGHTING OUTLET	1460	230	2	20	50	3.35mm² THW IN 15mmØ C	
5	LIGHTING OUTLET	1500	230	2	20	50	3.35mm² THW IN 15mmØ C	
6	LIGHTING OUTLET	1200	230	2	20	50	3.35mm² THW IN 15mmØ C	
7	LIGHTING OUTLET	1000	230	2	20	50	3.35mm² THW IN 15mmØ C	
8	LIGHTING OUTLET	1100	230	2	20	50	3.35mm² THW IN 15mmØ C	
9	LIGHTING OUTLET	1100	230	2	20	50	3.35mm² THW IN 15mmØ C	
10	SPARE	1500	230	2	20	50		
11	SPARE	1500	230	2	20	50		
	TOTAL	14680						

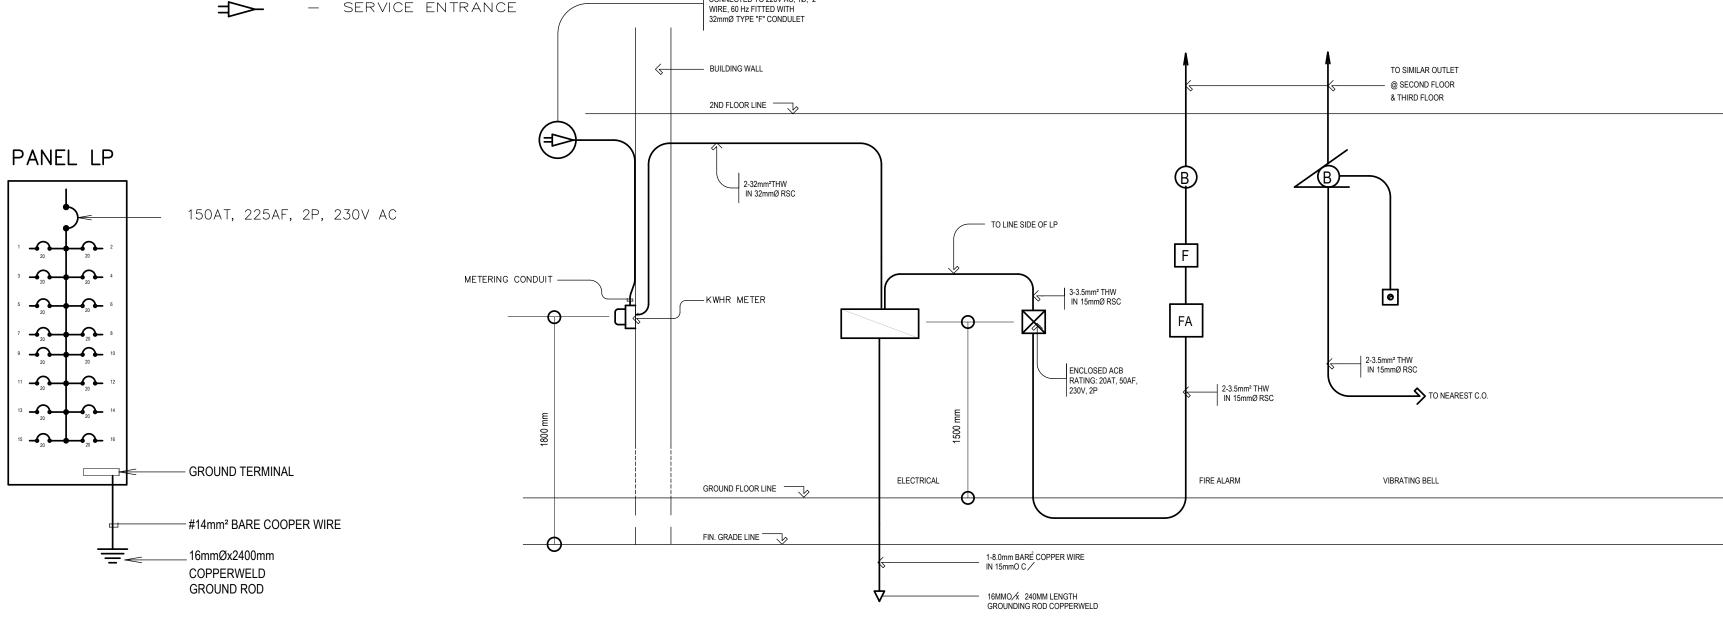



SINGLE LINE DIAGRAM


RISER DIAGRAM NOT TO SCALE

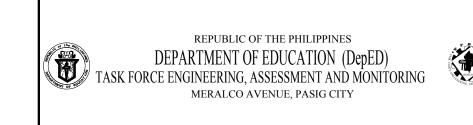


	CONSULTANT / DESIGNER
Write(1900	VENERANDO D. SAHAGUN ENGINEER III
SEESTIFFE P	PRC NO. : TIN :
	FRC NO IIN
	PTR NO. : DATE :

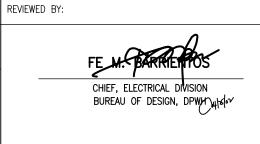

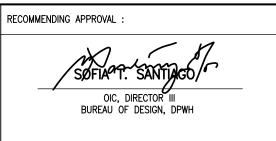


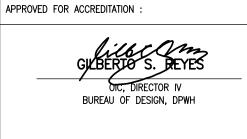

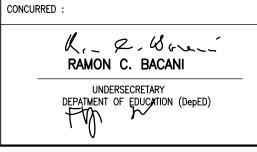


PROJECT TITLE :
THREE STOREY SIX CLASSROOM w/MULTI-PURPOSE
LOCATION:

PROJECT NO: 01-002	OWNER :
DESIGNED BY: RDS	DEPARTMENT (
ENCODED BY: Max C	Dep
CHECKED BY:	SHEET CONTENTS :
DATE	GENERAL NOTES

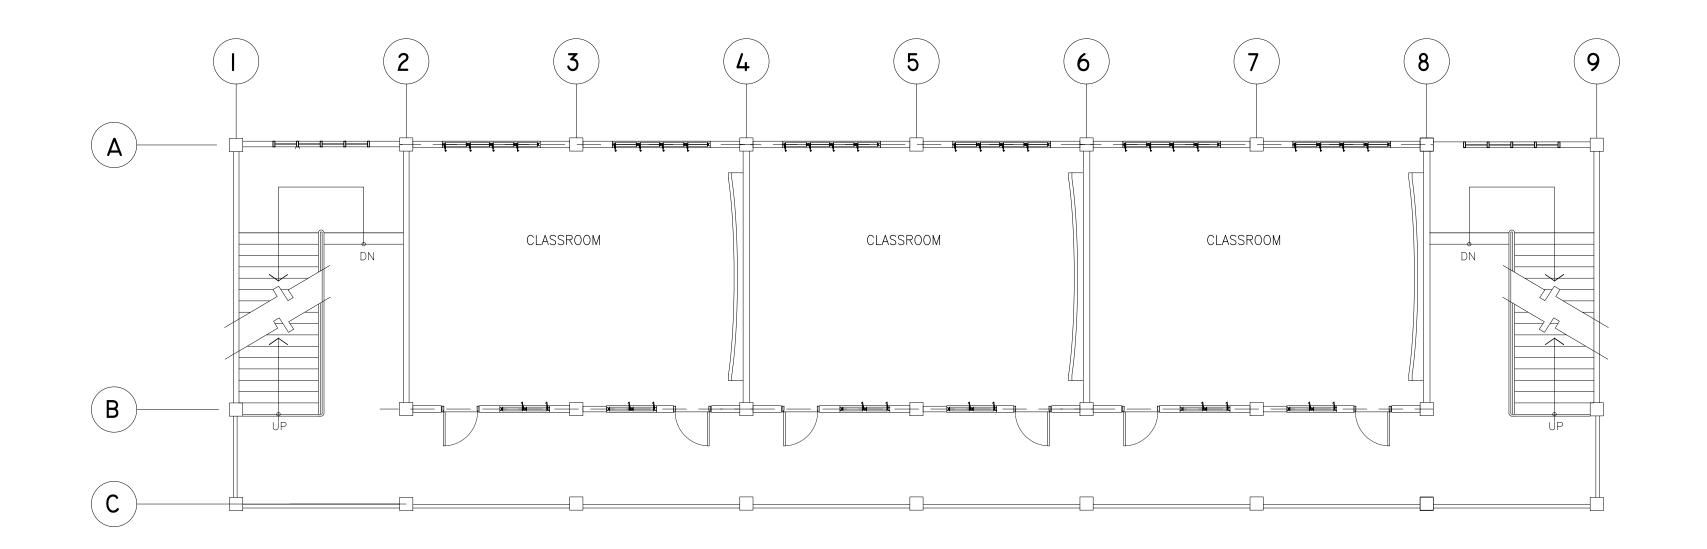

TYPICAL 2ND & 3RD FLOOR LIGHTING LAYOUT


SCALE: 1 : 100 METERS

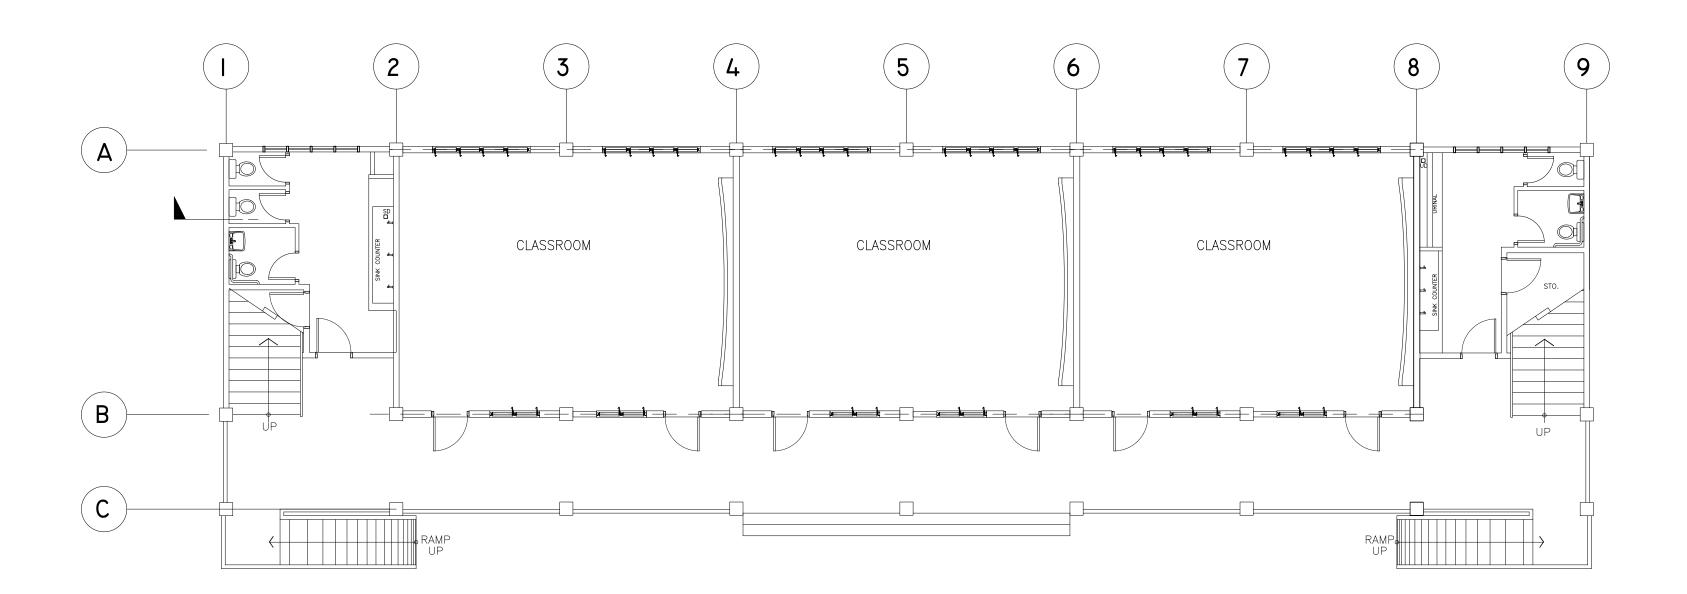

GROUND FLOOR LIGHTING LAYOUT


SCALE: 1:100 METERS

	CONSULTANT / DESIGNER	REVIEWED BY:	RECOMMENDING APPROVAL :	APPROVED FOR ACCREDITATION :	CONCURRED :	PROJECT TITLE :	PROJECT NO: 01-002	OWNER:	SHEET NO:
REPUBLIC OF THE PHILIPPINES	VENERANDO D. ISAHBAWAGUN		W T	1:16 r Om	R. 2. Brei	THREE STOREY	DESIGNED BY: RDS	DEPARTMENT OF EDUCATION	
DEPARTMENT OF EDUCATION (DepED) TASK FORCE ENGINEERING, ASSESSMENT AND MONITORING	ELECTRICAL INVERVIEW	FE M. BARRIENTOS	SØFIA T. SANTIAGO	GILBERTO S. DEYES	RAMON C. BACANI	SIX CLASSROOM	ENCODED BY: Max C	DepED	E-2
MERALCO AVENUE, PASIG CITY	PRC NO. : TIN :	CHIEF, ELECTRICAL DIVISION BUREAU OF DESIGN, DPWHY	OIC, DIRECTOR III BUREAU OF DESIGN, DPWH	BUREAU OF DESIGN, DPWH	UNDERSECRETARY DEPAIMENT OF EDUCATION (DepED)	w/MULTI-PURPOSE	CHECKED BY:	SHEET CONTENTS :	3
	PTR NO. : DATE :	-			TY ~	LOCATION:	DATE: 01 03	LIGHTING LAYOUT	

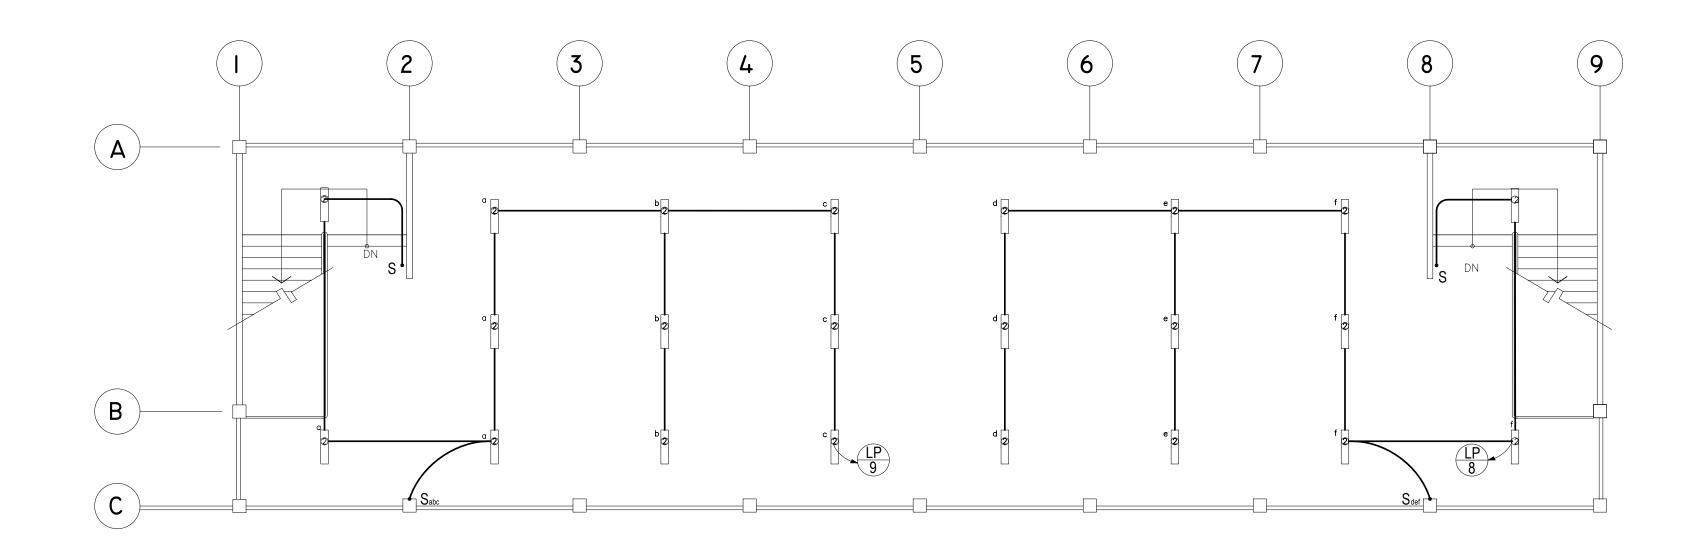

THIRD FLOOR LIGHTING LAYOUT

1 : 100 METERS

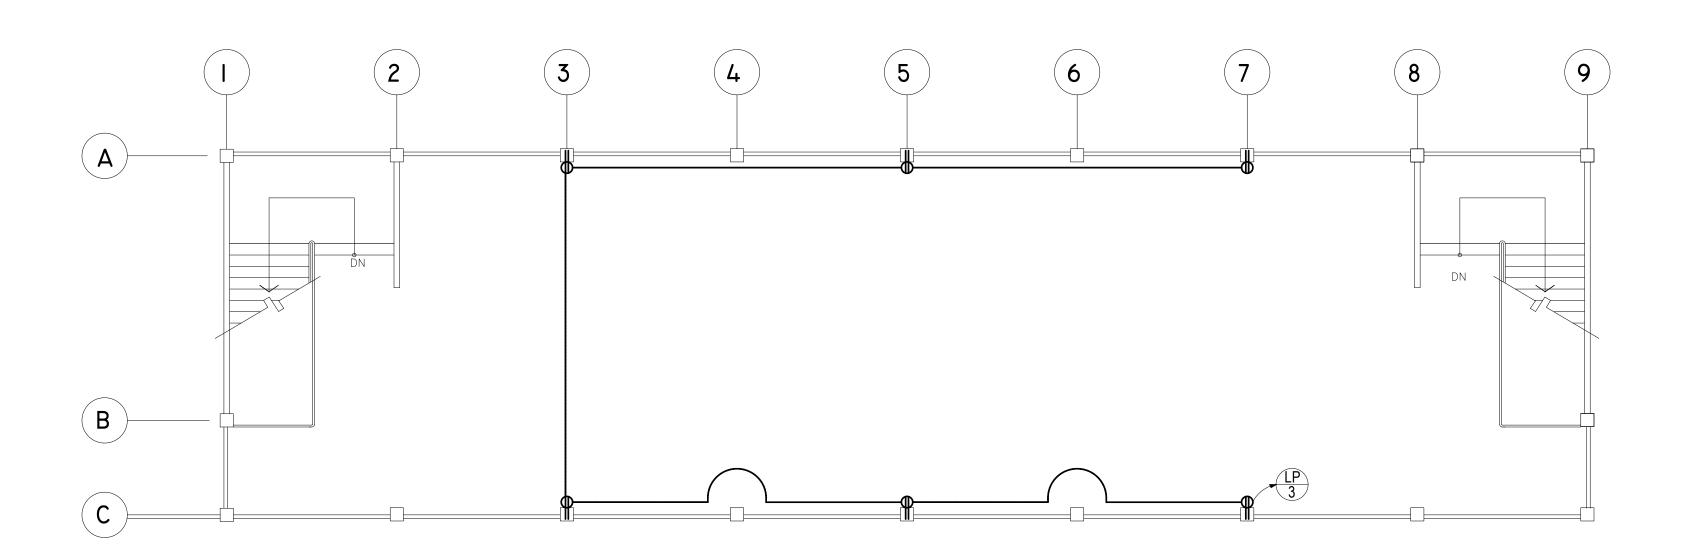

THIRD FLOOR POWER LAYOUT

SCALE : 1 : 100 METERS

REPUBLIC OF THE PHILIPPINES DEPARTMENT OF EDUCATION (DepED) TASK FORCE ENGINEERING, ASSESSMENT AND MONITORING MERALCO AVENUE, PASIG CITY	Var note
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	CONSULTANT	/ DESIGNER
Progravo		VENERANDO D. SAHAGUN
ASSESSMENT &		
	PRC NO. :	TIN :
	PTR NO. :	DATE :

REVIEWED BY:	
FE M. BARRIENTOS	
CHIEF, ELECTRICAL DIVISION BUREAU OF DESIGN, DPW/Y44667	

RECOMMENDING APPROVAL :
SØFIA T. SANTIAGO OIC, DIRECTOR III BUREAU OF DESIGN, DPWH


GILBERTO S. PREYES
OIC, DIRECTOR IV
BUREAU OF DESIGN, DPWH

APPROVED FOR ACCREDITATION :

NCURRED :	PROJECT
RAMON C. BACANI	
UNDERSECRETARY DEPATMENT OF EDUCATION (DepED)	
()(), ,	LOCATION


	PROJECT TITLE :	PROJECT NO: 01-002	OWN
	THREE STOREY	DESIGNED BY: RDS	
	SIX CLASSROOM	ENCODED BY: Max C	
w/MULTI-PURPOSE	w/MULTI-PURPOSE	CHECKED BY:	SHE
	LOCATION:	DATE: 01 03	

OWNER:	SHEET NO:
DEPARTMENT OF EDUCATION DepED	E-3
SHEET CONTENTS : POWER LAYOUT	3

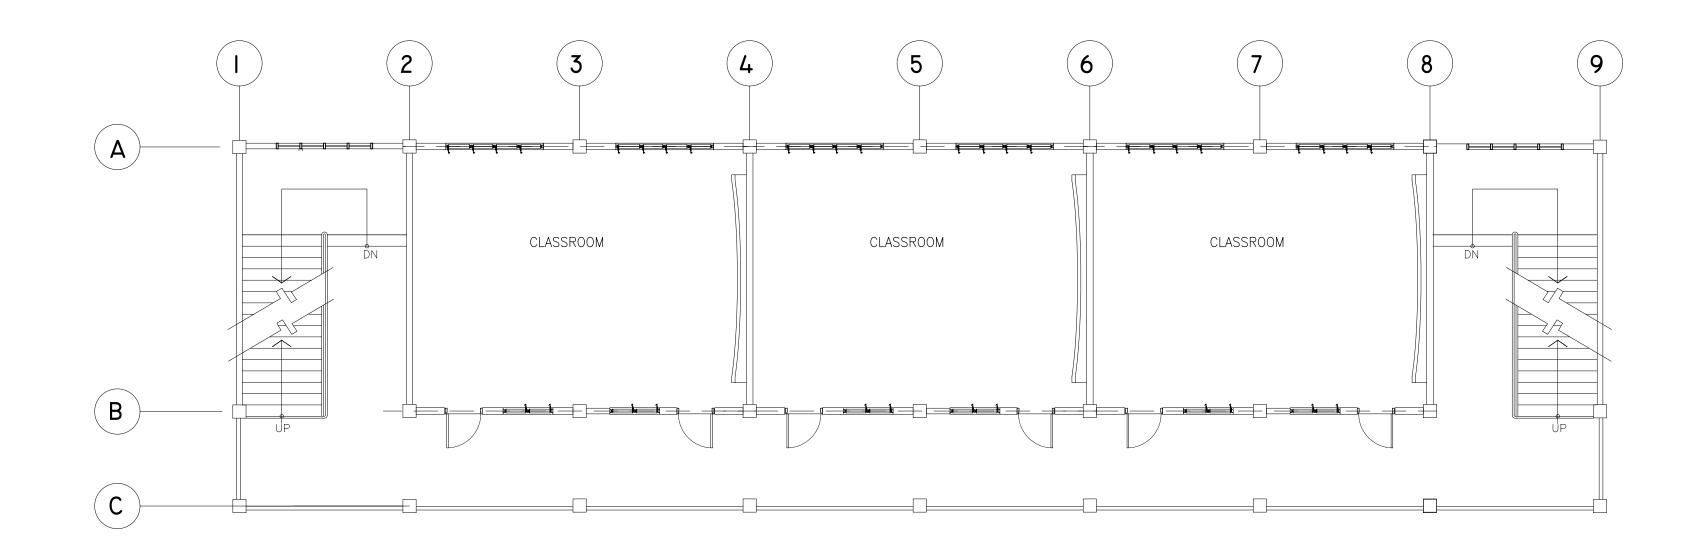

TYPICAL 2ND & 3RD FLOOR POWER LAYOUT

SCALE: 1:100 METERS

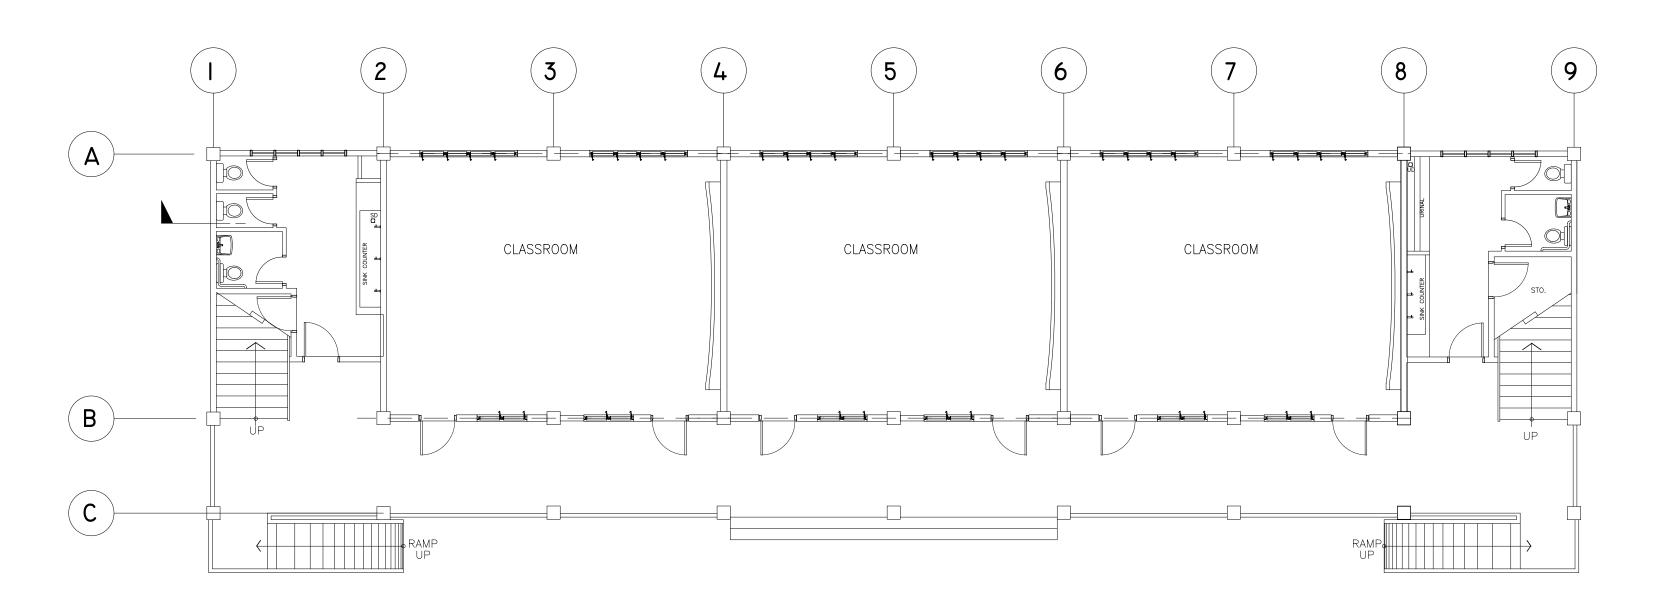

GROUND FLOOR POWER LAYOUT

SCALE: 1 : 100 METERS

