

CHIEF, PLANNING AND DESIGN SECTION

# REPUBLIC OF THE PHILIPPINES DEPARTMENT OF PUBLIC WORKS AND HIGHWAYS

REGION IV-B, MIMAROPA

MARINDUQUE DISTRICT ENGINEERING OFFICE
BOAC, MARINDUQUE

C.Y 2025 PROJECT
DETAILED ENGINEERING DESIGN PLAN FOR


LOCAL PROGRAM - NATIONAL BUILDING PROGRAM
BUILDINGS AND OTHER MULTIPURPOSE / FACILITIES STRUCTURE
CONSTRUCTION OF DPWH BUILDING, MARINDUQUE DISTRICT
ENGINEERING OFFICE, BOAC, MARINDUQUE

SUBMITTED:	RECOMMENDED:	APPROVED:
FERNAN S. DIAZ	RYAN N. DELA CRUZ	RICHARD EMMANUEL P RAGRAGIO

DISTRICT ENGINEER

OIC - ASSISTANT DISTRICT ENGINEER

DATE: DATE:

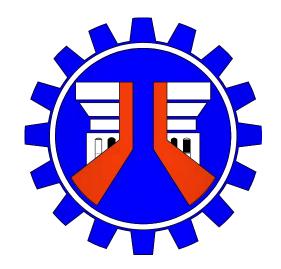

#### REPUBLIC OF THE PHILIPPINES

### DEPARTMENT OF PUBLIC WORKS AND HIGHWAYS

REGION IV-B, MIMAROPA MARINDUQUE DISTRICT ENGINEERING OFFICE BOAC, MARINDUQUE

### LOCAL PROGRAM - NATIONAL BUILDING PROGRAM **BUILDINGS AND OTHER MULTIPURPOSE / FACILITIES STRUCTURE** CONSTRUCTION OF DPWH BUILDING, MARINDUQUE DISTRICT **ENGINEERING OFFICE, BOAC, MARINDUQUE**



### TABLE OF CONTENTS

#### ARCHITECTURAL

- A-1 PERSPECTIVE
- A-2 KEY MAP LOCATION MAP SITE DEVELOPMENT PLAN

  - GROUND FLOOR PLAN SECOND FLOOR PLAN ROOF DECK CEILING PLAN
- ROOF DECK PLAN
- FRONT ELEVATION RIGHT SIDE ELEVATION
- REAR ELEVATION LEFT SIDE ELEVATION
- A-6 LONGITUDINAL SECTION **CROSS SECTION**
- DETAIL OF RECESSED CEILING A-7 SCHEDULE OF DOORS AND WINDOWS
  - DETAIL PLAN OF LOBBY
  - **DETAIL SECTION OF LOBBY** DETAIL OF OFFICE CUBICLE SCHEDULE OF DOORS AND WINDOWS
- DETAIL PLAN OF PANTRY SEAMLESS CABINET DETAIL SECTION OF PANTRY
- A-10 ELEVATION OF WARDROBE SEAMLESS CABINET **ISOMETRIC** SPOT DETAIL ISOMETRIC

ISOMETRIC

A-11 SEAMLESS TV RACK @ EXECUTIVE ROOM 1 SEAMLESS TV RACK @ EXECUTIVE ROOM 2 **ISOMETRIC ISOMETRIC** 

#### ELECTRICAL

- E-1 GROUND FLOOR LIGHTING LAYOUT **GROUND FLOOR POWER LAYOUT**
- E-2 GENERAL NOTES : SCHEDULE OF LOADS LPA(EXISTING)
  SINGLE LINE RISER DIAGRAM



PROJECT NAME AND LOCATION: REHABILITATION/IMPROVEMENT OF **ACCESSIBILTY FACILITIES FOR** PHYSICALLY CHALLENGED PERSONS, BARANGAY BANGBANGALON BOAC, MARINDUQUE

SHEET CONTENTS: PERSPECTIVE

TABLE OF CONTENTS

DRAFTED BY: KYLE ADRIAN M. JAGONG DRAFTSMAN I PREPARED BY:

JAN HENRY R. ROSALES

JINKIE M. MONTERAS ENGINEER II

REVIEWED BY:

SUBMITTED BY: FERNAN S. DIAZ CHIEF, PLANNING AND DESIGN

SECTION


RECOMMENDED BY:

RYAN N. DELA CRUZ OIC - ASSISTANT DISTRICT ENGINEER


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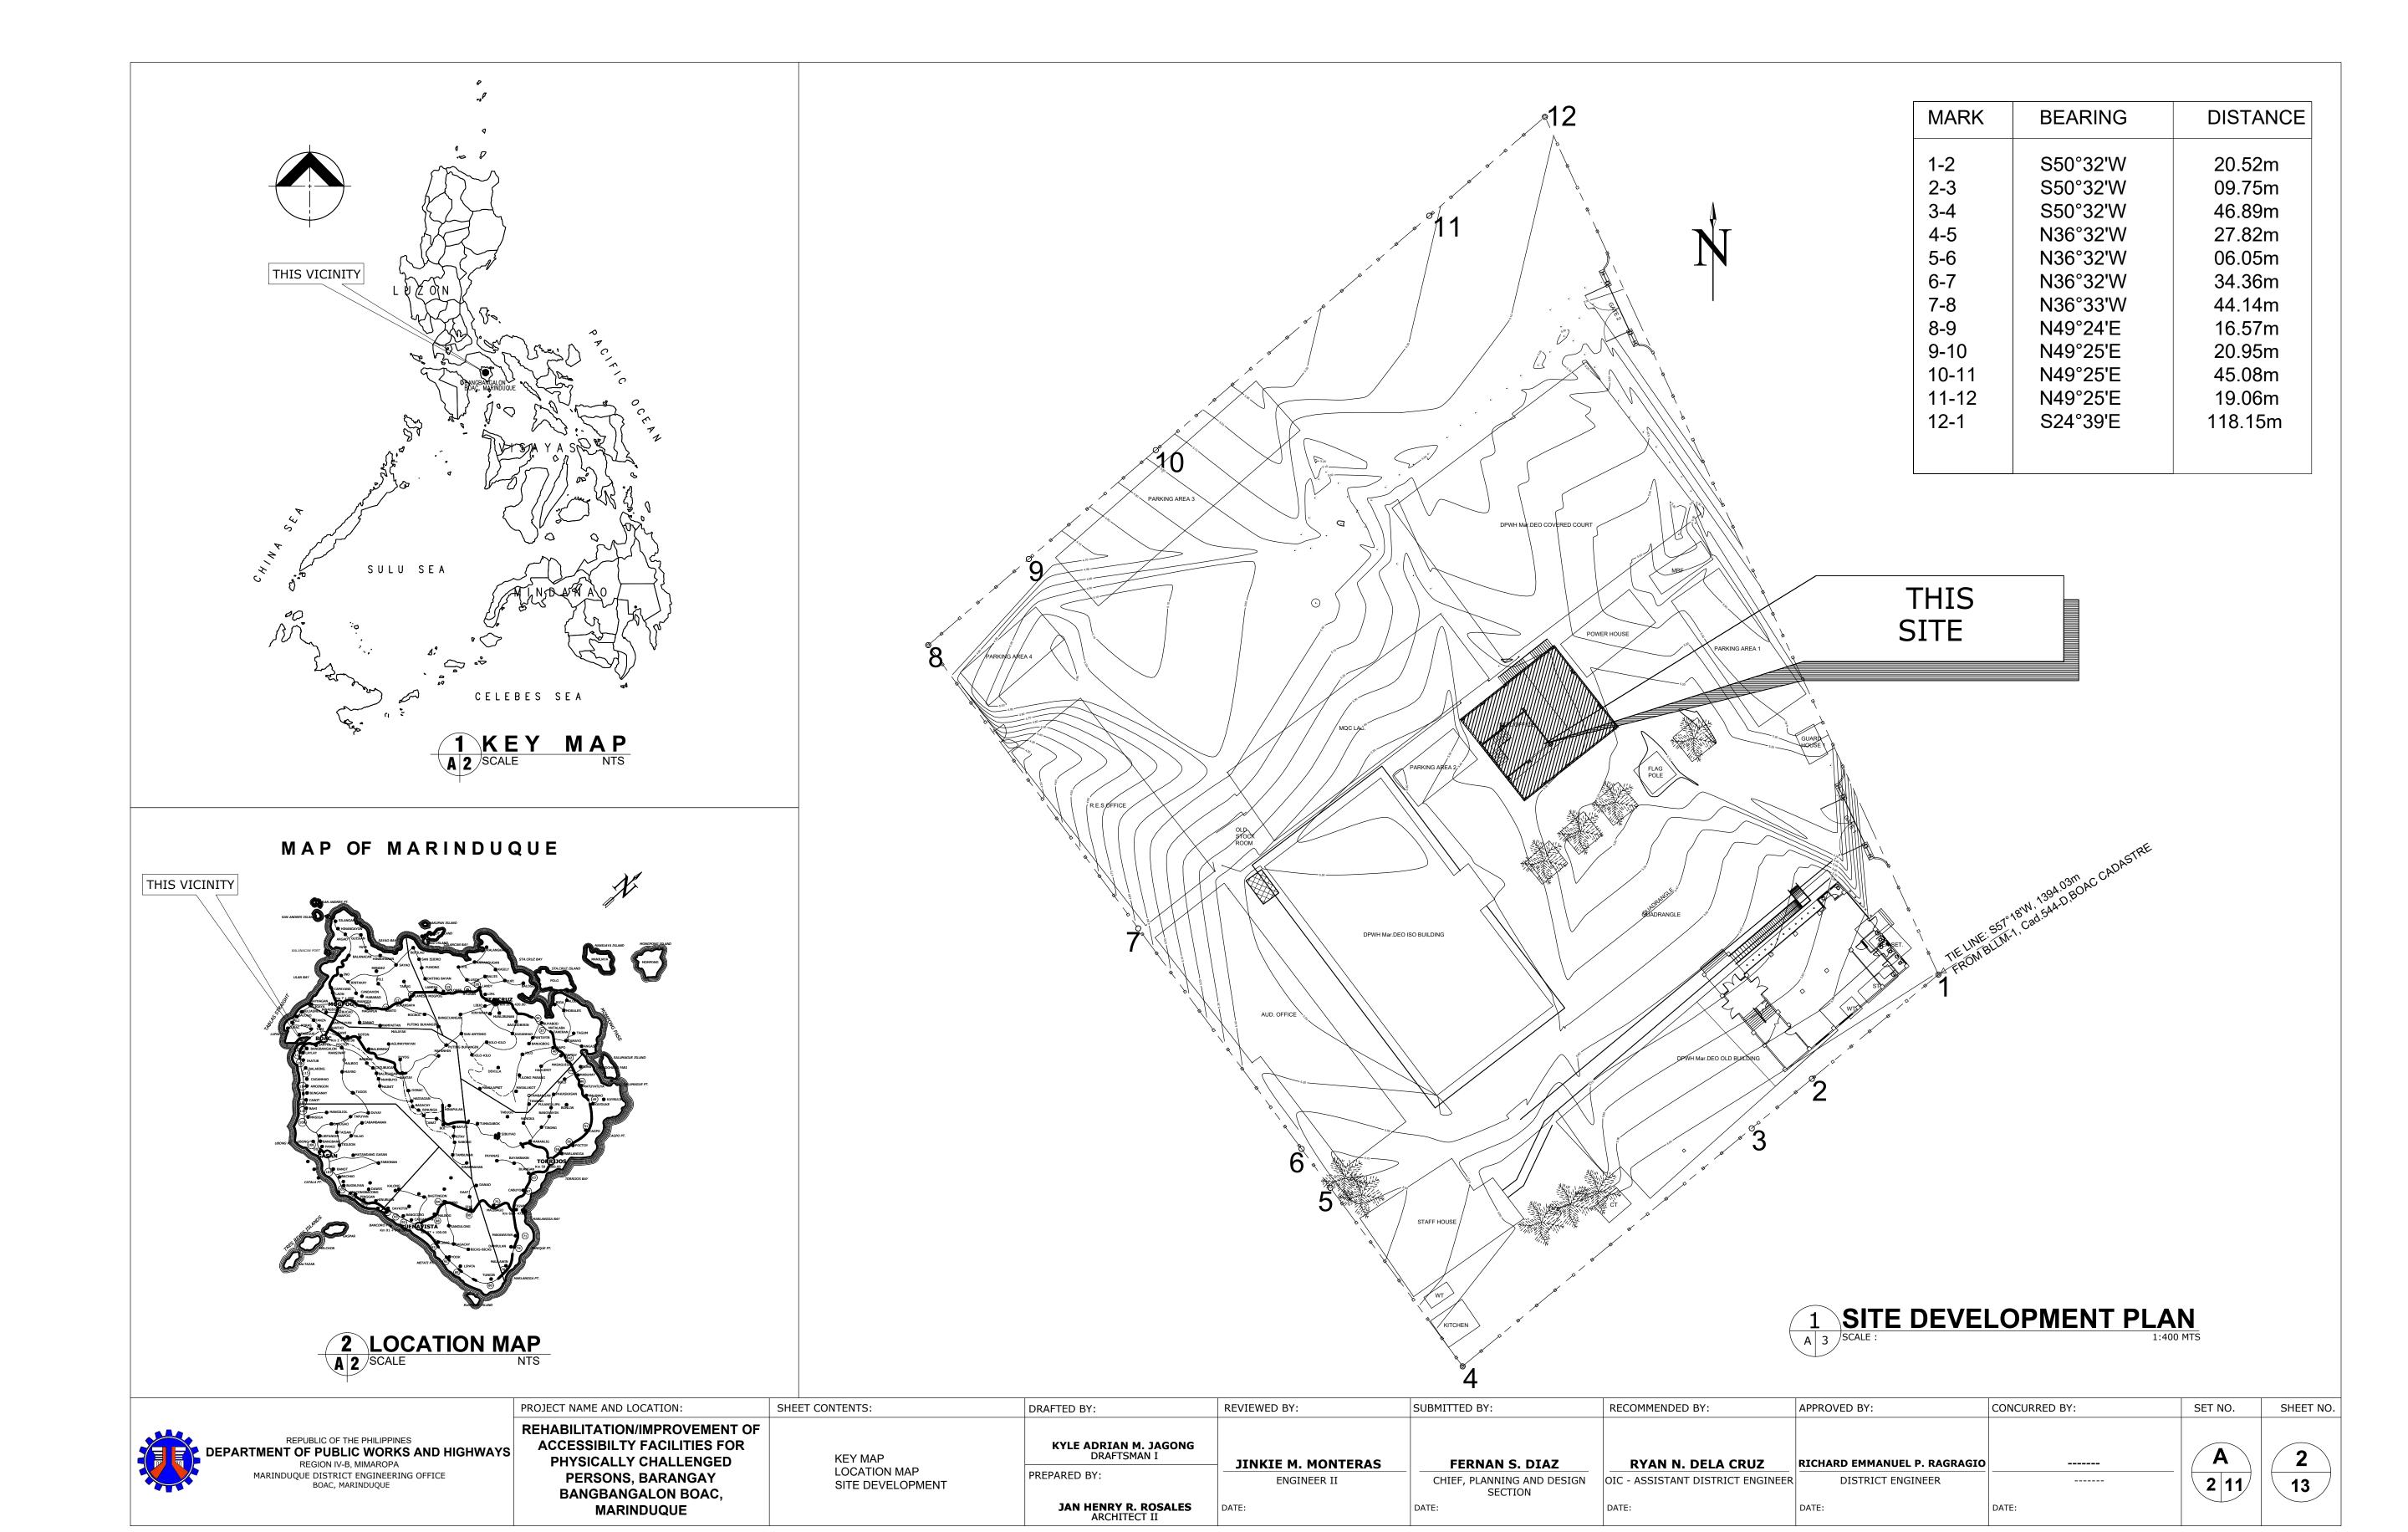
RICHARD EMMANUEL P. RAGRAGIO DISTRICT ENGINEER


CONCURRED BY:

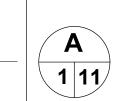

SET NO.




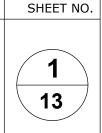


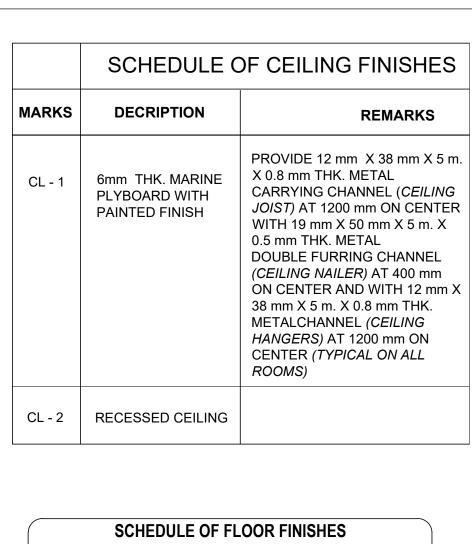



	SCHEDULE OF FLOOR FINISHES
FL-1	600 X 600 mm UNPOLISHED SYNTHETIC GRANITE TILE FLOOR FINISH (SUBMIT SAMPLE FOR APPROVAL)
FL-2	600 x 600mm VITRIFIED UNGLAZED TILES FLOOR FINISH (SIZE AND/OR COLOR FOR APPROVAL BY END-USER) PROVIDE WATER BASE WATERPROOFING
FL-3	PLAIN CEMENT FLOOR FINISH (PROVIDE WATER BASE WATERPROOFING)


#### LEGEND:

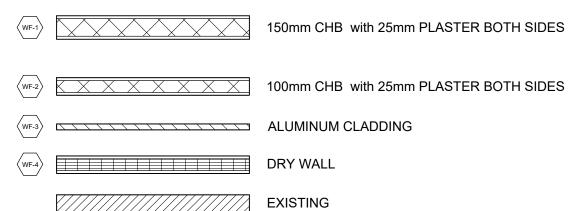

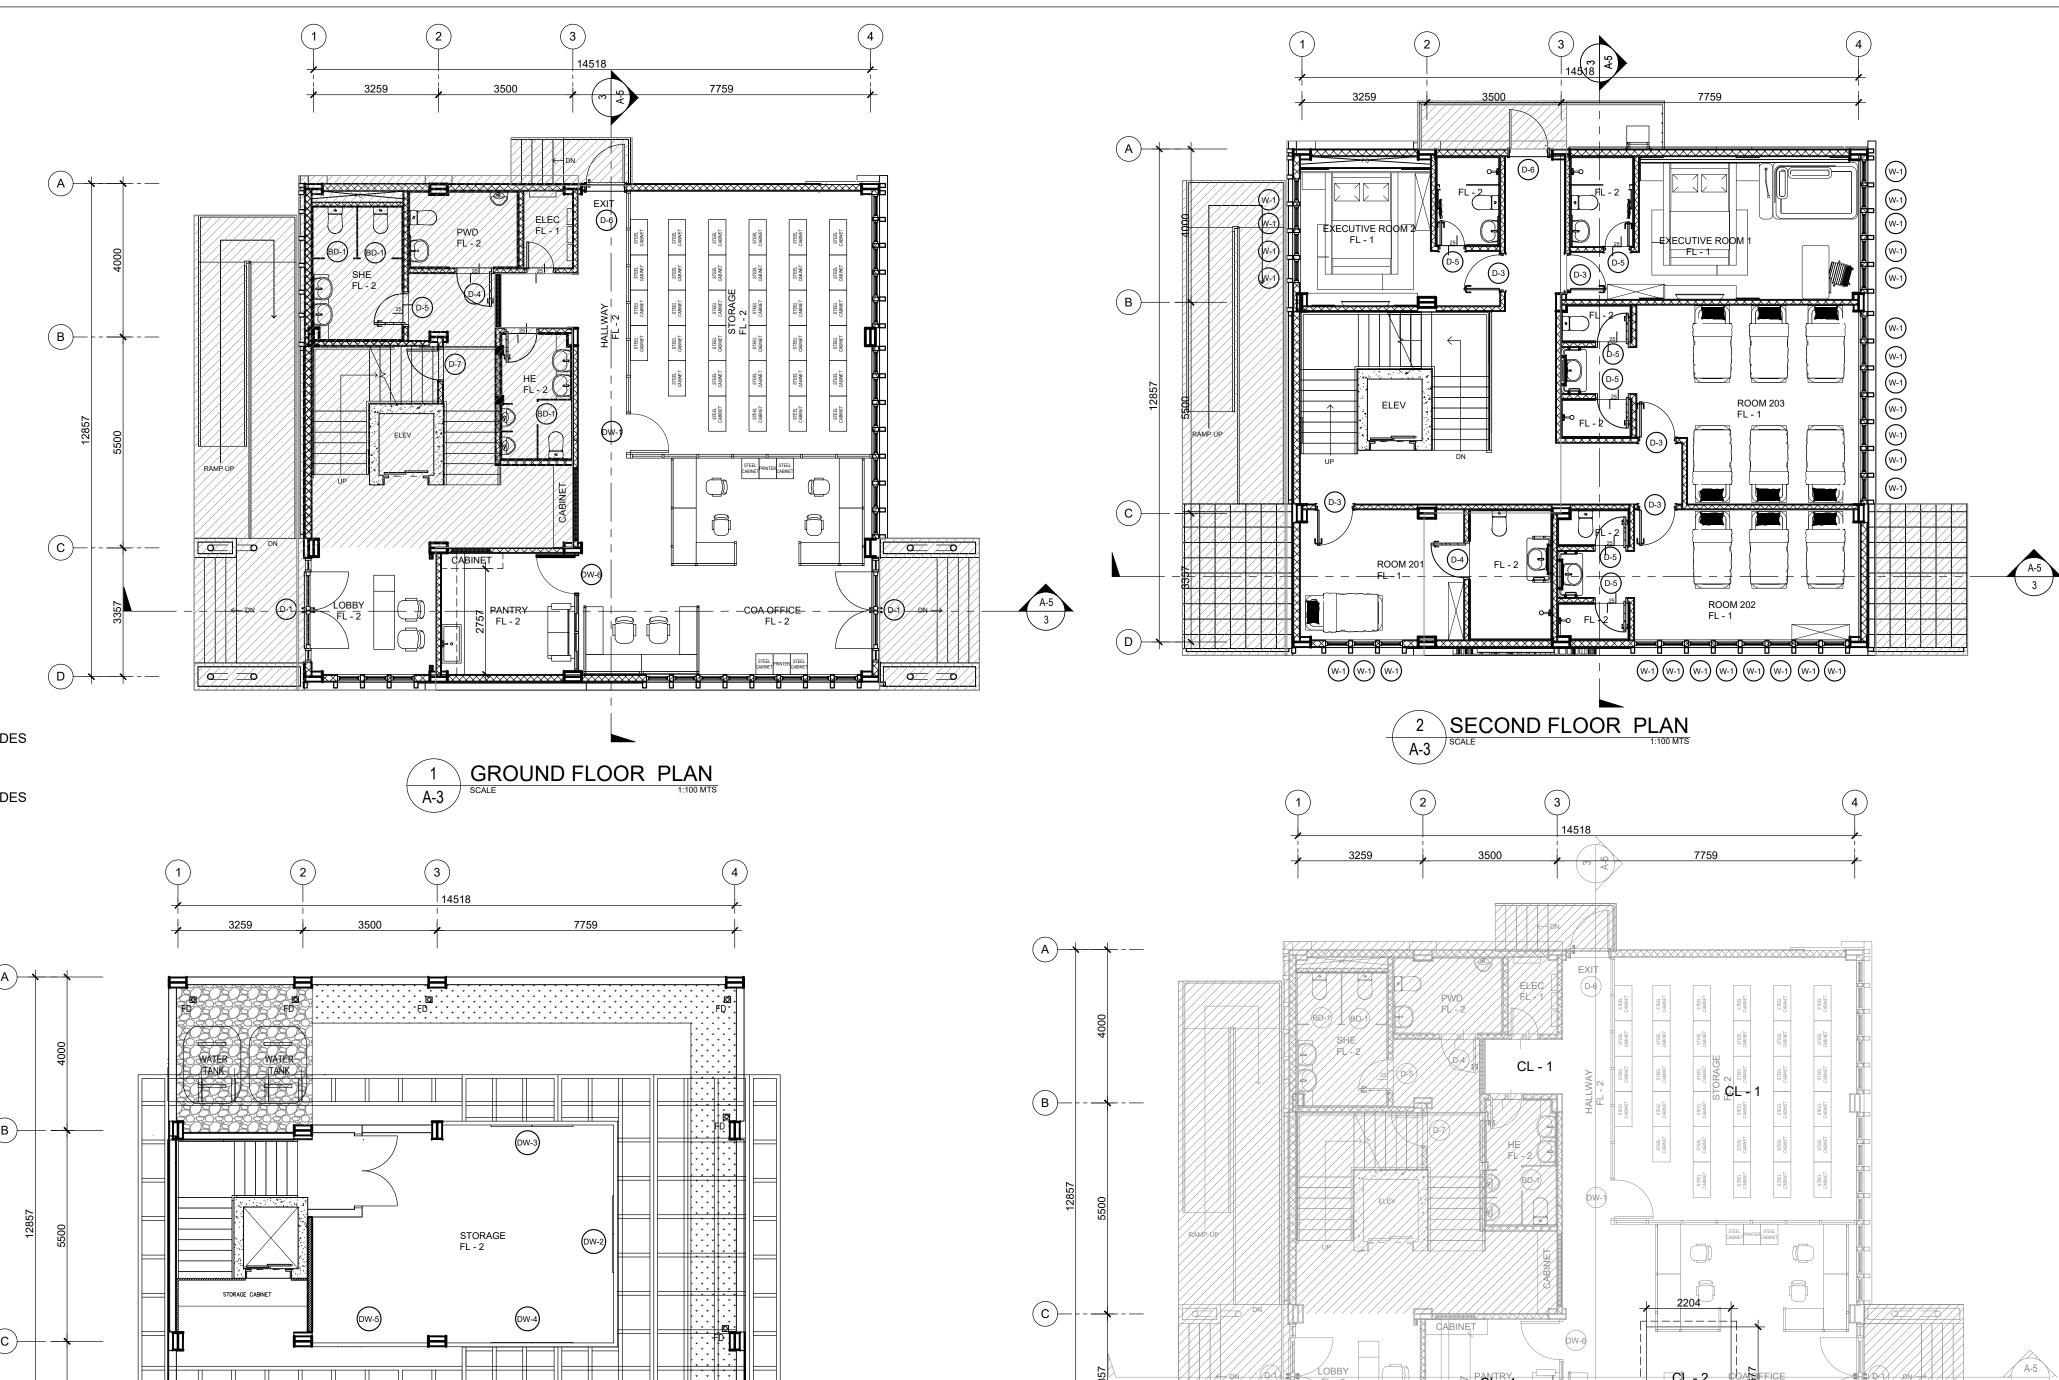

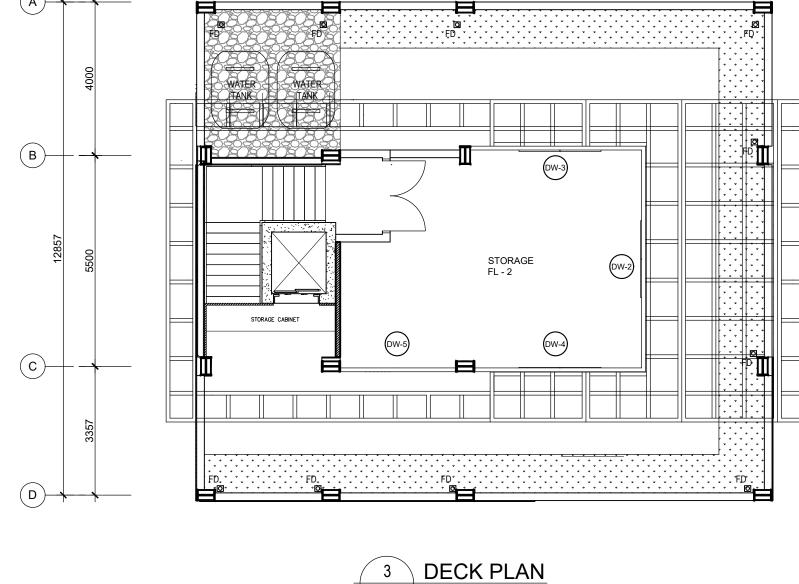

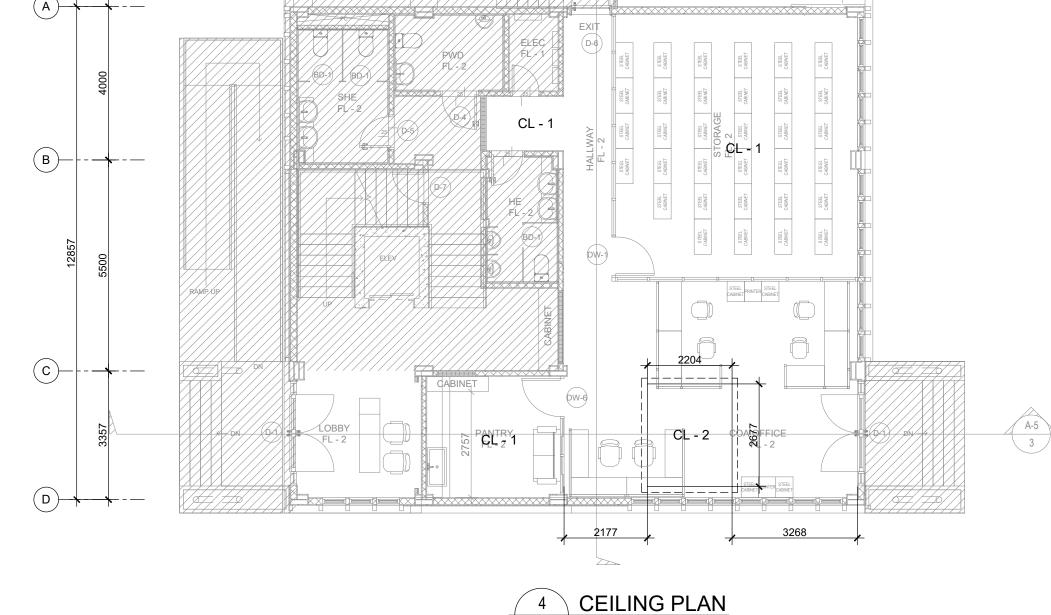

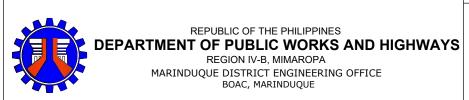

	PROJECT NAME AND LOCATION:
	REHABILITATION/IMPROVEMENT OF ACCESSIBILTY FACILITIES FOR
YS	PHYSICALLY CHALLENGED
	PERSONS, BARANGAY
	BANGBANGALON BOAC,
	MARINDUQUE

GROUND FLOOR PLAN
SECOND FLOOR PLAN ROOF DECK
CEILING PLAN

SHEET CONTENTS:

DRAFTED BY:	REVIEWED BY:
<b>KYLE ADRIAN M. JAGONG</b> DRAFTSMAN I	JINKIE M. MONTERAS
PREPARED BY:	ENGINEER II
JAN HENRY R. ROSALES ARCHITECT II	DATE:


. MONTERAS	FERNAN S. DIAZ	RYAN N. DELA CRUZ
INEER II	CHIEF, PLANNING AND DESIGN SECTION	OIC - ASSISTANT DISTRICT ENGINEE
	DATE:	DATE:

SUBMITTED BY:

RECOMMENDED BY:	APPROVED BY:	CONCURRED BY:	SET NO.
RYAN N. DELA CRUZ OIC - ASSISTANT DISTRICT ENGINEER DATE:	RICHARD EMMANUEL P. RAGRAGIO DISTRICT ENGINEER DATE:	  DATE:	A 3 11

SHEET NO.

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PROJECT NAME AND LOCATION:	S
REHABILITATION/IMPROVEMENT OF	
ACCESSIBILTY FACILITIES FOR	
PHYSICALLY CHALLENGED	
PERSONS, BARANGAY	
BANGBANGALON BOAC,	
MARINDUQUE	

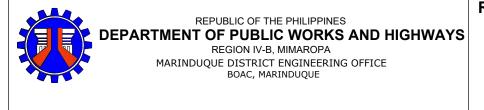REVIEWED BY: SHEET CONTENTS: DRAFTED BY: KYLE ADRIAN M. JAGONG DRAFTSMAN I ROOF DECK PLAN PREPARED BY: JAN HENRY R. ROSALES ARCHITECT II

JINKIE M. MONTERAS ENGINEER II

1 ROOF DECK PLAN
A-4 SCALE 1:50 MTS


**FERNAN S. DIAZ** CHIEF, PLANNING AND DESIGN OIC - ASSISTANT DISTRICT ENGINEER SECTION

SUBMITTED BY:

RYAN N. DELA CRUZ


RECOMMENDED BY:

CONCURRED BY: APPROVED BY: RICHARD EMMANUEL P. RAGRAGIO DISTRICT ENGINEER DATE:

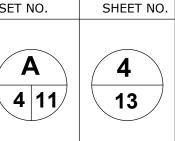


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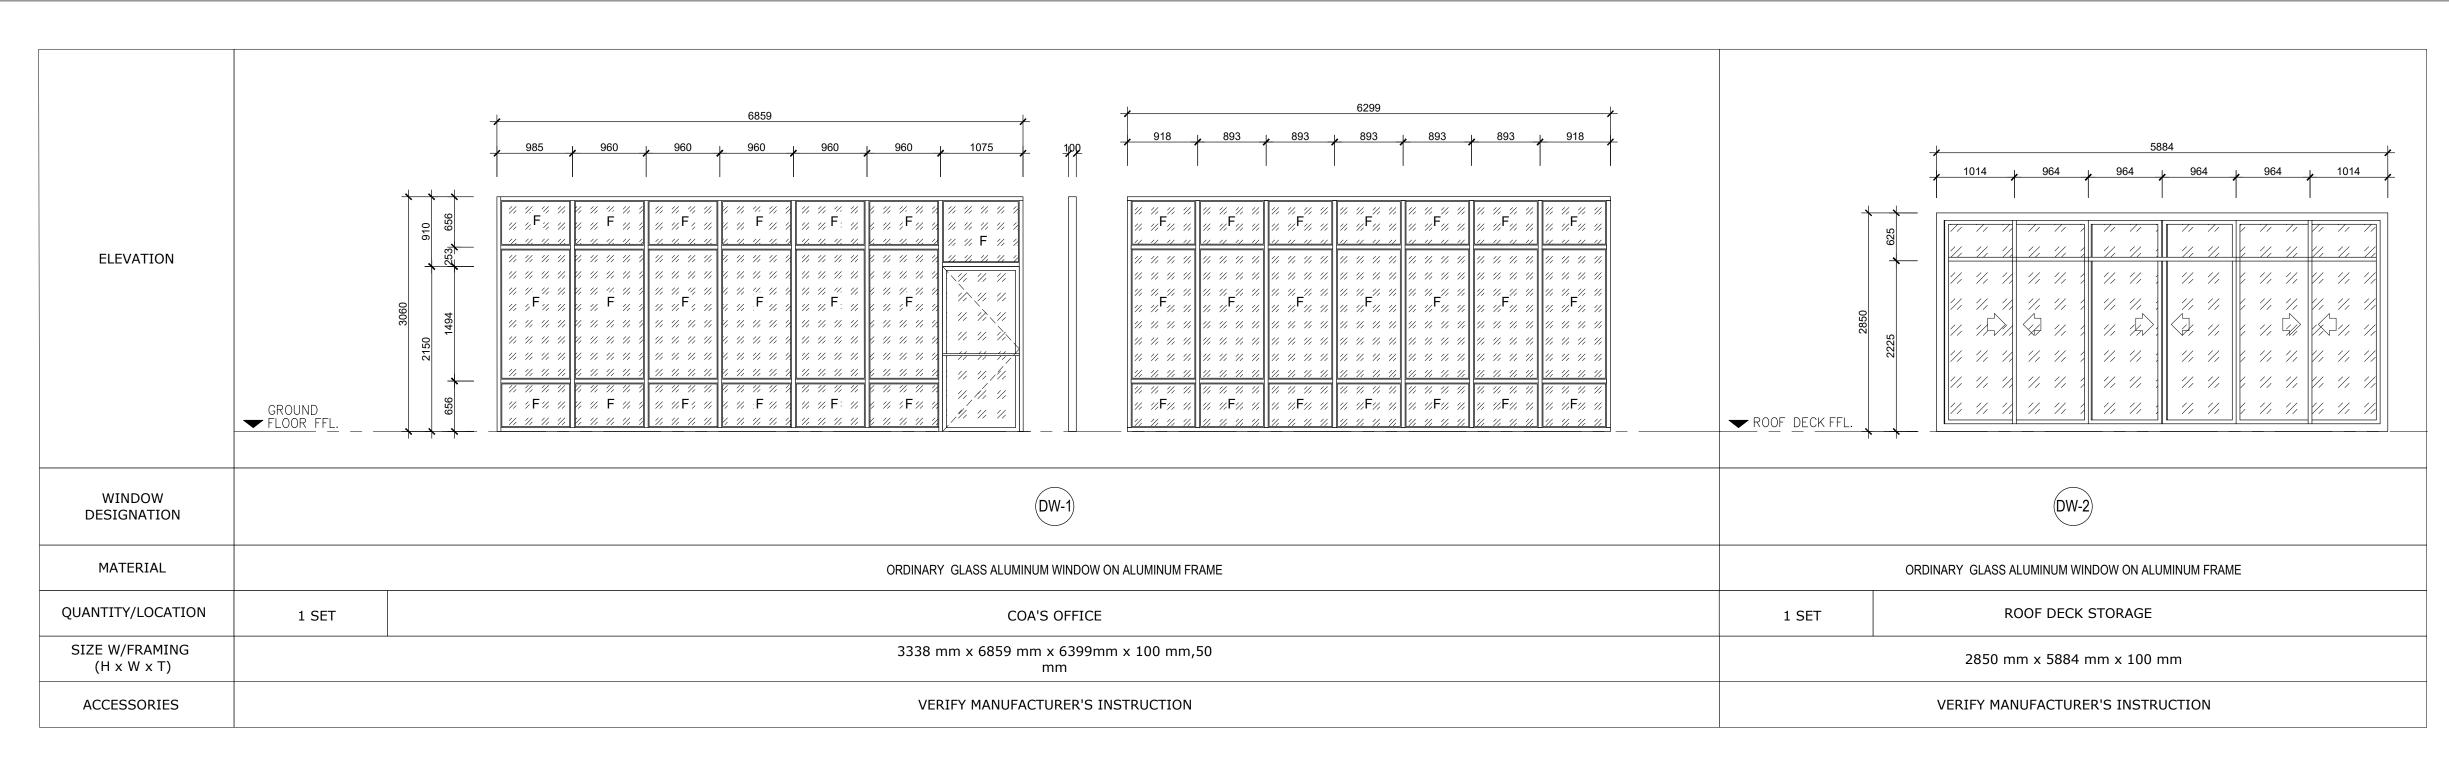
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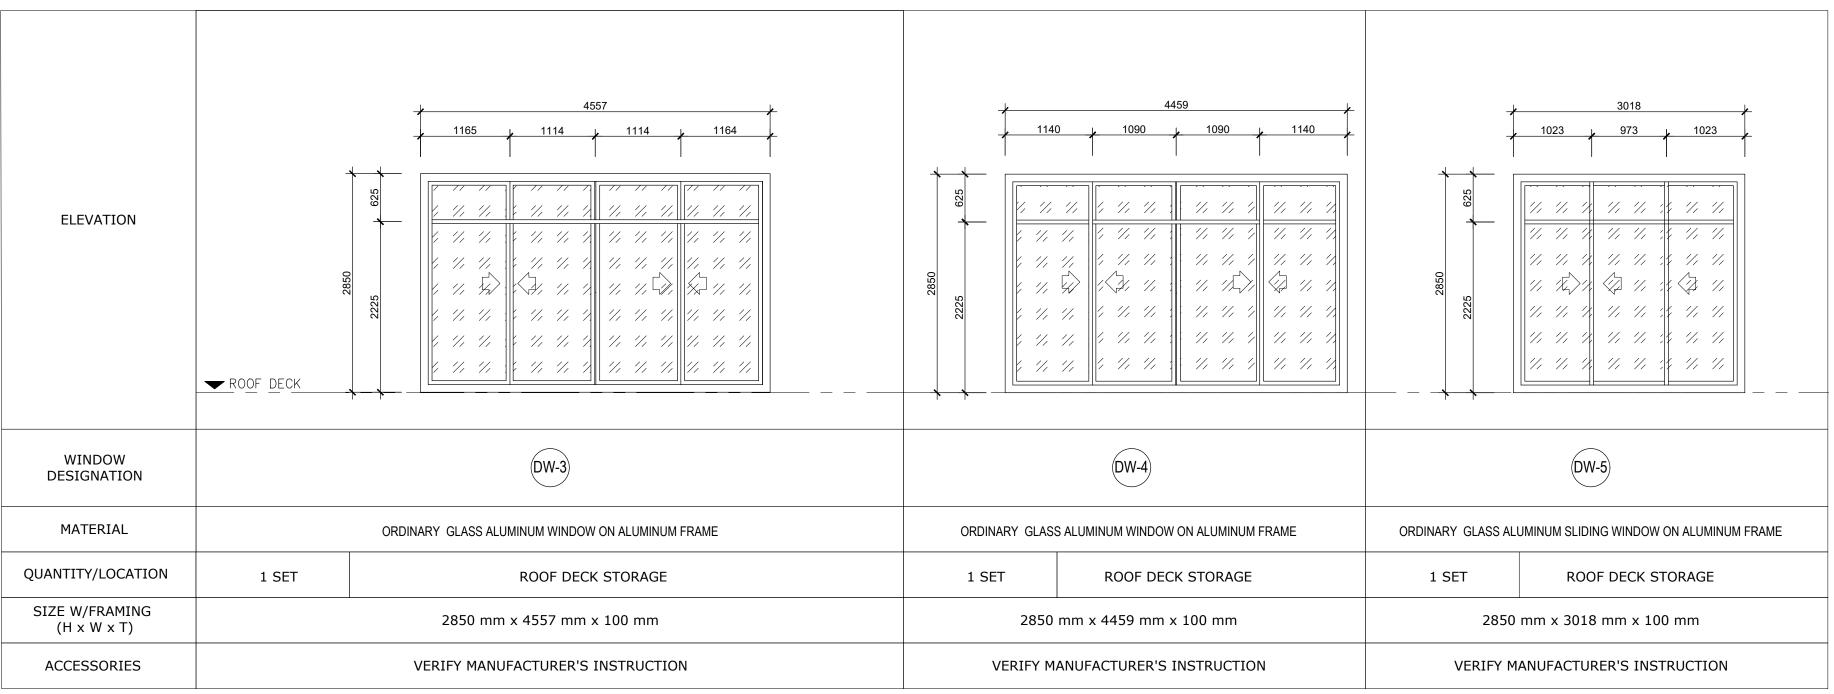


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REPUBLIC OF THE PHILIPPINES  DEPARTMENT OF PUBLIC WORKS AND HIGHWAYS  REGION IV-B, MIMAROPA  MARINDUQUE DISTRICT ENGINEERING OFFICE BOAC, MARINDUQUE	REHABILITATION/IMPROVEMENT OF ACCESSIBILTY FACILITIES FOR PHYSICALLY CHALLENGED PERSONS, BARANGAY BANGBANGALON BOAC,	FRONT ELEVATION RIGHT SIDE ELEVATION REAR ELEVATION LEFT SIDE ELEVATION	KYLE ADRIAN M. JAGONG DRAFTSMAN I PREPARED BY:	JINKIE M. MONTERAS ENGINEER II	FERNAN S. DIAZ  CHIEF, PLANNING AND DESIGN SECTION	RYAN N. DELA CRUZ OIC - ASSISTANT DISTRICT ENGINEE	RICHARD EMMANUEL P. RAGRAGIO ER DISTRICT ENGINEER		- A 5 11	5 13
	MARINDUQUE		JAN HENRY R. ROSALES ARCHITECT II	DATE:	DATE:	DATE:	DATE:	DATE:		

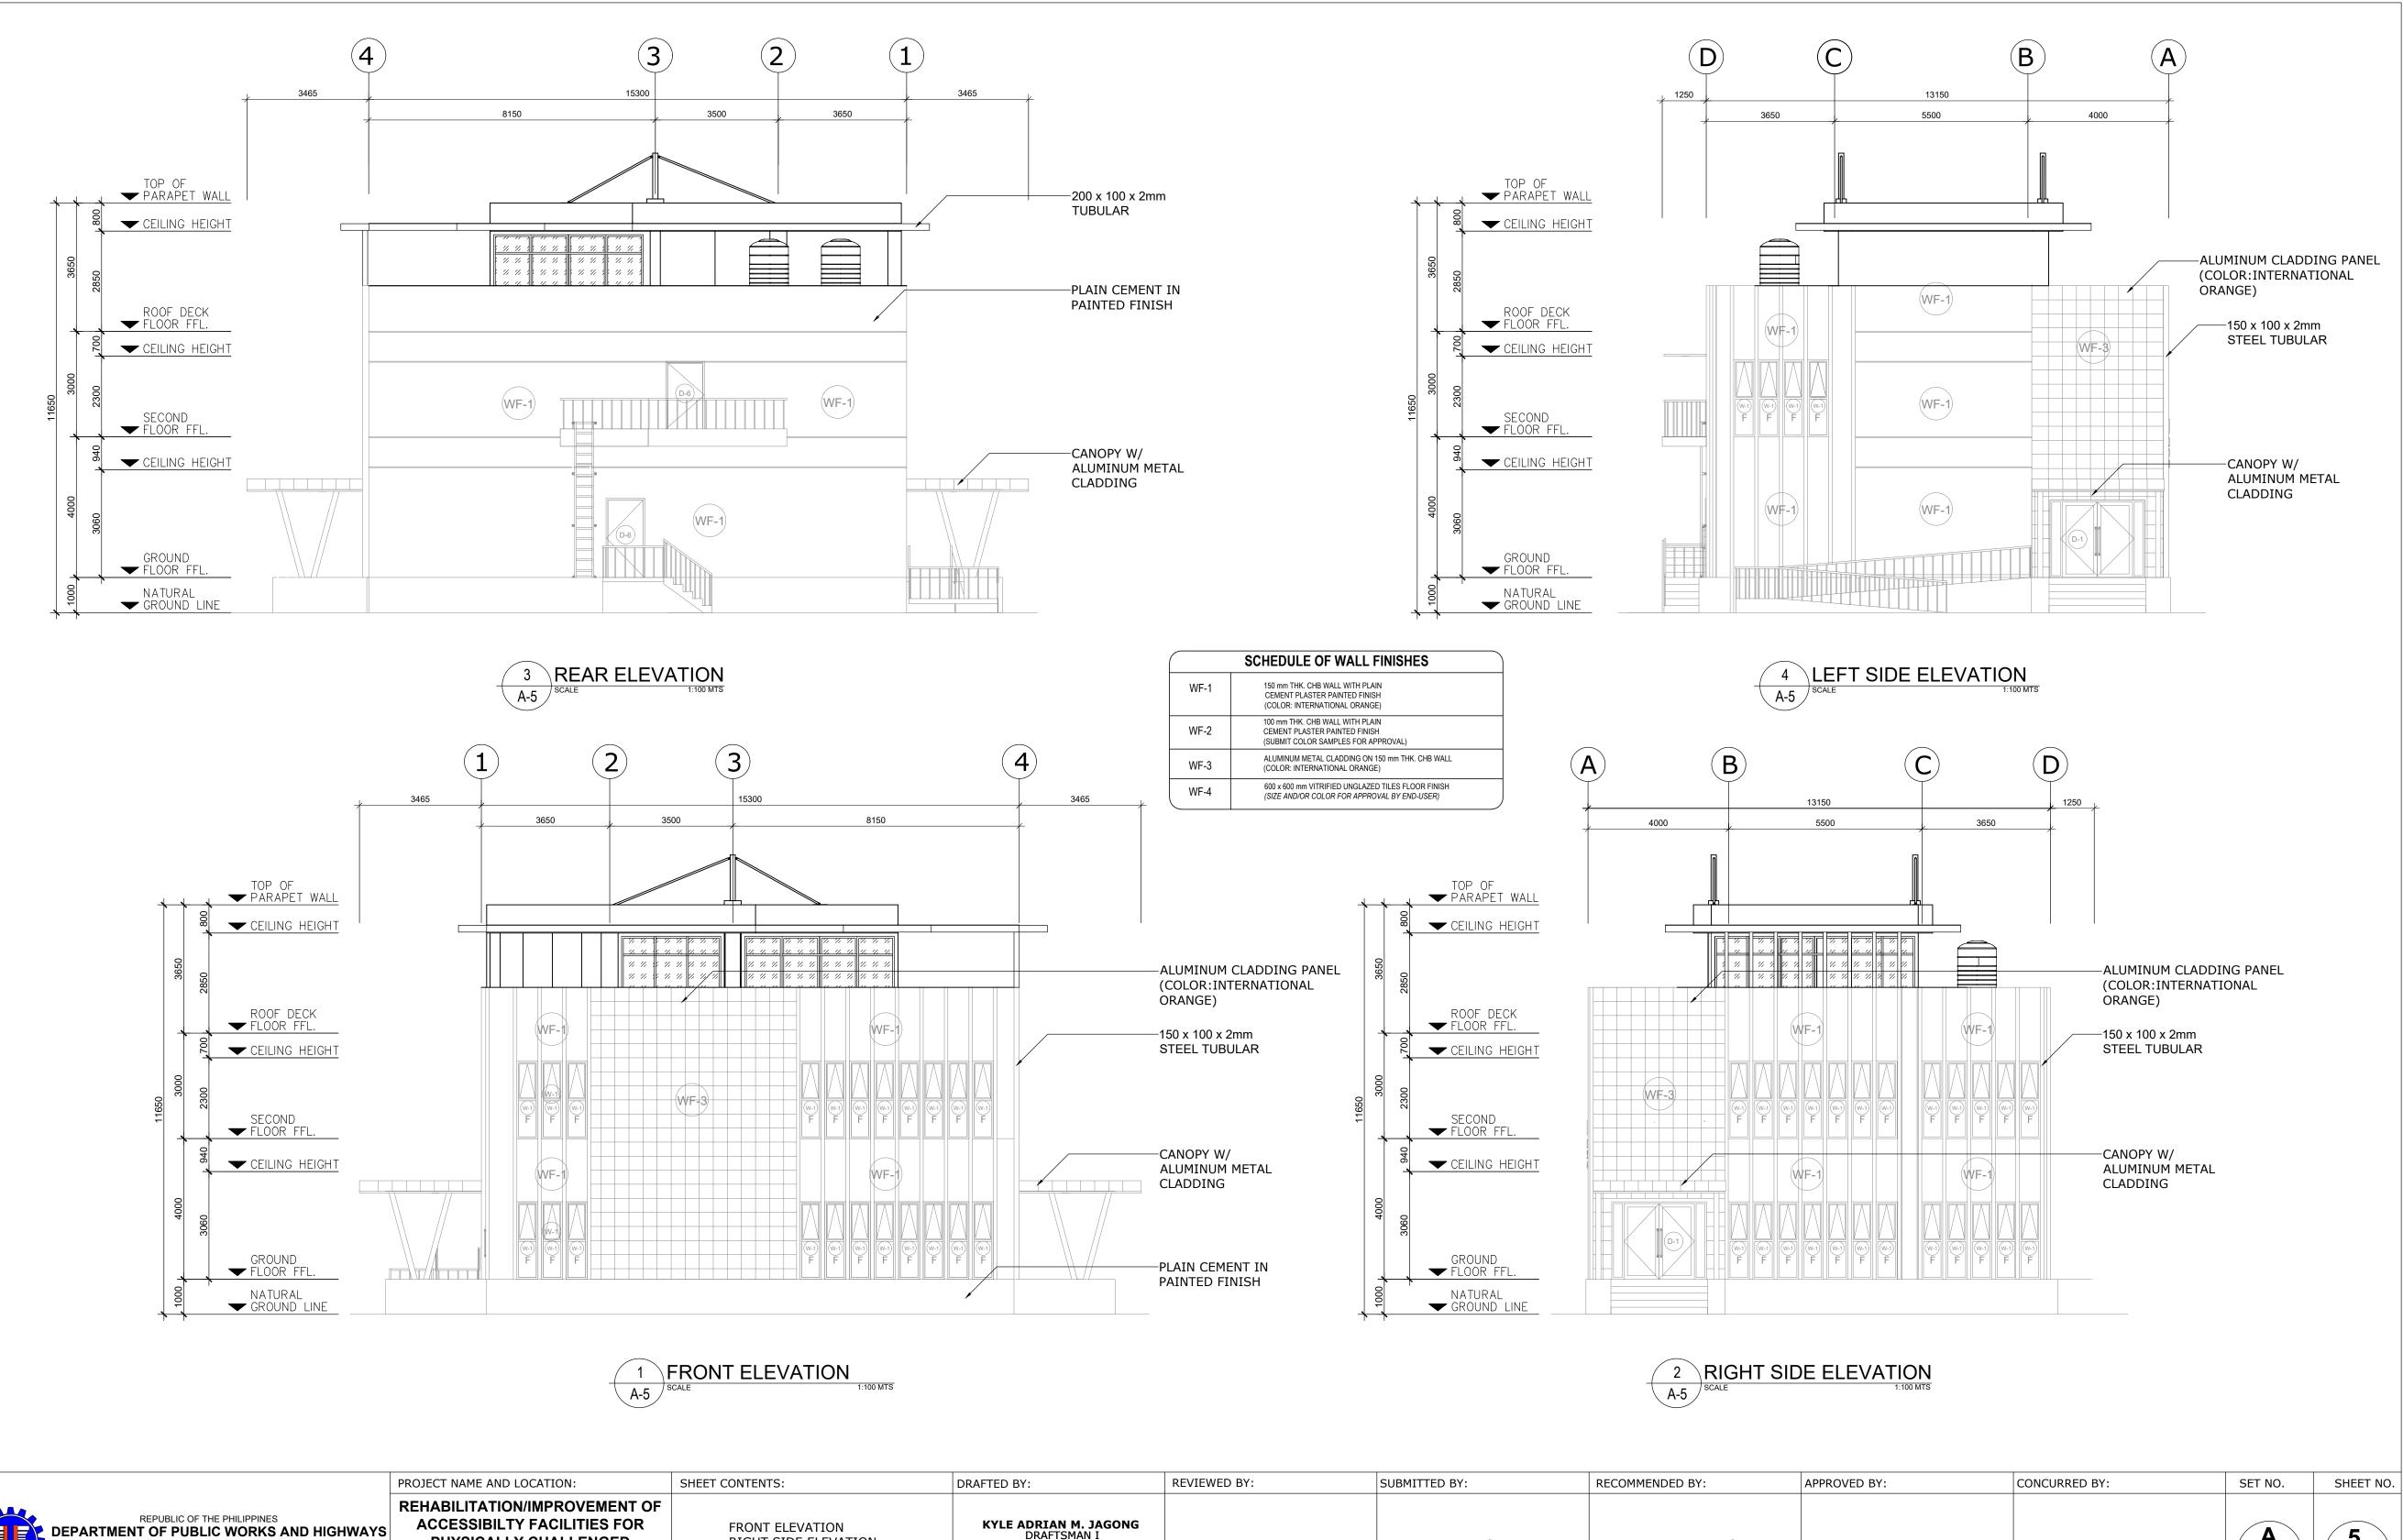


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REPUBLIC OF THE PHILIPPINES  DEPARTMENT OF PUBLIC WORKS AND HIGHWAYS  REGION IV-B, MIMAROPA	REHABILITATION/IMPROVEMENT OF ACCESSIBILTY FACILITIES FOR PHYSICALLY CHALLENGED PERSONS, BARANGAY BANGBANGALON BOAC,	LONGITUDINAL SECTION CROSS SECTION ISOMETRIC DETAILS OF CEILING	<b>KYLE ADRIAN M. JAGONG</b> DRAFTSMAN I	JINKIE M. MONTERAS	FERNAN S. DIAZ	RYAN N. DELA CRUZ	RICHARD EMMANUEL P. RAGRAGIO		A	6
MARINDUQUE DISTRICT ENGINEERING OFFICE BOAC, MARINDUQUE			PREPARED BY:	ENGINEER II	CHIEF, PLANNING AND DESIGN SECTION	OIC - ASSISTANT DISTRICT ENGINEER	DISTRICT ENGINEER		6 11	13
	MARINDUQUE	DETAIL OF RECESSED CEILING	JAN HENRY R. ROSALES ARCHITECT II	DATE:	DATE:	DATE:	DATE:	DATE:		

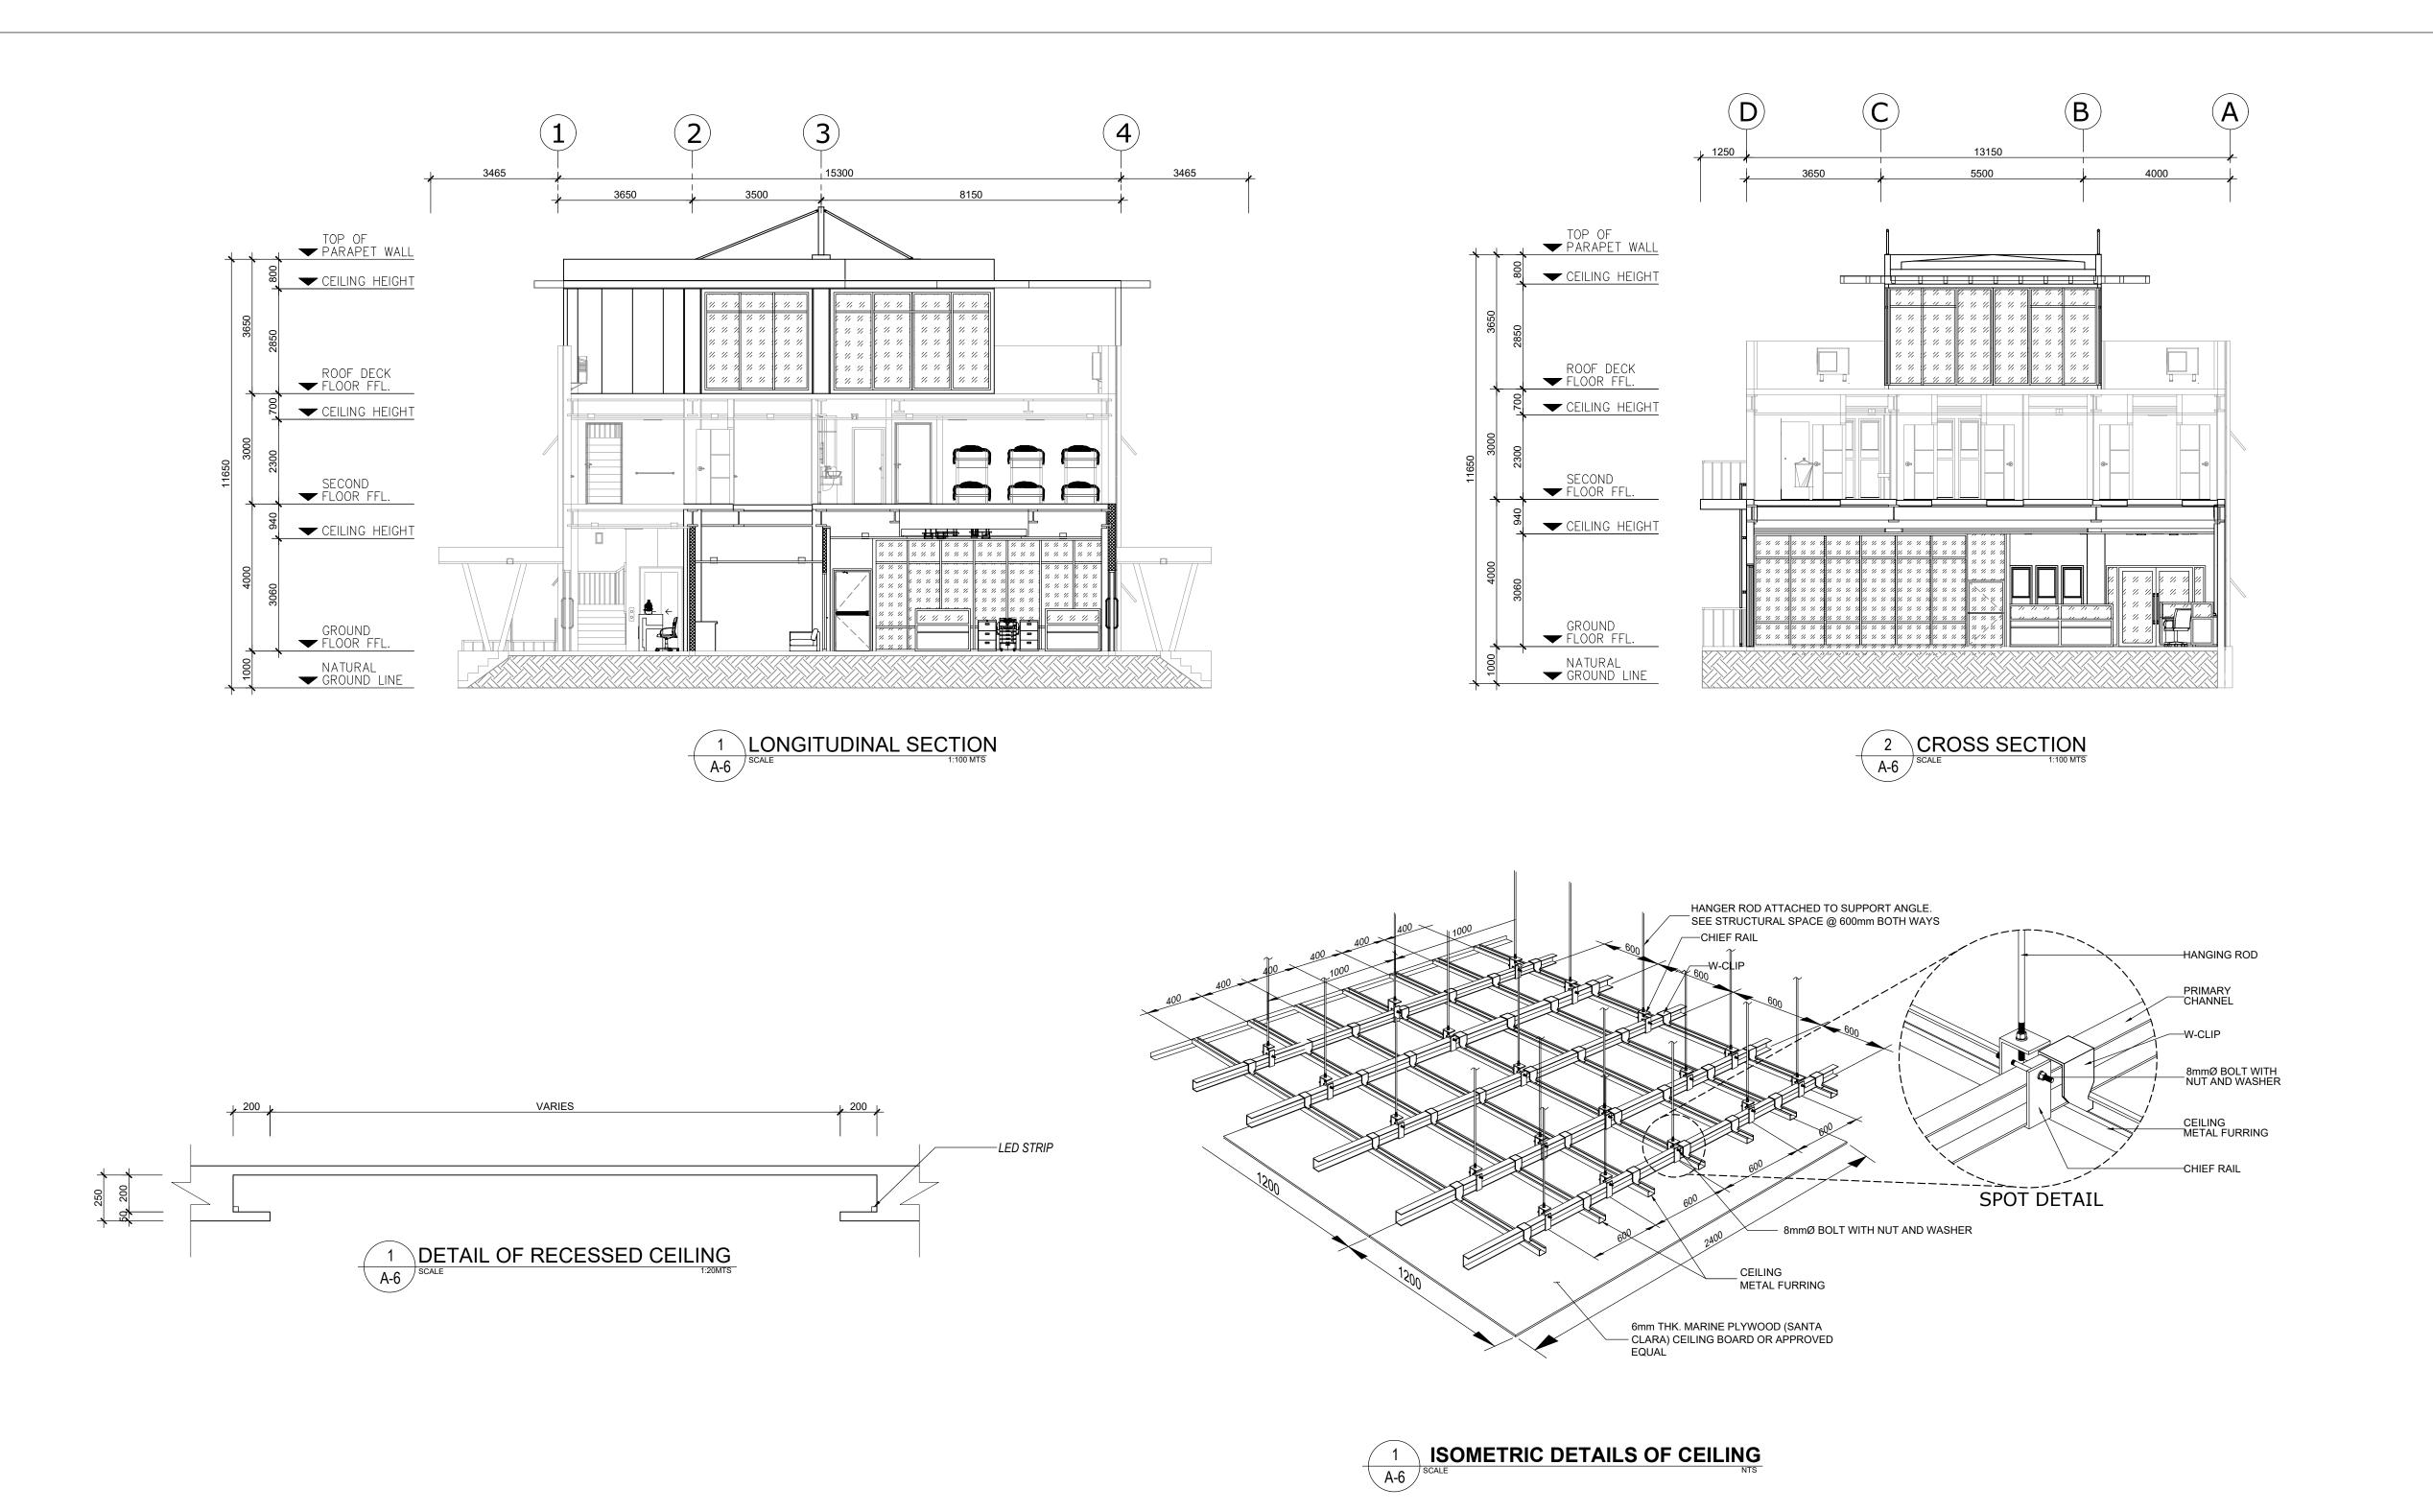



### 1 SCHEDULE OF DOORS AND WINDOWS 1:50 MTS

	PROJECT NAME AND LOCATION:	SHEET CONTENTS:	DRAFTED BY:	REVIEWED BY:	SUBMITTED BY:	RECOMMENDED BY:	APPROVED BY:	CONCURRED BY:	SET NO.	SHEET NO.
REPUBLIC OF THE PHILIPPINES  DEPARTMENT OF PUBLIC WORKS AND HIGHWAYS  REGION IV-B, MIMAROPA  MARINDUQUE DISTRICT ENGINEERING OFFICE BOAC, MARINDUQUE	REHABILITATION/IMPROVEMENT OF ACCESSIBILTY FACILITIES FOR PHYSICALLY CHALLENGED PERSONS, BARANGAY BANGBANGALON BOAC, MARINDUQUE	SCHEDULE OF DOORS AND WINDOWS	KYLE ADRIAN M. JAGONG DRAFTSMAN I  PREPARED BY:  JAN HENRY R. ROSALES ARCHITECT II	DATE:	FERNAN S. DIAZ  CHIEF, PLANNING AND DESIGN SECTION  DATE:	RYAN N. DELA CRUZ OIC - ASSISTANT DISTRICT ENGINEE DATE:	RICHARD EMMANUEL P. RAGRAGIO DISTRICT ENGINEER DATE:	  DATE:	- A 7 11	7 13

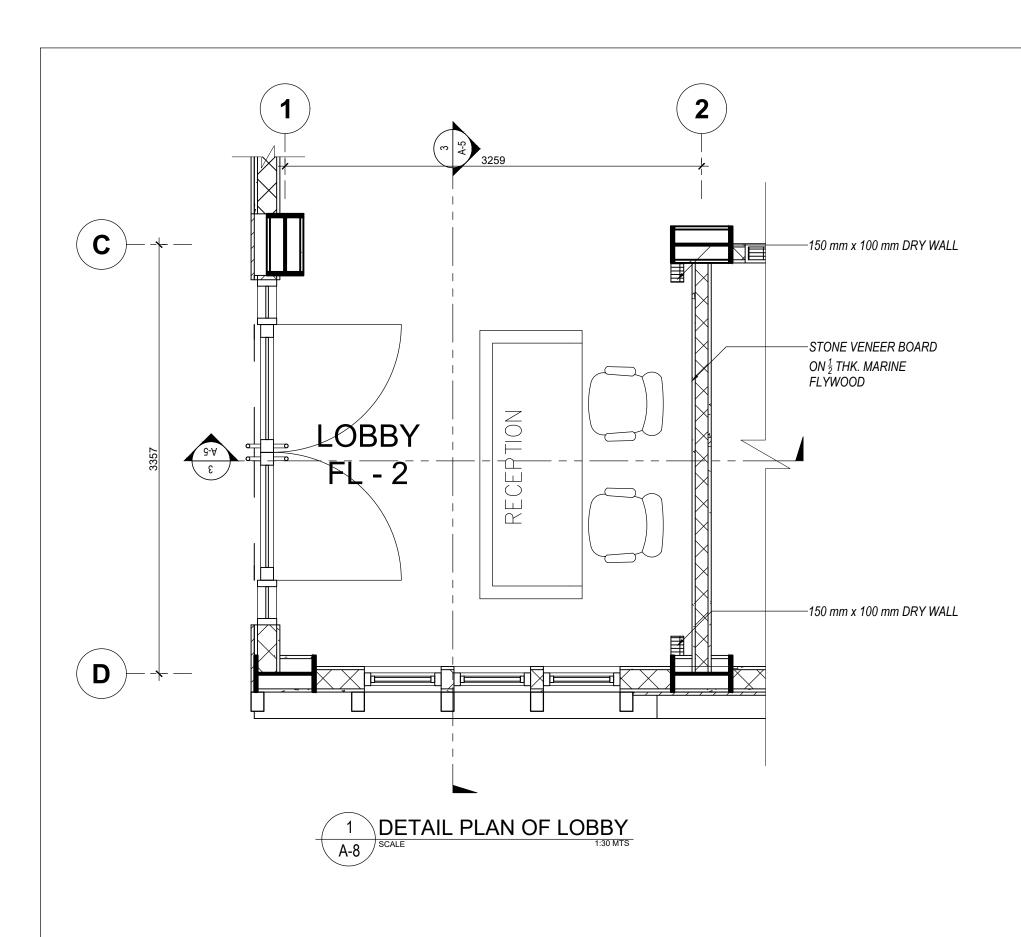

PROJECT NAME AND LOCATION:

REPUBLIC OF THE PHILIPPINES

REGION IV-B, MIMAROPA

MARINDUQUE DISTRICT ENGINEERING OFFICE BOAC, MARINDUQUE

DEPARTMENT OF PUBLIC WORKS AND HIGHWAYS

REHABILITATION/IMPROVEMENT OF

ACCESSIBILTY FACILITIES FOR

PHYSICALLY CHALLENGED

PERSONS, BARANGAY

BANGBANGALON BOAC,

**MARINDUQUE** 


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DETAIL PLAN OF LOBBY


DETAIL SECTION OF LOBBY

DETAIL OF OFFICE CUBICLE

SCHEDULE OF DOORS AND WINDOWS



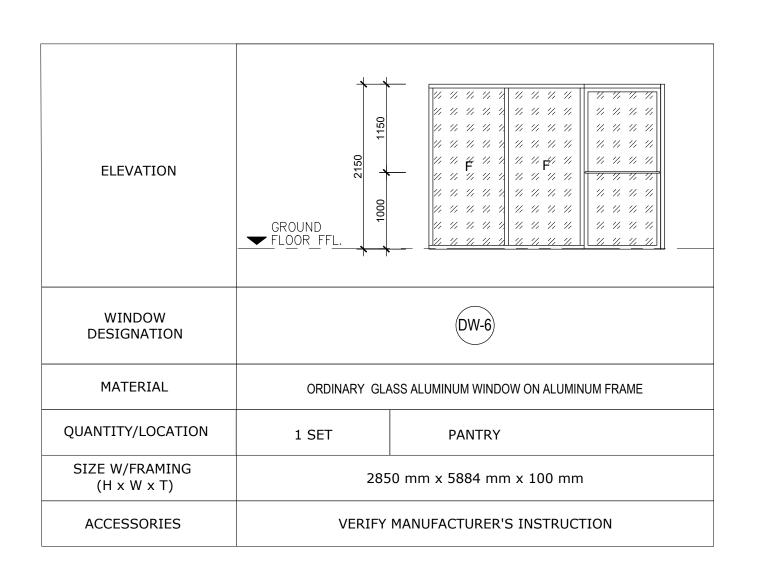

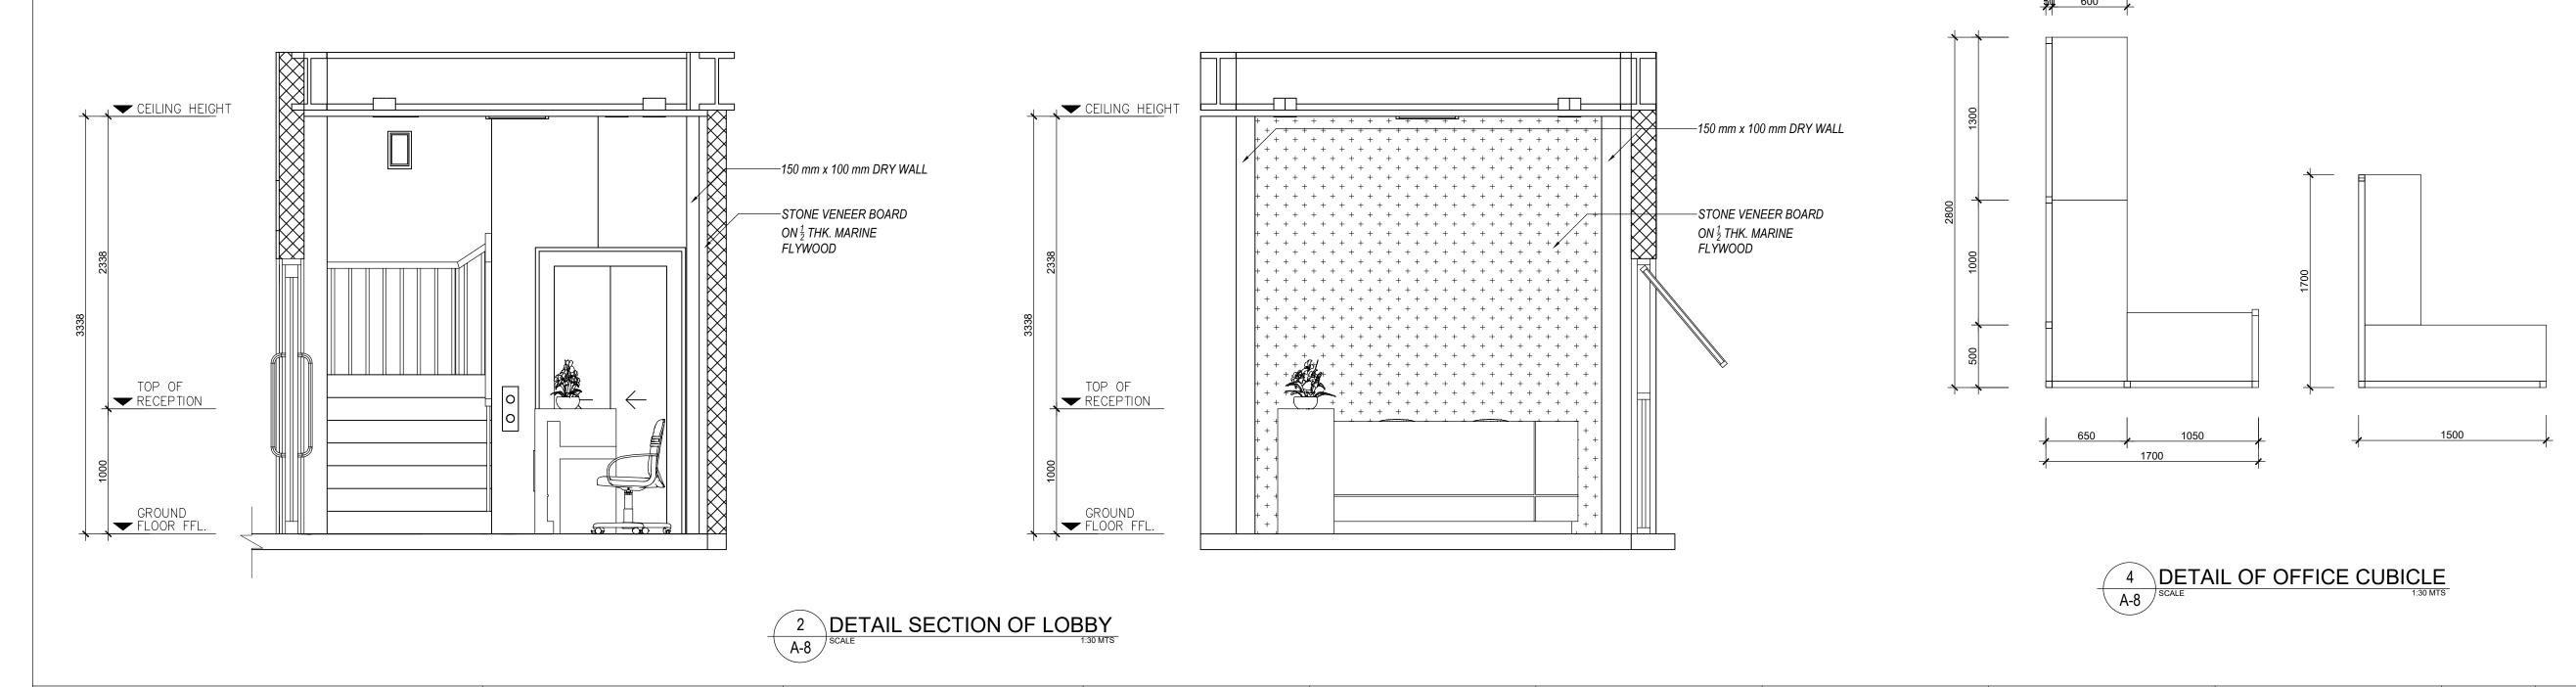

REVIEWED BY:

JINKIE M. MONTERAS

ENGINEER II

SUBMITTED BY:

FERNAN S. DIAZ

CHIEF, PLANNING AND DESIGN

SECTION

RECOMMENDED BY:

RYAN N. DELA CRUZ

OIC - ASSISTANT DISTRICT ENGINEER

APPROVED BY:

RICHARD EMMANUEL P. RAGRAGIO

DISTRICT ENGINEER

CONCURRED BY:

DATE:

SET NO.

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SHEET NO.

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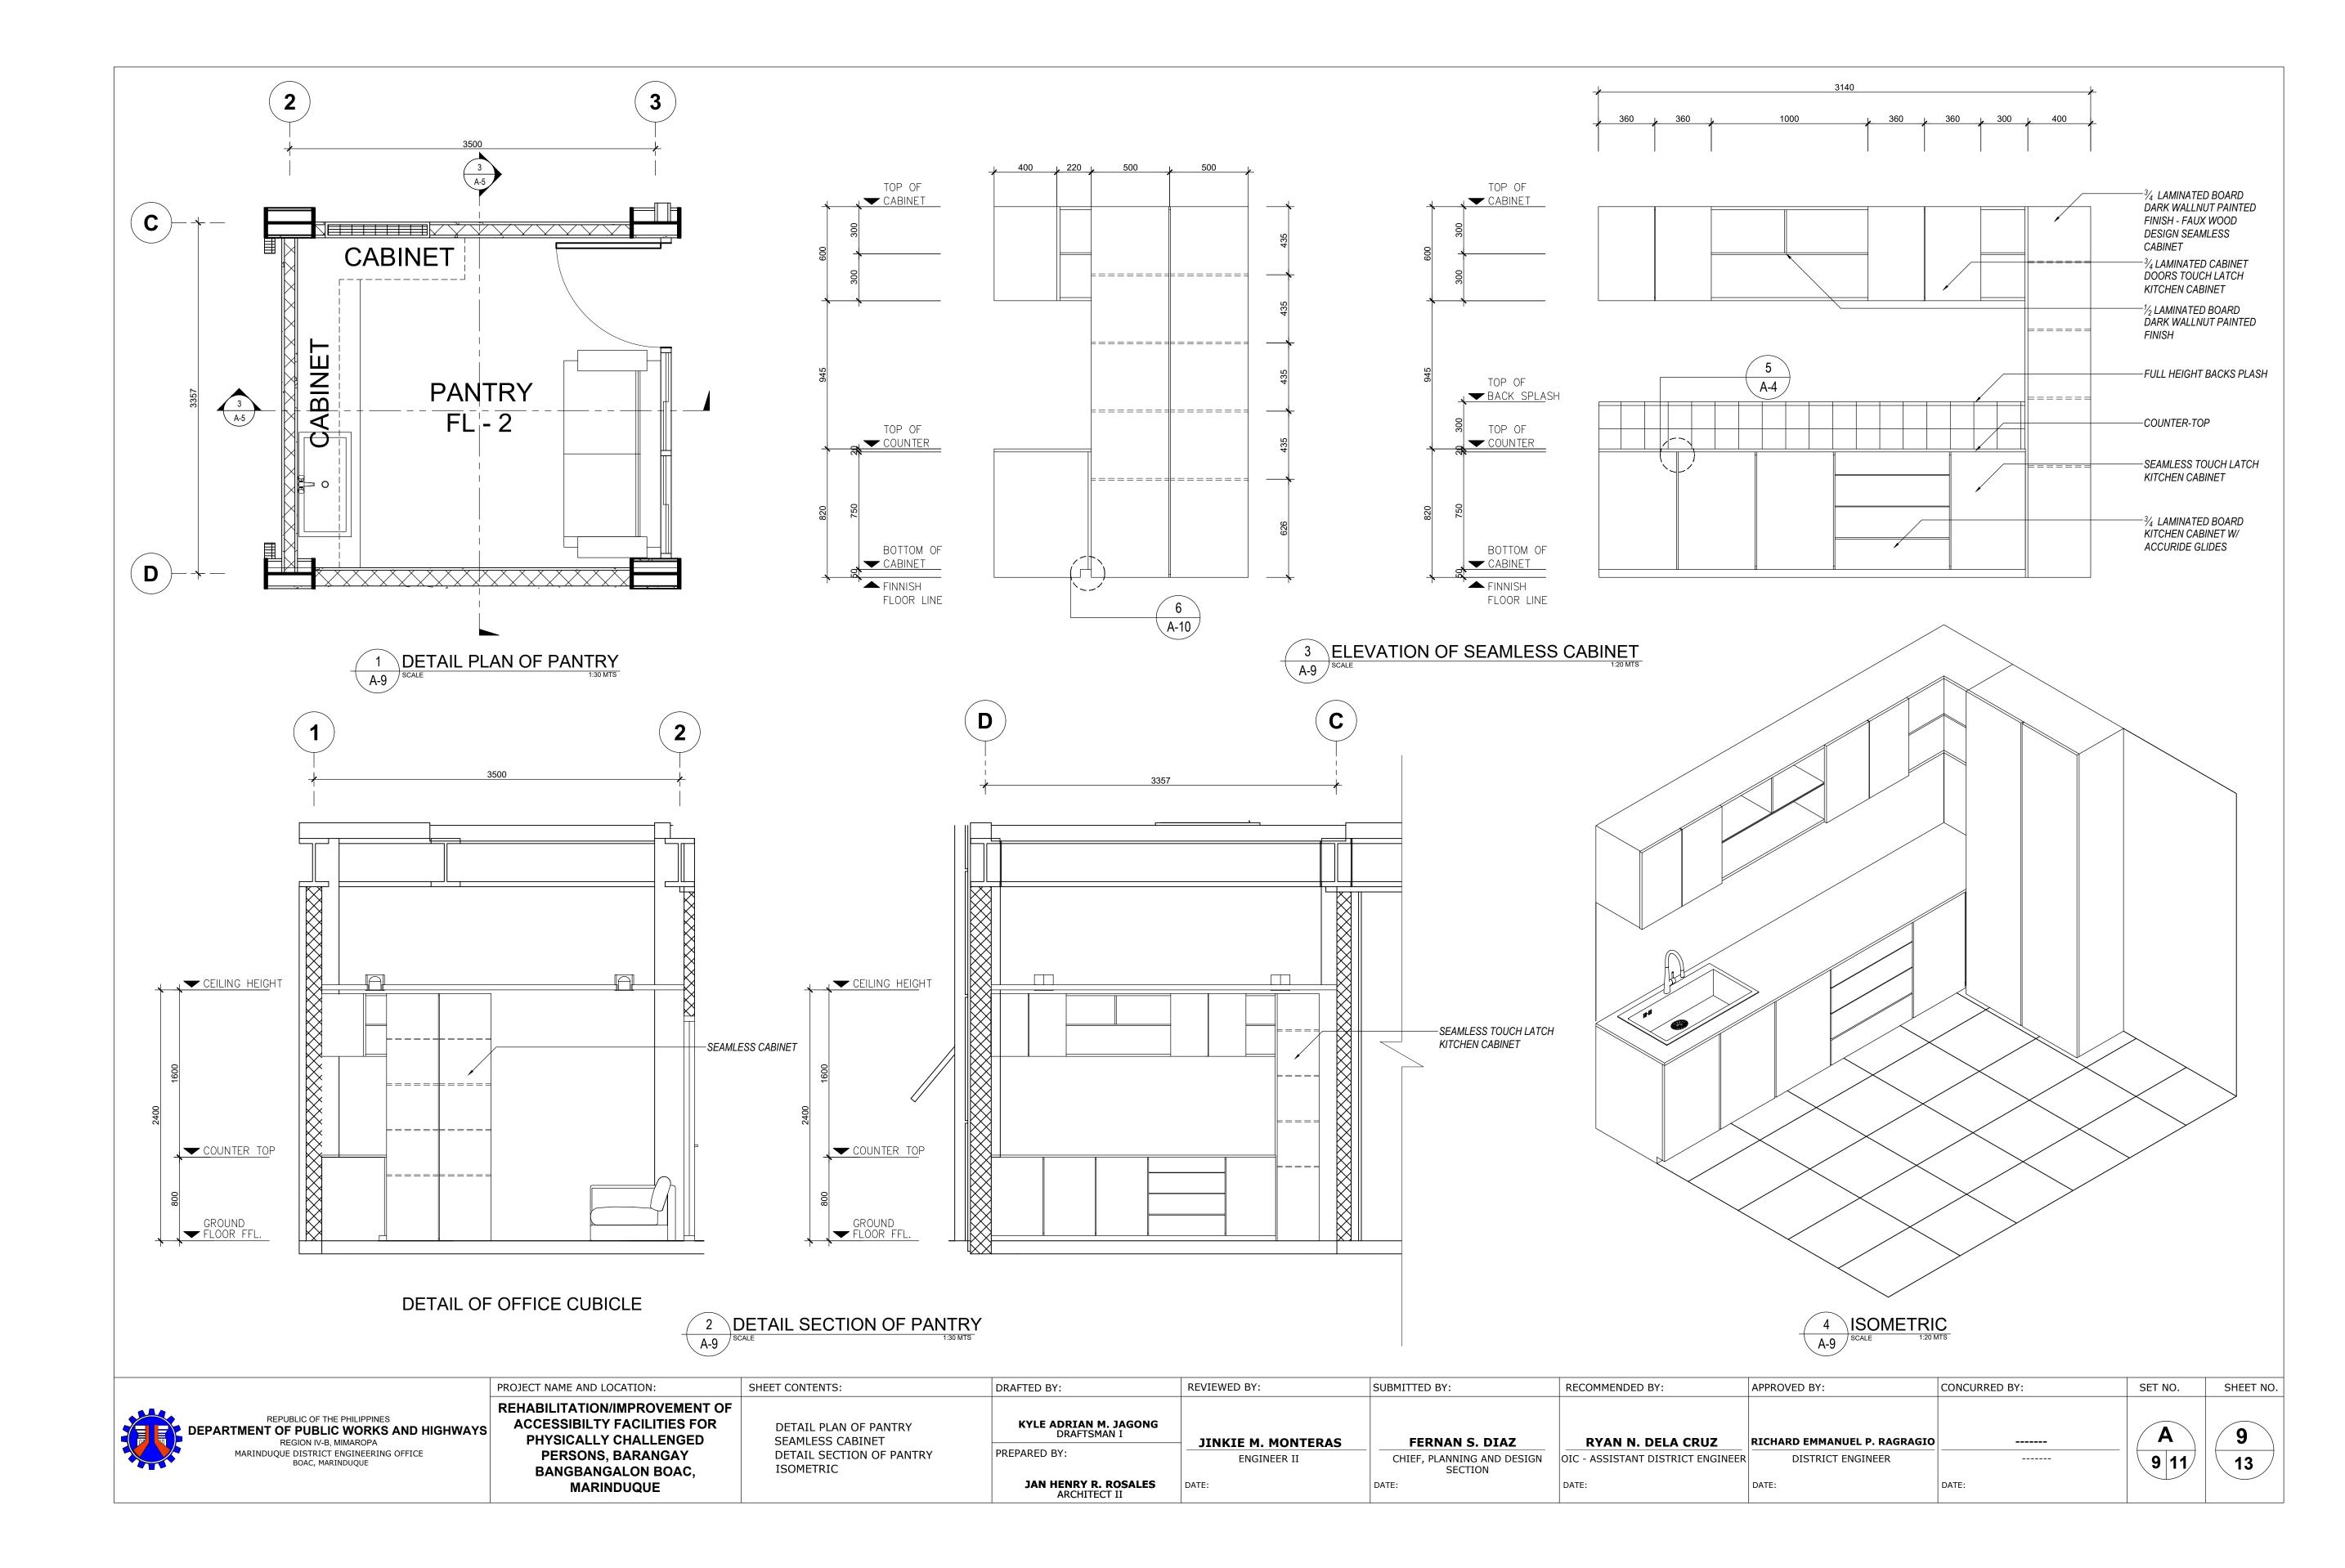
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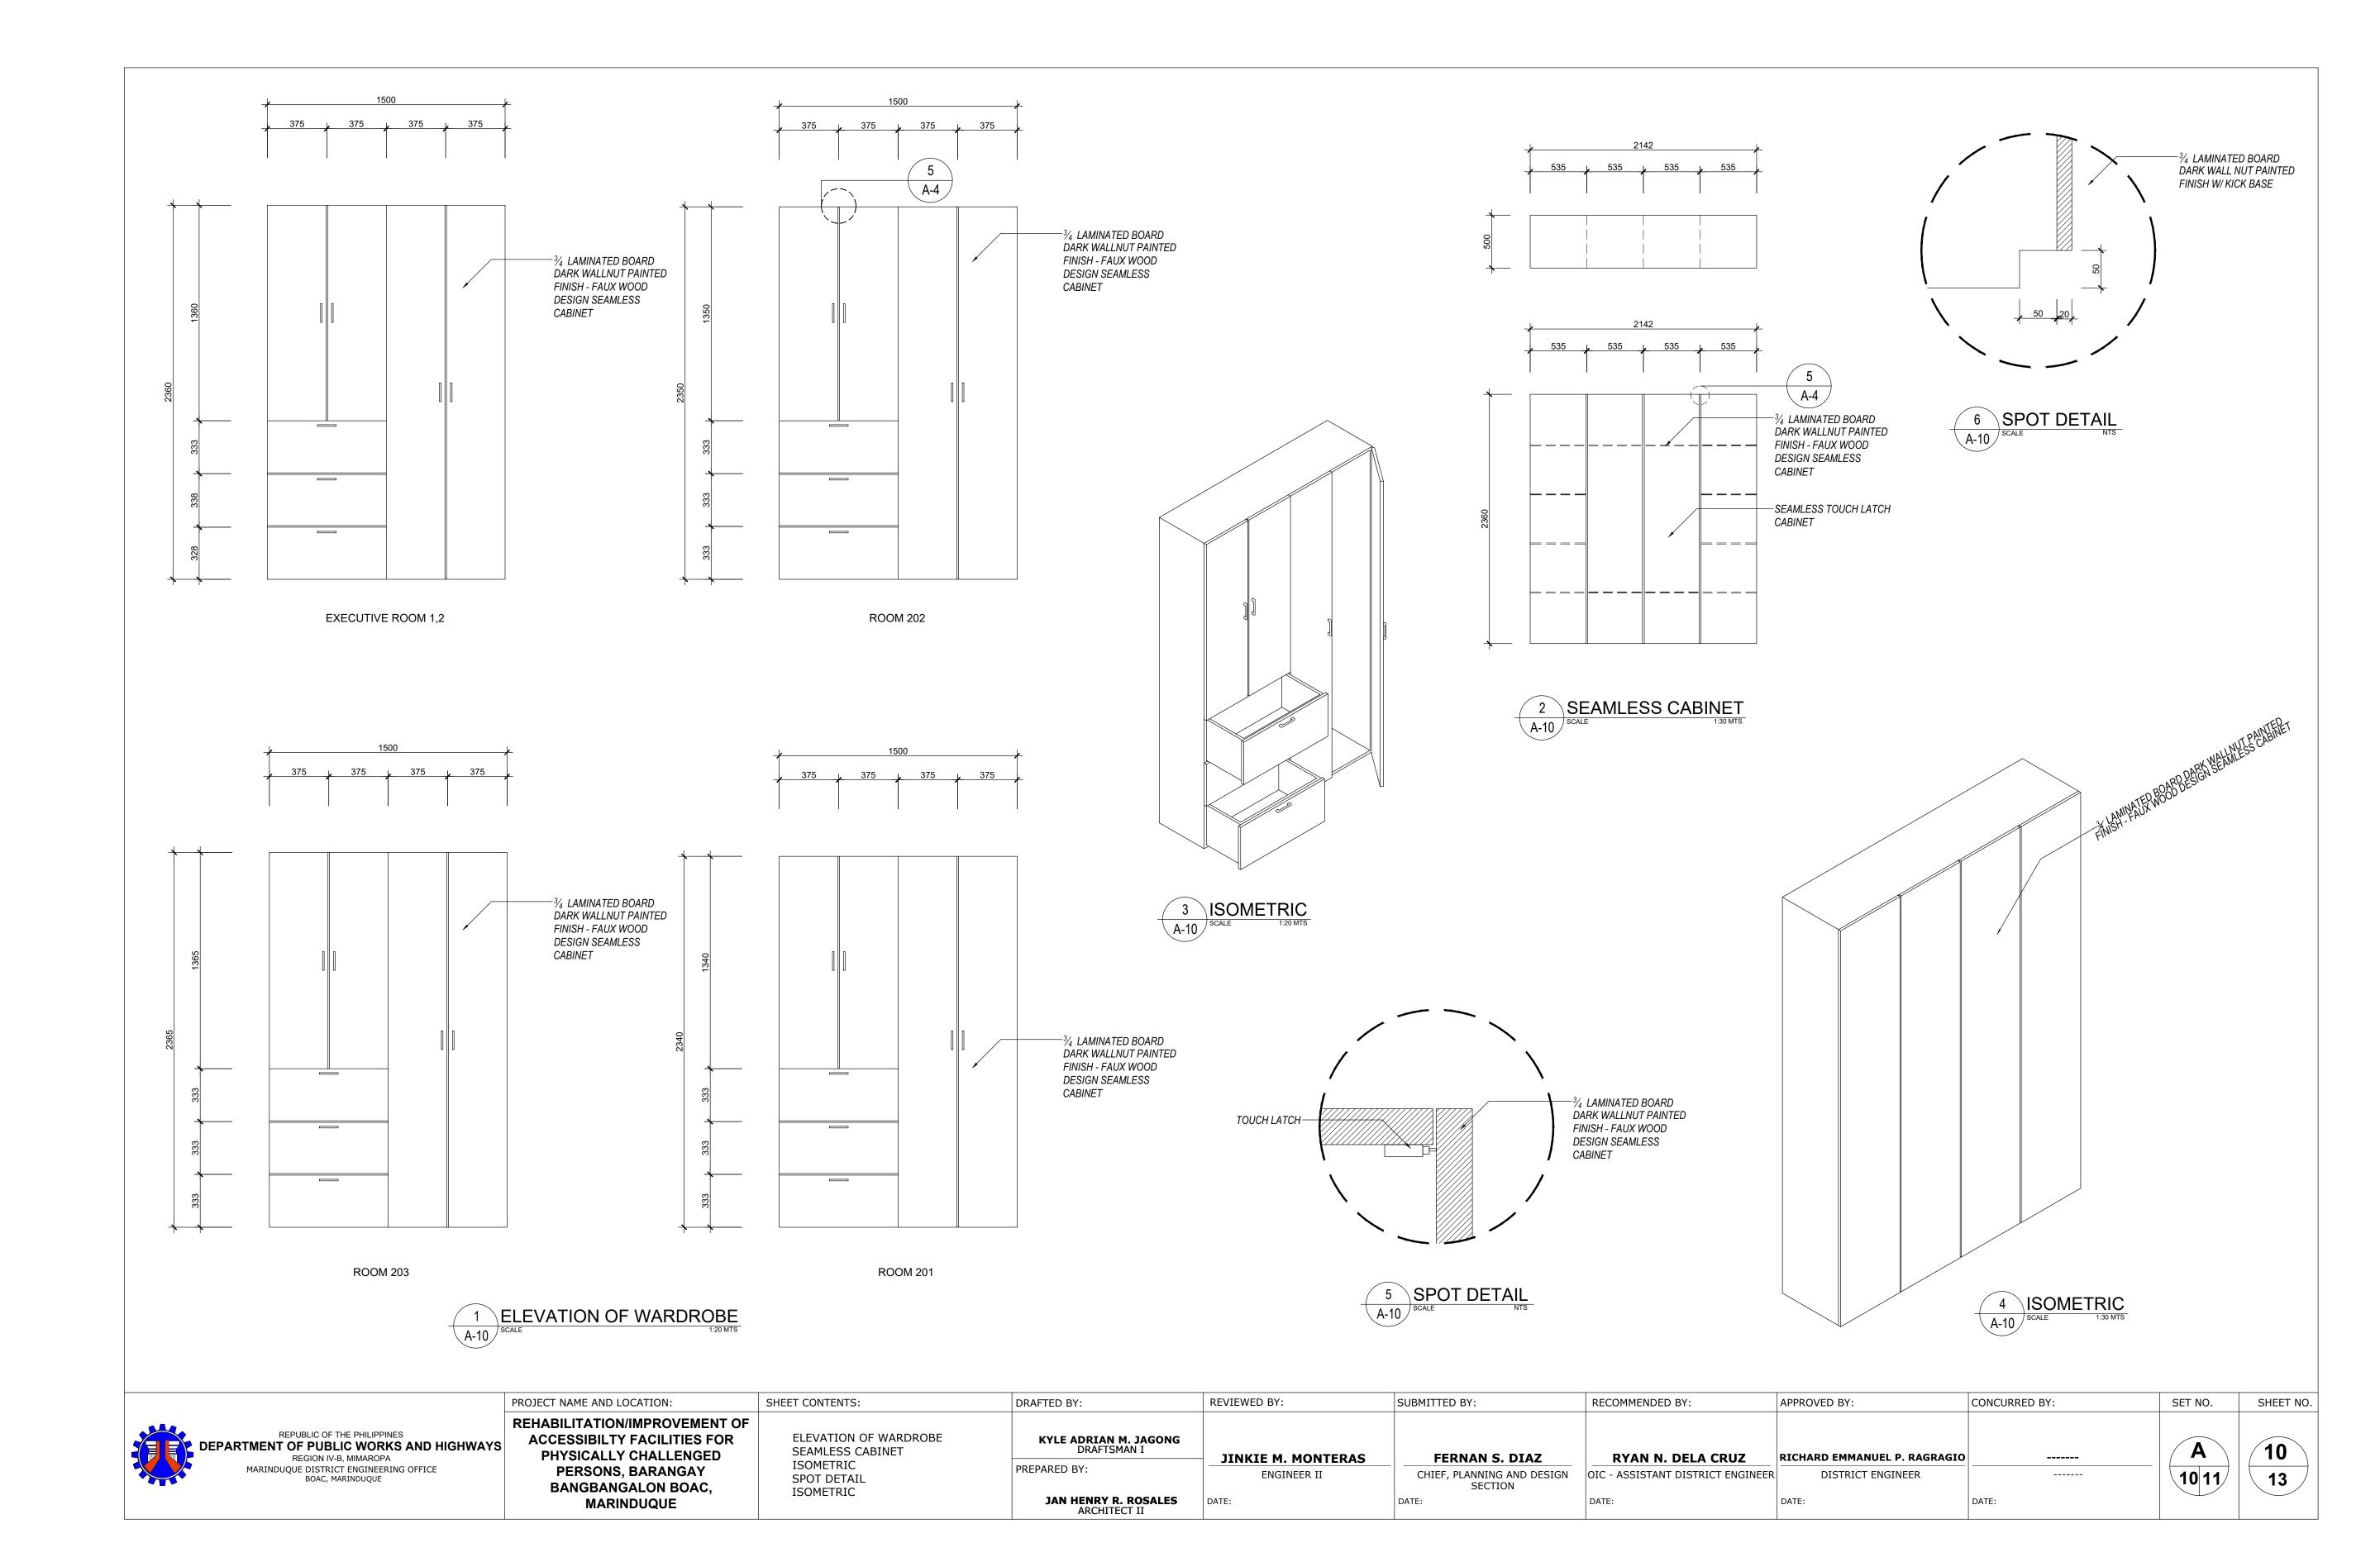
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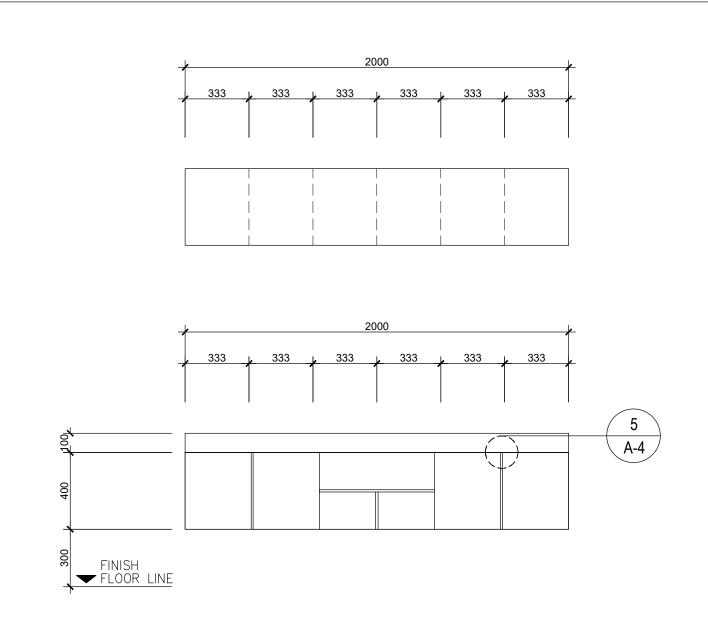
PREPARED BY:

KYLE ADRIAN M. JAGONG DRAFTSMAN I


JAN HENRY R. ROSALES ARCHITECT II










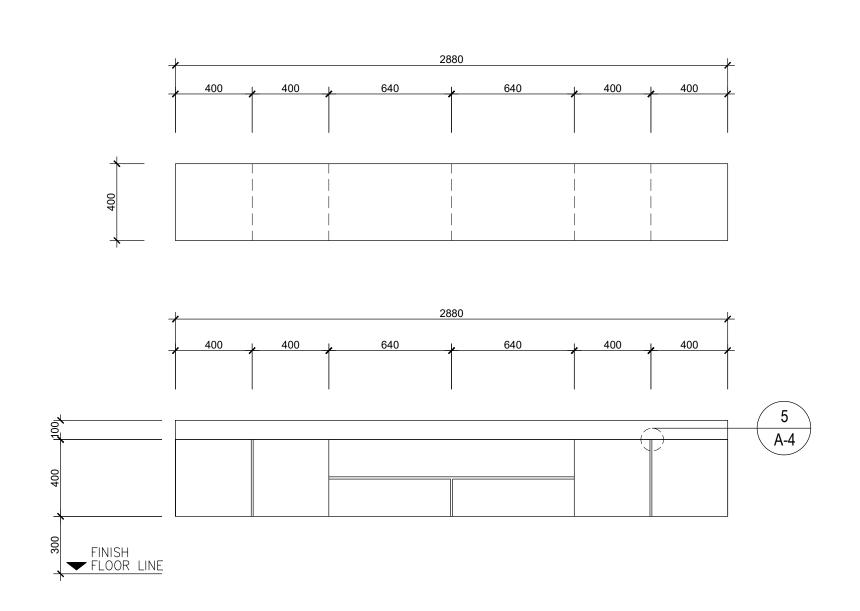




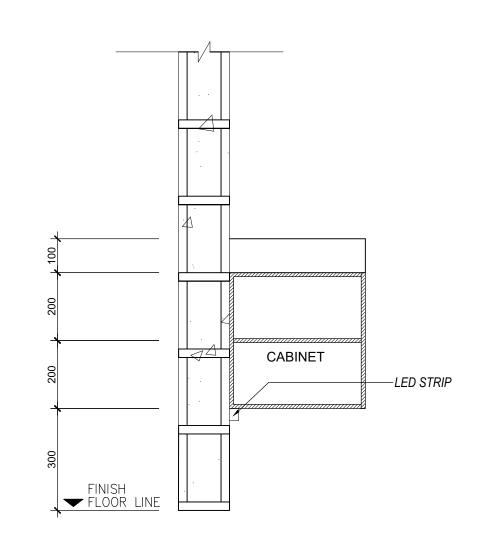


3 DETAIL OF FLOATING CABINET


A-11 SCALE

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	REPUBLIC OF THE PHILIPPINES	
	DEPARTMENT OF PUBLIC WORKS AND HIGHWAYS	
	REGION IV-B, MIMAROPA	
	MARINDUQUE DISTRICT ENGINEERING OFFICE	
	BOAC, MARINDUQUE	
1		

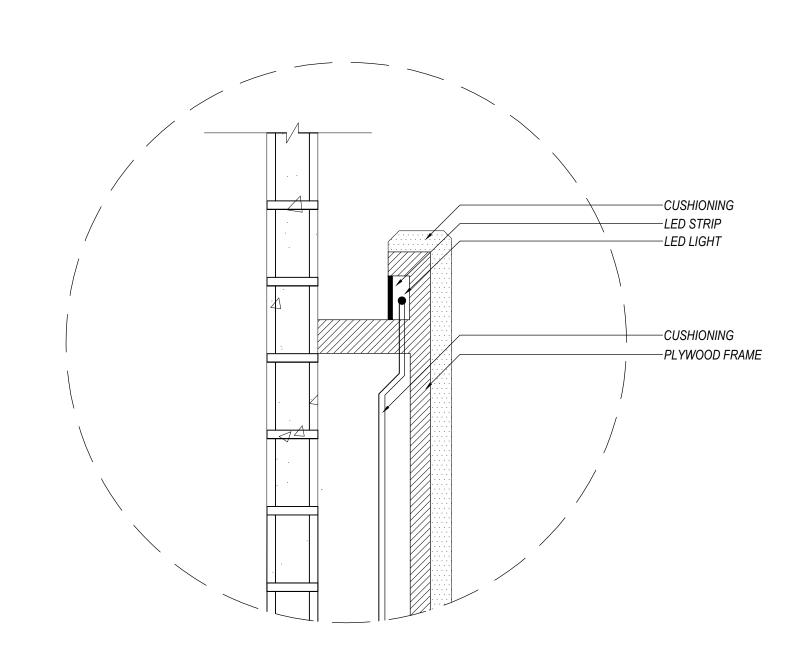	PROJECT NAME AND LOCATION:
	REHABILITATION/IMPROVEMENT OF
S	ACCESSIBILTY FACILITIES FOR PHYSICALLY CHALLENGED
	PERSONS, BARANGAY
	BANGBANGALON BOAC,
	MARINDUQUE

TON:	SHEET CONTENTS:
PROVEMENT OF CILITIES FOR ALLENGED RANGAY ON BOAC,	SEAMLESS TV RACK @ EXECUTIVE SEAMLESS TV RACK @ EXECUTIVE ISOMETRIC ISOMETRIC

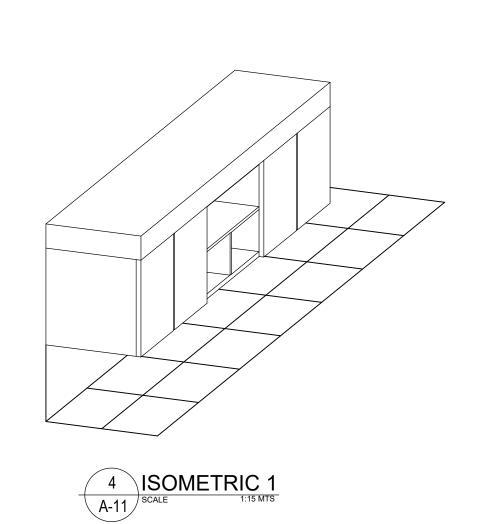	DRAFTED BY:
EXECUTIVE ROOM 1 EXECUTIVE ROOM 2	KYLE AD DI PREPARED BY:

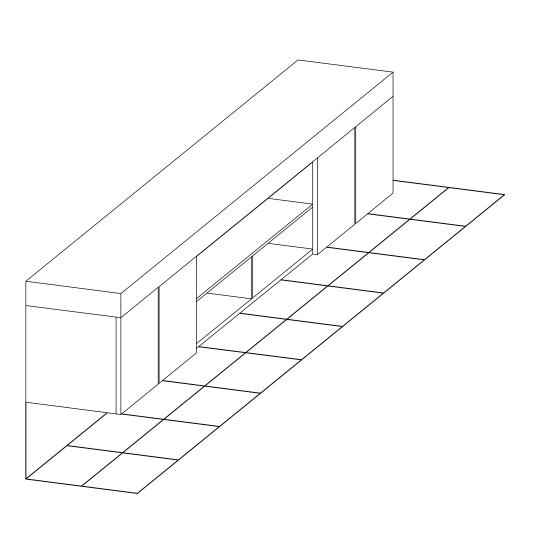
PRAFTED BY:	REVIEWED BY:
<b>KYLE ADRIAN M. JAGONG</b> DRAFTSMAN I	JINKIE M. MONTERAS
REPARED BY:	ENGINEER II
JAN HENRY R. ROSALES ARCHITECT II	DATE:

	SUBMITTED BY:	RECOMMENDED BY:
ERAS	FERNAN S. DIAZ	RYAN N. DEL
	CHIEF, PLANNING AND DESIGN SECTION	OIC - ASSISTANT DIST
	DATE:	DATE:


RYAN N. DELA CRUZ	RICHARD EMMA
OIC - ASSISTANT DISTRICT ENGINEER	DISTRIC
DATE:	DATE:

	APPROVED BY:	CONCURRED BY:	SET NO.
	RICHARD EMMANUEL P. RAGRAGIO		A
NEER			11 11
	DATE:	DATE:	

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RECOMMENDED BY:

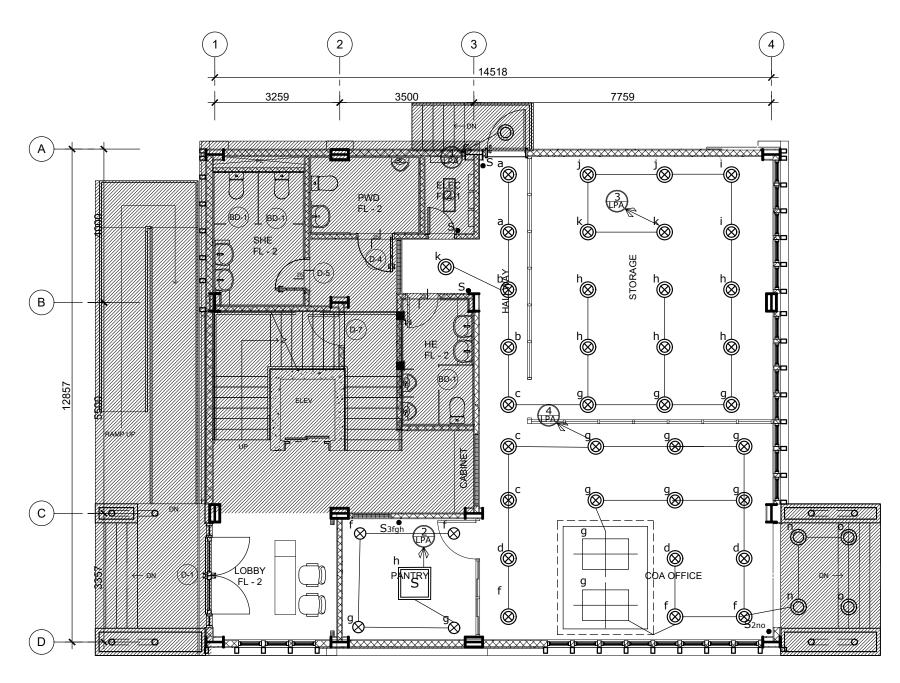APPROVED BY:

DATE:

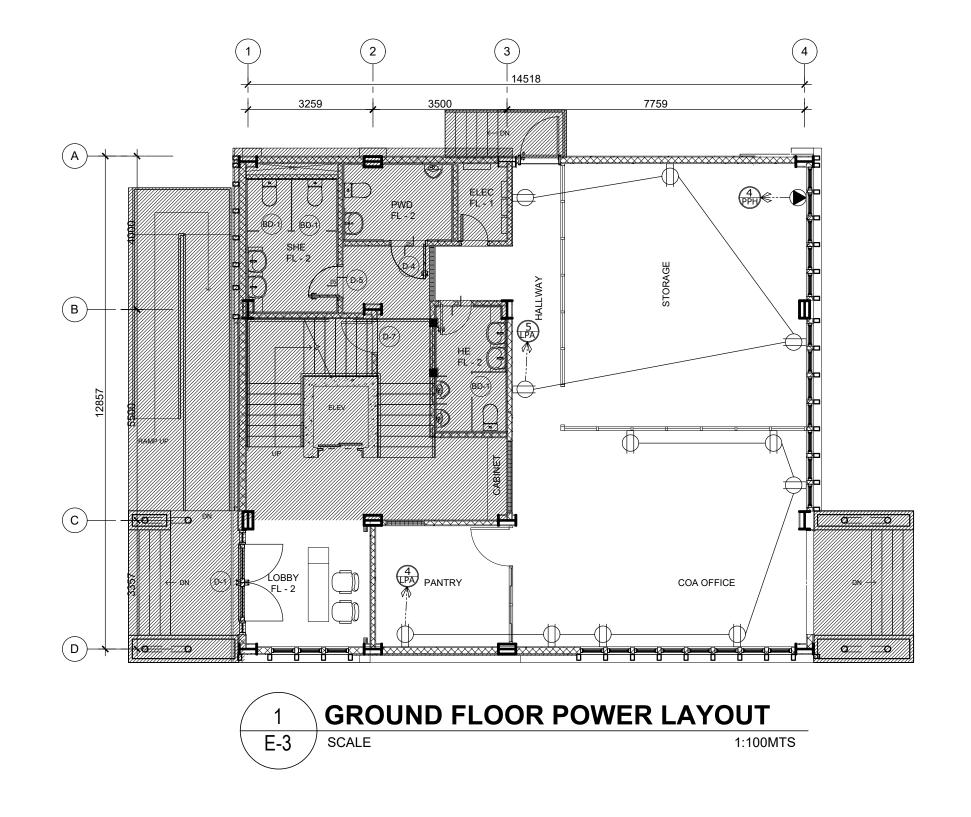DISTRICT ENGINEER

CONCURRED BY:

DATE:

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SHEET NO.

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REHABILITATION/IMPROVEMENT OF REPUBLIC OF THE PHILIPPINES JOHN LOUIE R. LINGON ENGINEER II ACCESSIBILTY FACILITIES FOR DEPARTMENT OF PUBLIC WORKS AND HIGHWAYS

REGION IV-R MIMAROPA REGION IV-B, MIMAROPA MARINDUQUE DISTRICT ENGINEERING OFFICE BOAC, MARINDUQUE PHYSICALLY CHALLENGED **GROUND FLOOR LIGHTING LAYOUT** JINKIE M. MONTERAS **FERNAN S. DIAZ** RYAN N. DELA CRUZ RICHARD EMMANUEL P. RAGRAGIO PREPARED BY: PERSONS, BARANGAY GROUND FLOOR POWER LAYOUT ENGINEER II CHIEF, PLANNING AND DESIGN OIC - ASSISTANT DISTRICT ENGINEER BANGBANGALON BOAC, ADRIAN V. LOZANO ENGINEER II **MARINDUQUE** DATE: DATE:

DRAFTED BY:

REVIEWED BY:

SUBMITTED BY:

SHEET CONTENTS:


PROJECT NAME AND LOCATION:

#### **GENERAL NOTES:**

- 1. ALL ELECTRICAL WORKS SHALL COMPLY WITH THESE PLANS AND SPECIFICATIONS. THE APPLICABLE PROVISIONS OF THE LATEST EDITION OF THE PHILIPPINE ELECTRICAL CODE (PEC), THE RULES AND REGULATIONS OF THE LOCAL ENFORCING AUTHORITY AND THE REQUIREMENTS OF THE LOCAL POWER COMPANY.
- THE ELECTRICAL SERVICE POWER SHALL BE 1-PHASE, 2-WIRE, 230V AC, 60Hz.
- WIRING METHOD SHALL BE AS FOLLOWS: RIGID STEEL CONDUIT OR POLYVINYL CHLORIDE CONDUIT SCHEDULE 40 SHALL BE USED AS SPECIFIED IN THE PLAN.
- ALL WIRES SHALL BE COPPER AND THERMOPLASTIC INSULATED TYPE "THHN" UNLESS OTHERWISE INDICATED IN THE PLAN. THE MINIMUM SIZE WIRE FOR POWER CIRCUIT HOMERUN SHALL BE 3.5mm <sup>2</sup> RATED AT 600VOLTS. LIKE WISE, ALL CONDUCTORS SHALL BE COLOR-CODED. SMALLEST CAN BE USED FOR CONTROL SWITCHES FOR LIGHTING 2 WIRE OF 20 mm
- ALL OUTLET BOXES SHALL BE GALVANIZED GAGE NO. 16 DEEP TYPE.
- ALL MATERIALS TO BE USED SHALL BE BRAND NEW AND APPROVED TYPE FOR THE PARTICULAR LOCATION AND USAGE.
- EQUIPMENT GROUNDING SYSTEM SHALL BE PROVIDED TO THE ELECTRICAL SYSTEM AS PER PHILIPPINE ELECTRICAL CODE REQUIREMENT
- MOUNTING HEIGHT OF WIRING DEVICES SHALL BE AS FOLLOWS:
  - a. LIGHT SWITCH
- 1.20M ABOVE FINISH FLOOR
- 0.60M ABOVE FINISH FLOOR FOR EXECUTIVE ROOM
- HEADBOARD
- 0.3M ABOVE FINISH FLOOR CONVENIENCE OUTLET
- ALL ELECTRICAL WORKS SHALL BE DONE UNDER THE DIRECT AND IMMEDIATE SUPERVISION OF ADULY REGISTERED ELECTRICAL ENGINEER OR REGISTERED MASTER **ELECTRICIAN**
- 10. PANEL BOARD SHALL BE MADE UP OF GAUGE #18 G.I. SHEETS FOR BODY AND COVER SPRAY PAINT IN COLOY GRAY. ALL CIRCUIT BREAKERS ARE BOLT ON AND ALL BUS BARS WITH COLOR CODED HEAT SHRINKABLE TUBE INSULATION WITH PROVISION OF 50% GROUNDING BUS OF THH MAIN BUS.
- 11. ENCLOSURE FINISHED SHALL BE SPRAY PAINT IN COLOR GRAY.
- PROVIDE A 50% GROUNDING BUS OF THE MAIN BUS.
- ENCLOSURE FINISHED SHALL BE SPRAY PAINT IN COLOR GRAY FOR BODY AND COVER.
- ALL BUS BARS WITH COLOR CODED HEAT SHRINKABLE TUBE INSULATION.
- ALL CIRCUIT BREAKERS ARE BOLT ON.

#### LEGEND:

SYMBOL	DESCRIPTION
S	SLIM LED PANEL 40WATTS, 230V, 60Hz
<b>⊗</b>	RECESSED PIN LIGHT/DOWNLIGHT WITH 18W LED BULB, 230V, 60Hz
0	RECESSED PIN LIGHT/DOWNLIGHT WITH 12W LED BULB, 230V, 60Hz
	CHANDELIER
•	DOUPLEX CONVINIENCE OUTLET GROUNDING TYPE
LP	CIRCUIT HOMERUN
•	LIGHTING SWITCH LOCATION
$\searrow$	CUT-OFF
L.O.	LIGHTING OUTLET
C.O.	CONVINIENCE OUTLET
6	CIRCUIT BREAKER
S	SINGLE GANG SWITCH
S2	TWO GANG SWITCH
S3	THREE GANG SWITCH

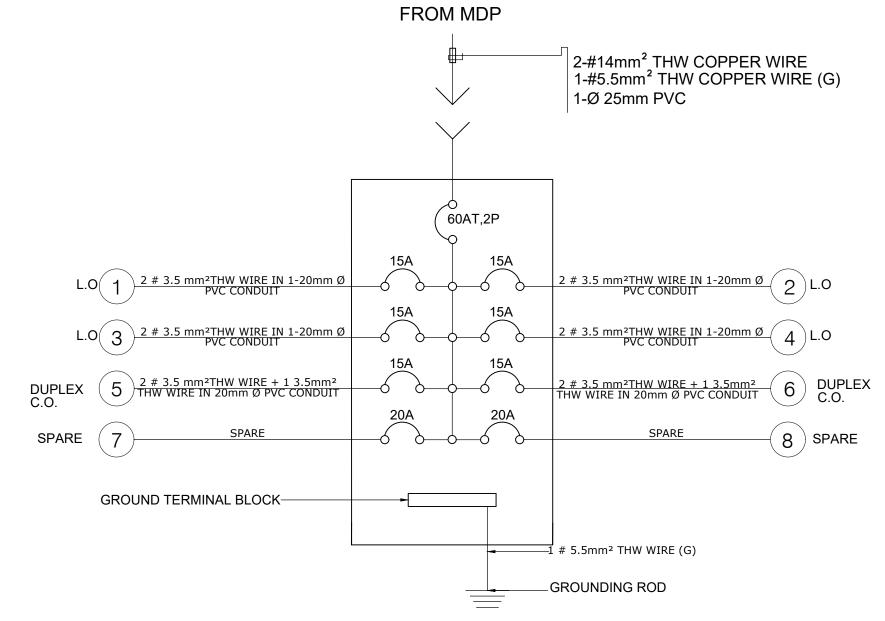






#### SCHEDULE OF LOADS LPA(EXISTING)


CIRCUIT			OUTLETS				SWITCHES			VOLT.	AMP.	VOLTS	OCPD BOLT-ON			N	SIZE OF WIRE	SIZE OF PVC	AREA SERVED
NUMBER		O.L.	MOTOR	C.O.	L.O.	S	S2	S3	S3W	/ AMP.	Arii .	VOLIS	AT	AF	POLE	KAIC		ø mm	AIREN SERVED
1	LIGHTING POINTS		6-EF		14	2	5			2000	8.69	230V	15	50	2	10	2 # 3.5 mm <sup>2</sup> THW WIRE	20 MMØ	THIRD FLOOR
2	LIGHTING POINTS				17		1	2	2	1700	7.39	230V	15	50	2	10	2 # 3.5 mm² THW WIRE	20 MMØ	THIRD FLOOR/ROOF DEC
3	LIGHTING POINTS				26		2	3		2600	11.3	230V	15	50	2	10	2 # 3.5 mm <sup>2</sup> THW WIRE	20 MMØ	THIRD FLOOR
4	LIGHTING POINTS				5	1	1			1000	4.35	230V	15	50	2	10	2 # 3.5 mm² THW WIRE	20 MMØ	THIRD FLOOR
5	DUPLEX CONVINIENCE OUTLET			7						1260	5.48	230V	15	50	2	10	2 # 3.5mm <sup>2</sup> THW WIRE 1#3.5mm <sup>2</sup> THW WIRE	20 MMØ	THIRD FLOOR
6	DUPLEX CONVINIENCE OUTLET			7						1260	5.48	230V	15	50	2	10	2 # 3.5mm <sup>2</sup> THW WIRE 1#3.5mm <sup>2</sup> THW WIRE	20 MMØ	THIRD FLOOR
7	SPARE									1500	6.52	230V	20	50	2	10	SPARE	SPARE	SPARE
8	SPARE									1500	6.52	230V	20	50	2	10	SPARE	SPARE	SPARE
	TOTAL				•	•	•			12,820			•						
-	MAXIMUM DEMAND IN  KVA:	12,8	320 VA		O . C .					P. D BC	LT ON						SERVICE ENTRANCE CONDUCTOR:	2 #14MM² THW W	/IRE
MAXIMUM DEMAND IN AMP:				B	BREAK	ER	1	<b>Т</b>	AF	Р	KAI	C QT	۲.	TYPE	V	OLTS	GROUNDING CONDUCTOR:	1 # 5.5MM <sup>2</sup> THW V	VIRF
				MAIN		N		60	100	2	18	1		MCCE	3 2	230		5.5v v	
				BRANCH		LIEC		15	50	2	10	6		MCB		230	MAIN CONDUIT:	1Ø 25MM PVC	
			BRANC		MINCI	2		20	50	2	10	10 2 MCB 230			-2 -3				

### LPA - LIGHTING & POWER PANEL BOARD 1ST FLOOR (EXISTING)

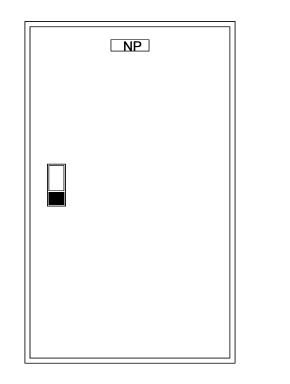


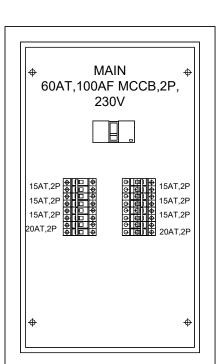

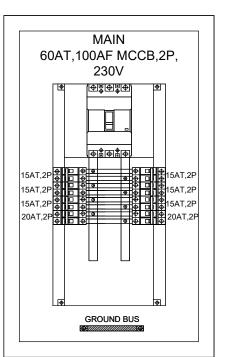

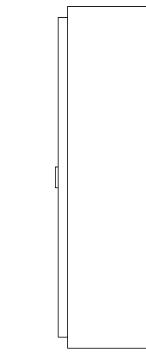



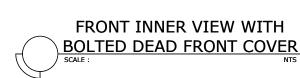





PROJECT NAME AND LOCATION:

REHABILITATION/IMPROVEMENT OF **ACCESSIBILTY FACILITIES FOR** PHYSICALLY CHALLENGED PERSONS, BARANGAY BANGBANGALON BOAC, MARINDUQUE

FOR MAIN FEEDER CONDUCTOR

 $I_L = 10,897 \text{ VA} = 47.38 \text{ A}$ 

USE: 2NOS.14 mm<sup>2</sup> THW WIRE

1NO. 5.5 mm<sup>2</sup> THW WIRE (G)

IN 1Ø 25 mmØ PVC CONDÙIŤ

GENERAL NOTES SCHEDULE OF LOADS LPA(EXISTING) SINGLE LINE RISER DIAGRAM

SHEET CONTENTS:

FOR MAIN DISCONNECTION

USE:60AT, 100AF,2P, MCCB ACB BOLT ON WITH 6 Nos. 15AT, 50AF & 2 Nos. 20AT, 50AF

MCB WITH GROUND BUS


DRAFTED BY: REVIEWED BY: JOHN LOUIE R. LINGON ENGINEER II JINKIE M. MONTERAS PREPARED BY: ADRIAN V. LOZANO DATE:

ENGINEER II

SUBMITTED BY: **FERNAN S. DIAZ** CHIEF, PLANNING AND DESIGN SECTION

RYAN N. DELA CRUZ OIC - ASSISTANT DISTRICT ENGINEER

RECOMMENDED BY: APPROVED BY: RICHARD EMMANUEL P. RAGRAGIO DISTRICT ENGINEER

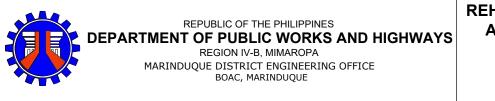



**COMPUTATIONS:** 


GENERAL LIGHTING & SMALL APPLIANCE LOAD 85%= 12,820VA x 0.85


=10,897 VA


CONCURRED BY: SET NO. SHEET NO. **13** 2 2 13 DATE:

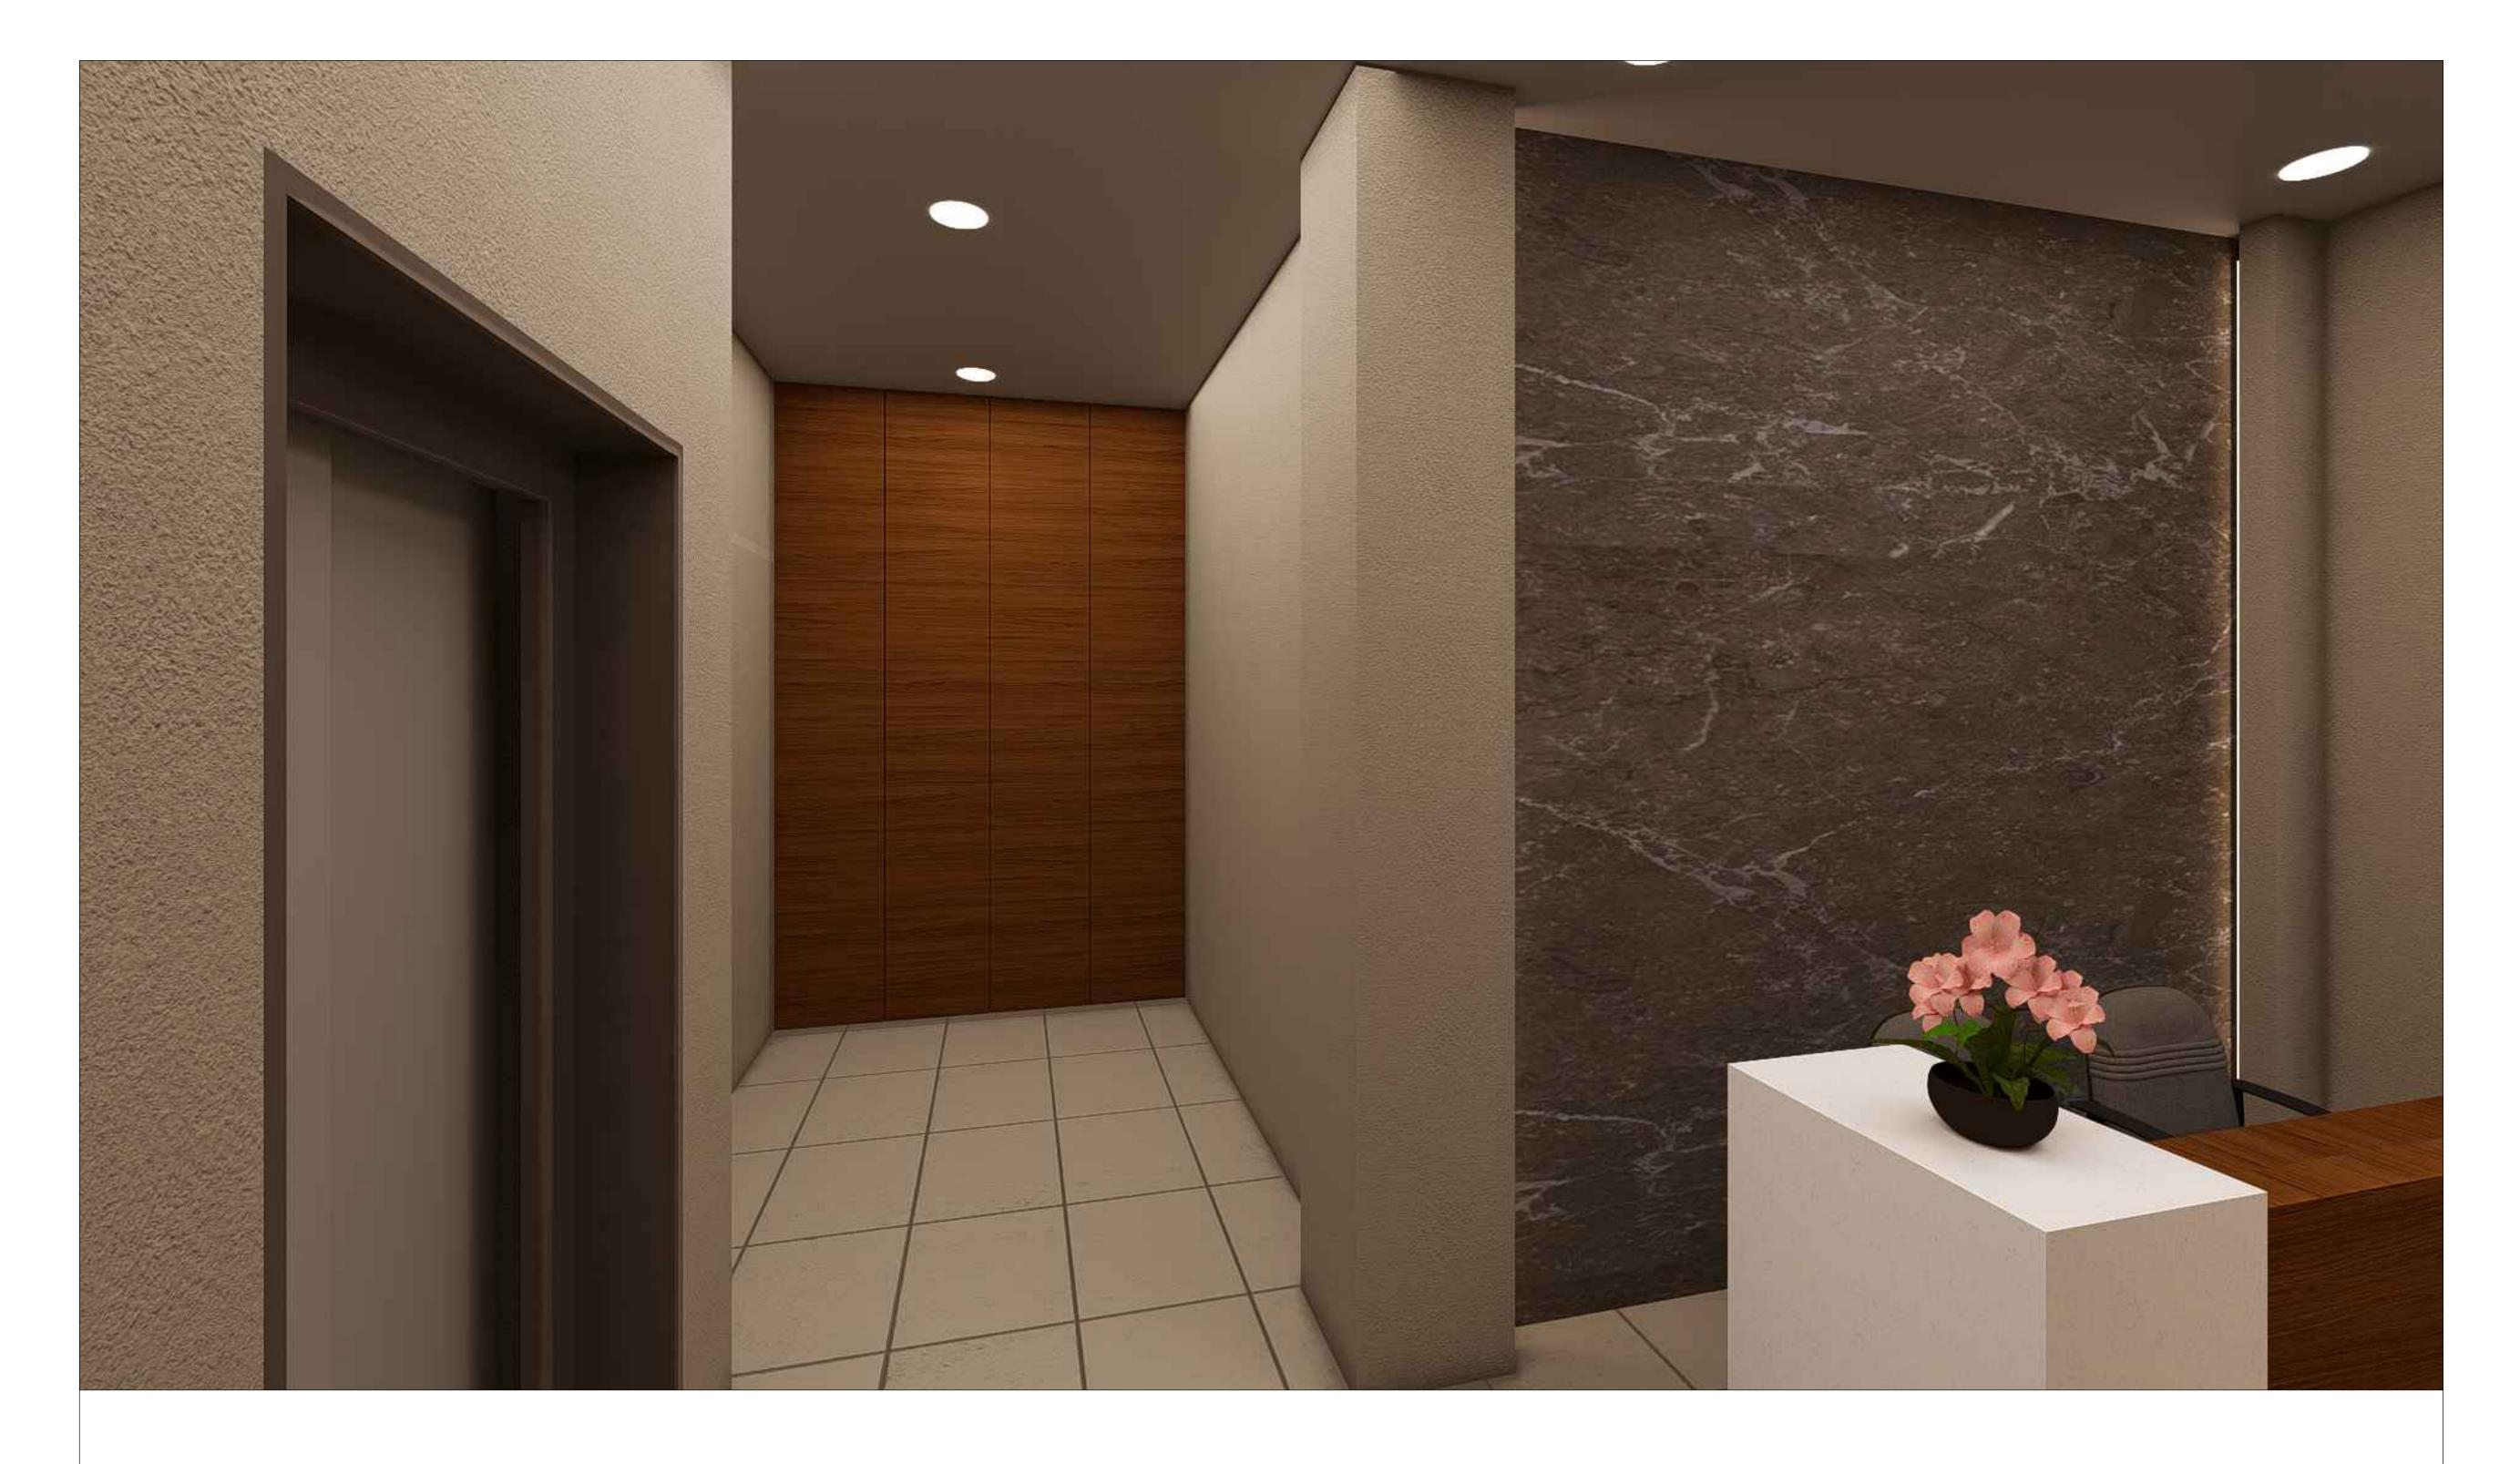


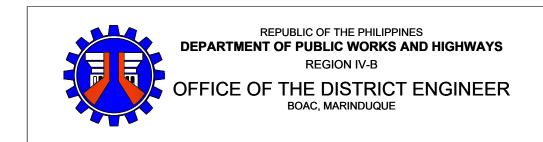


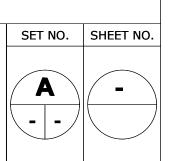

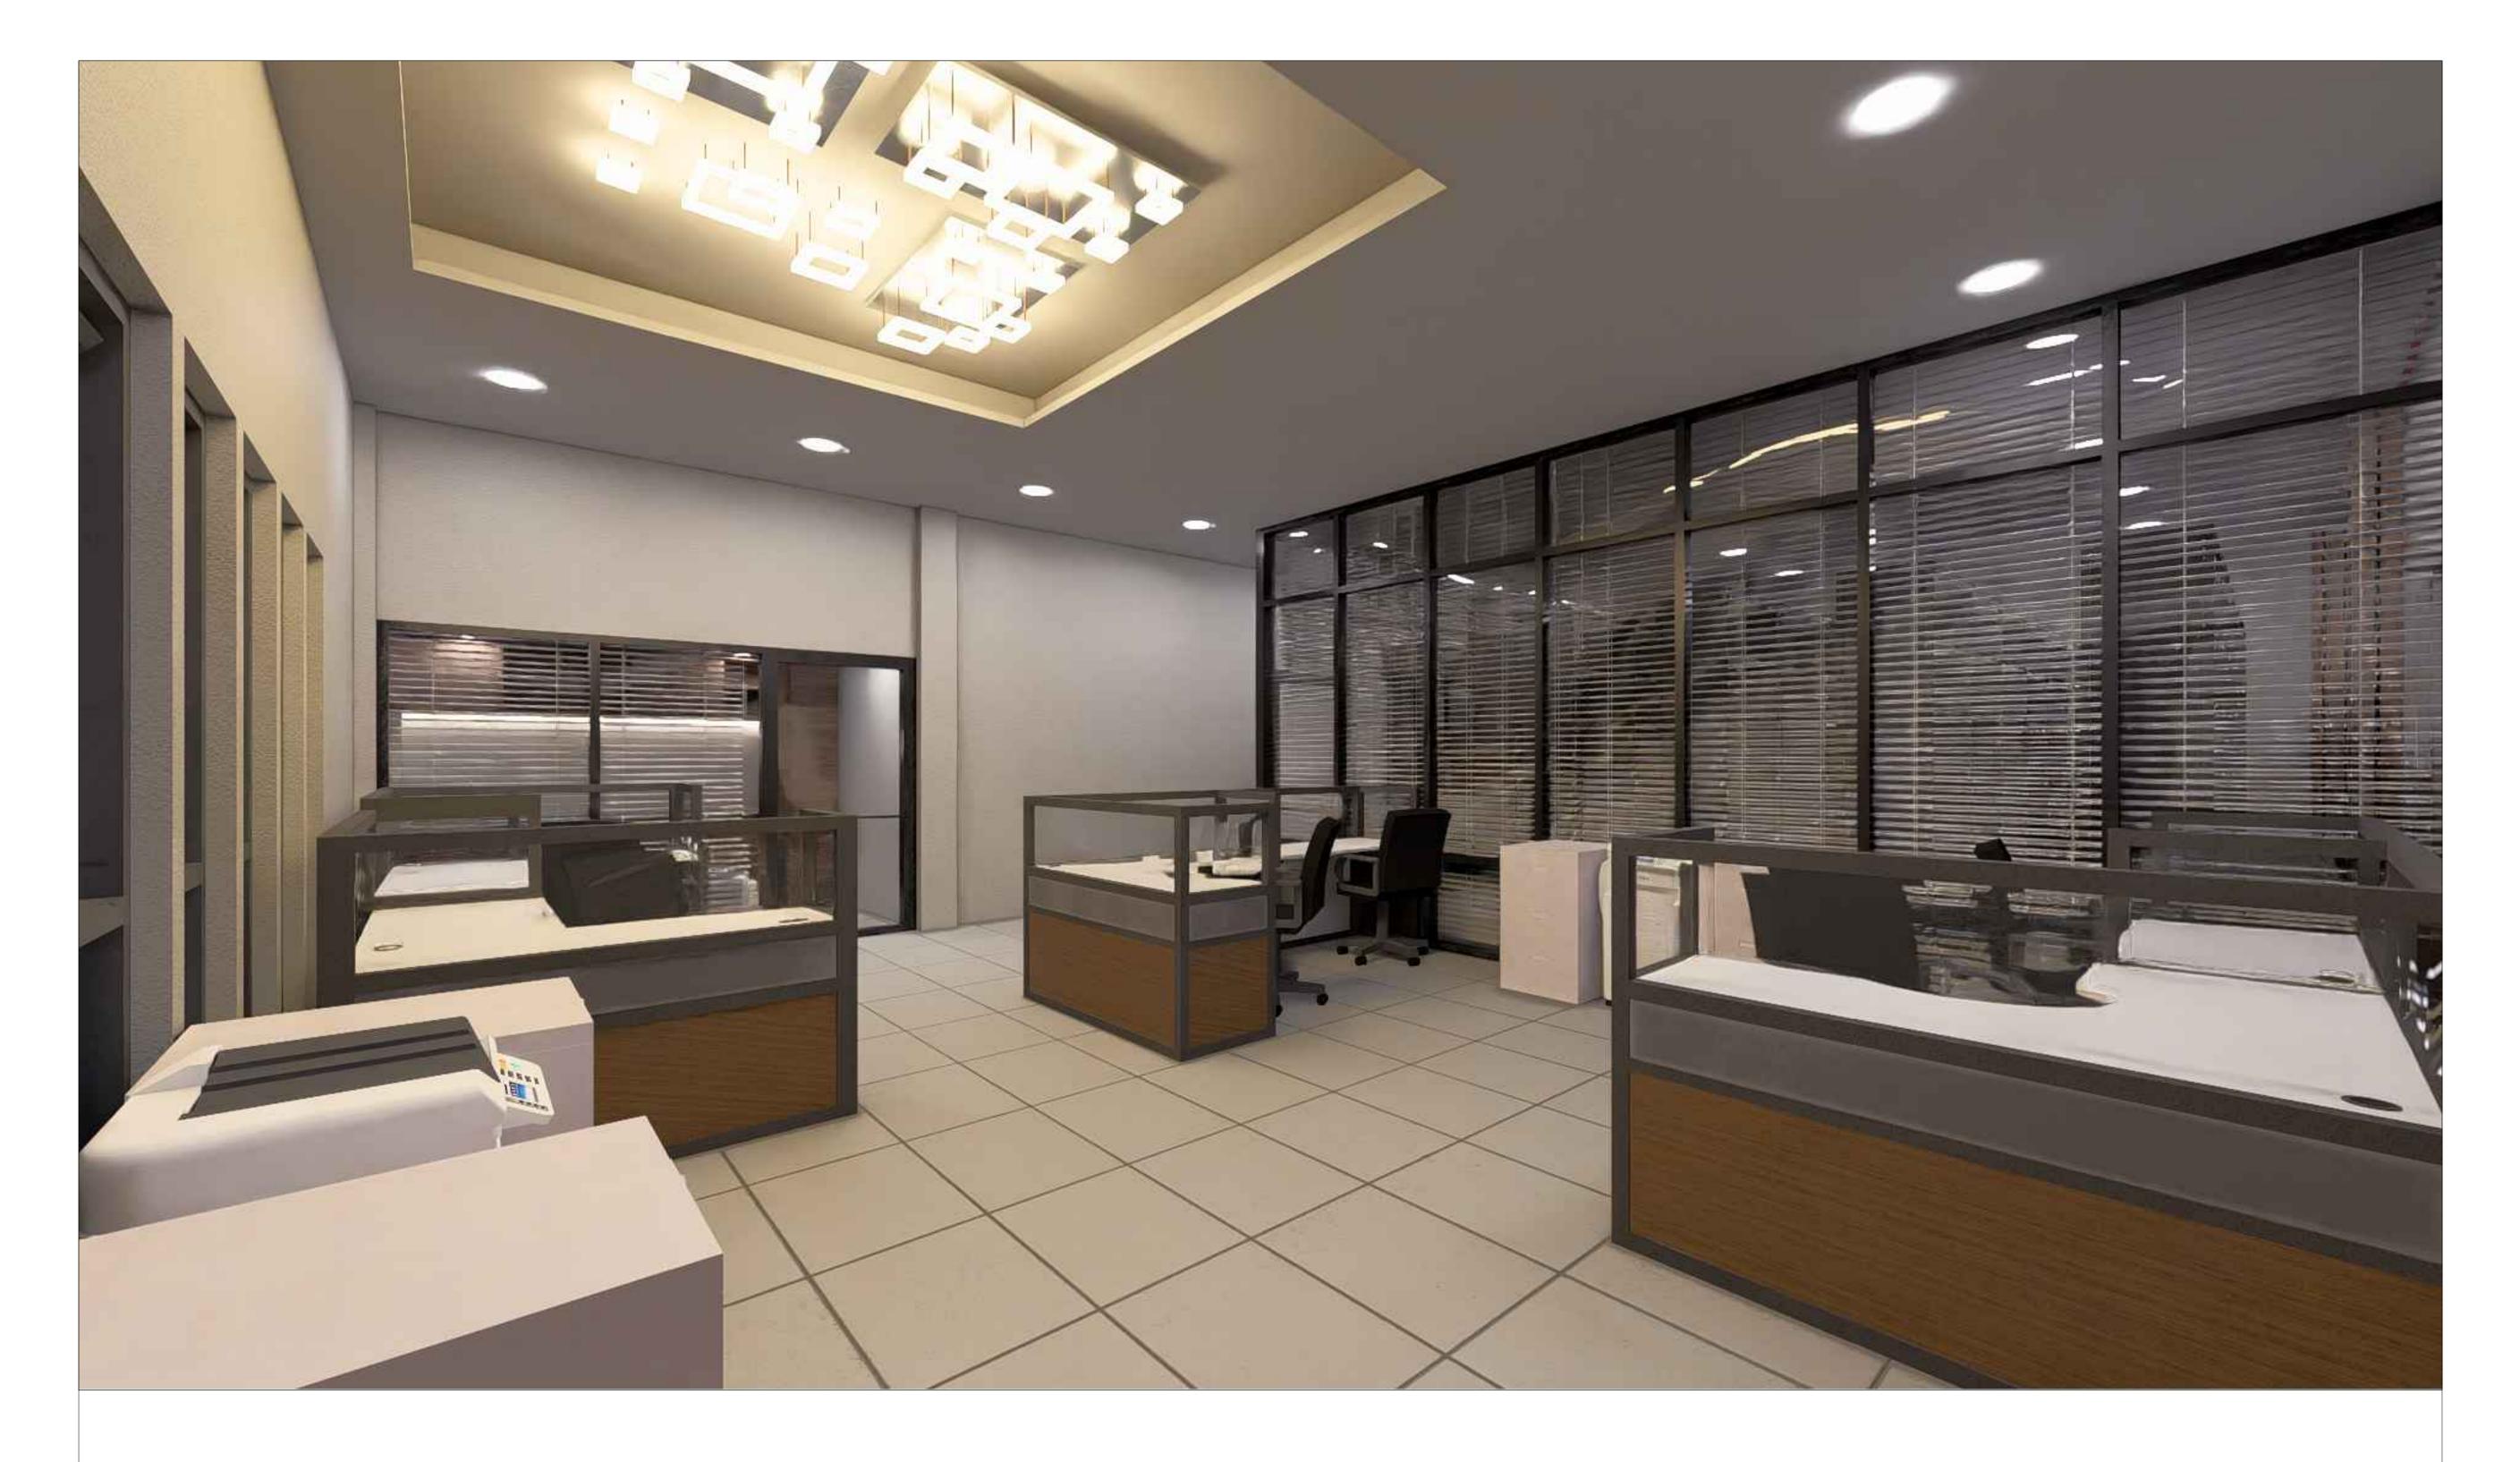


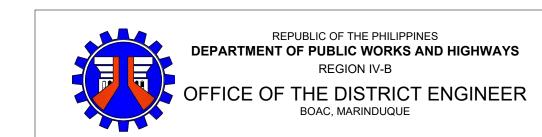


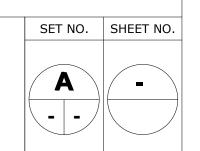

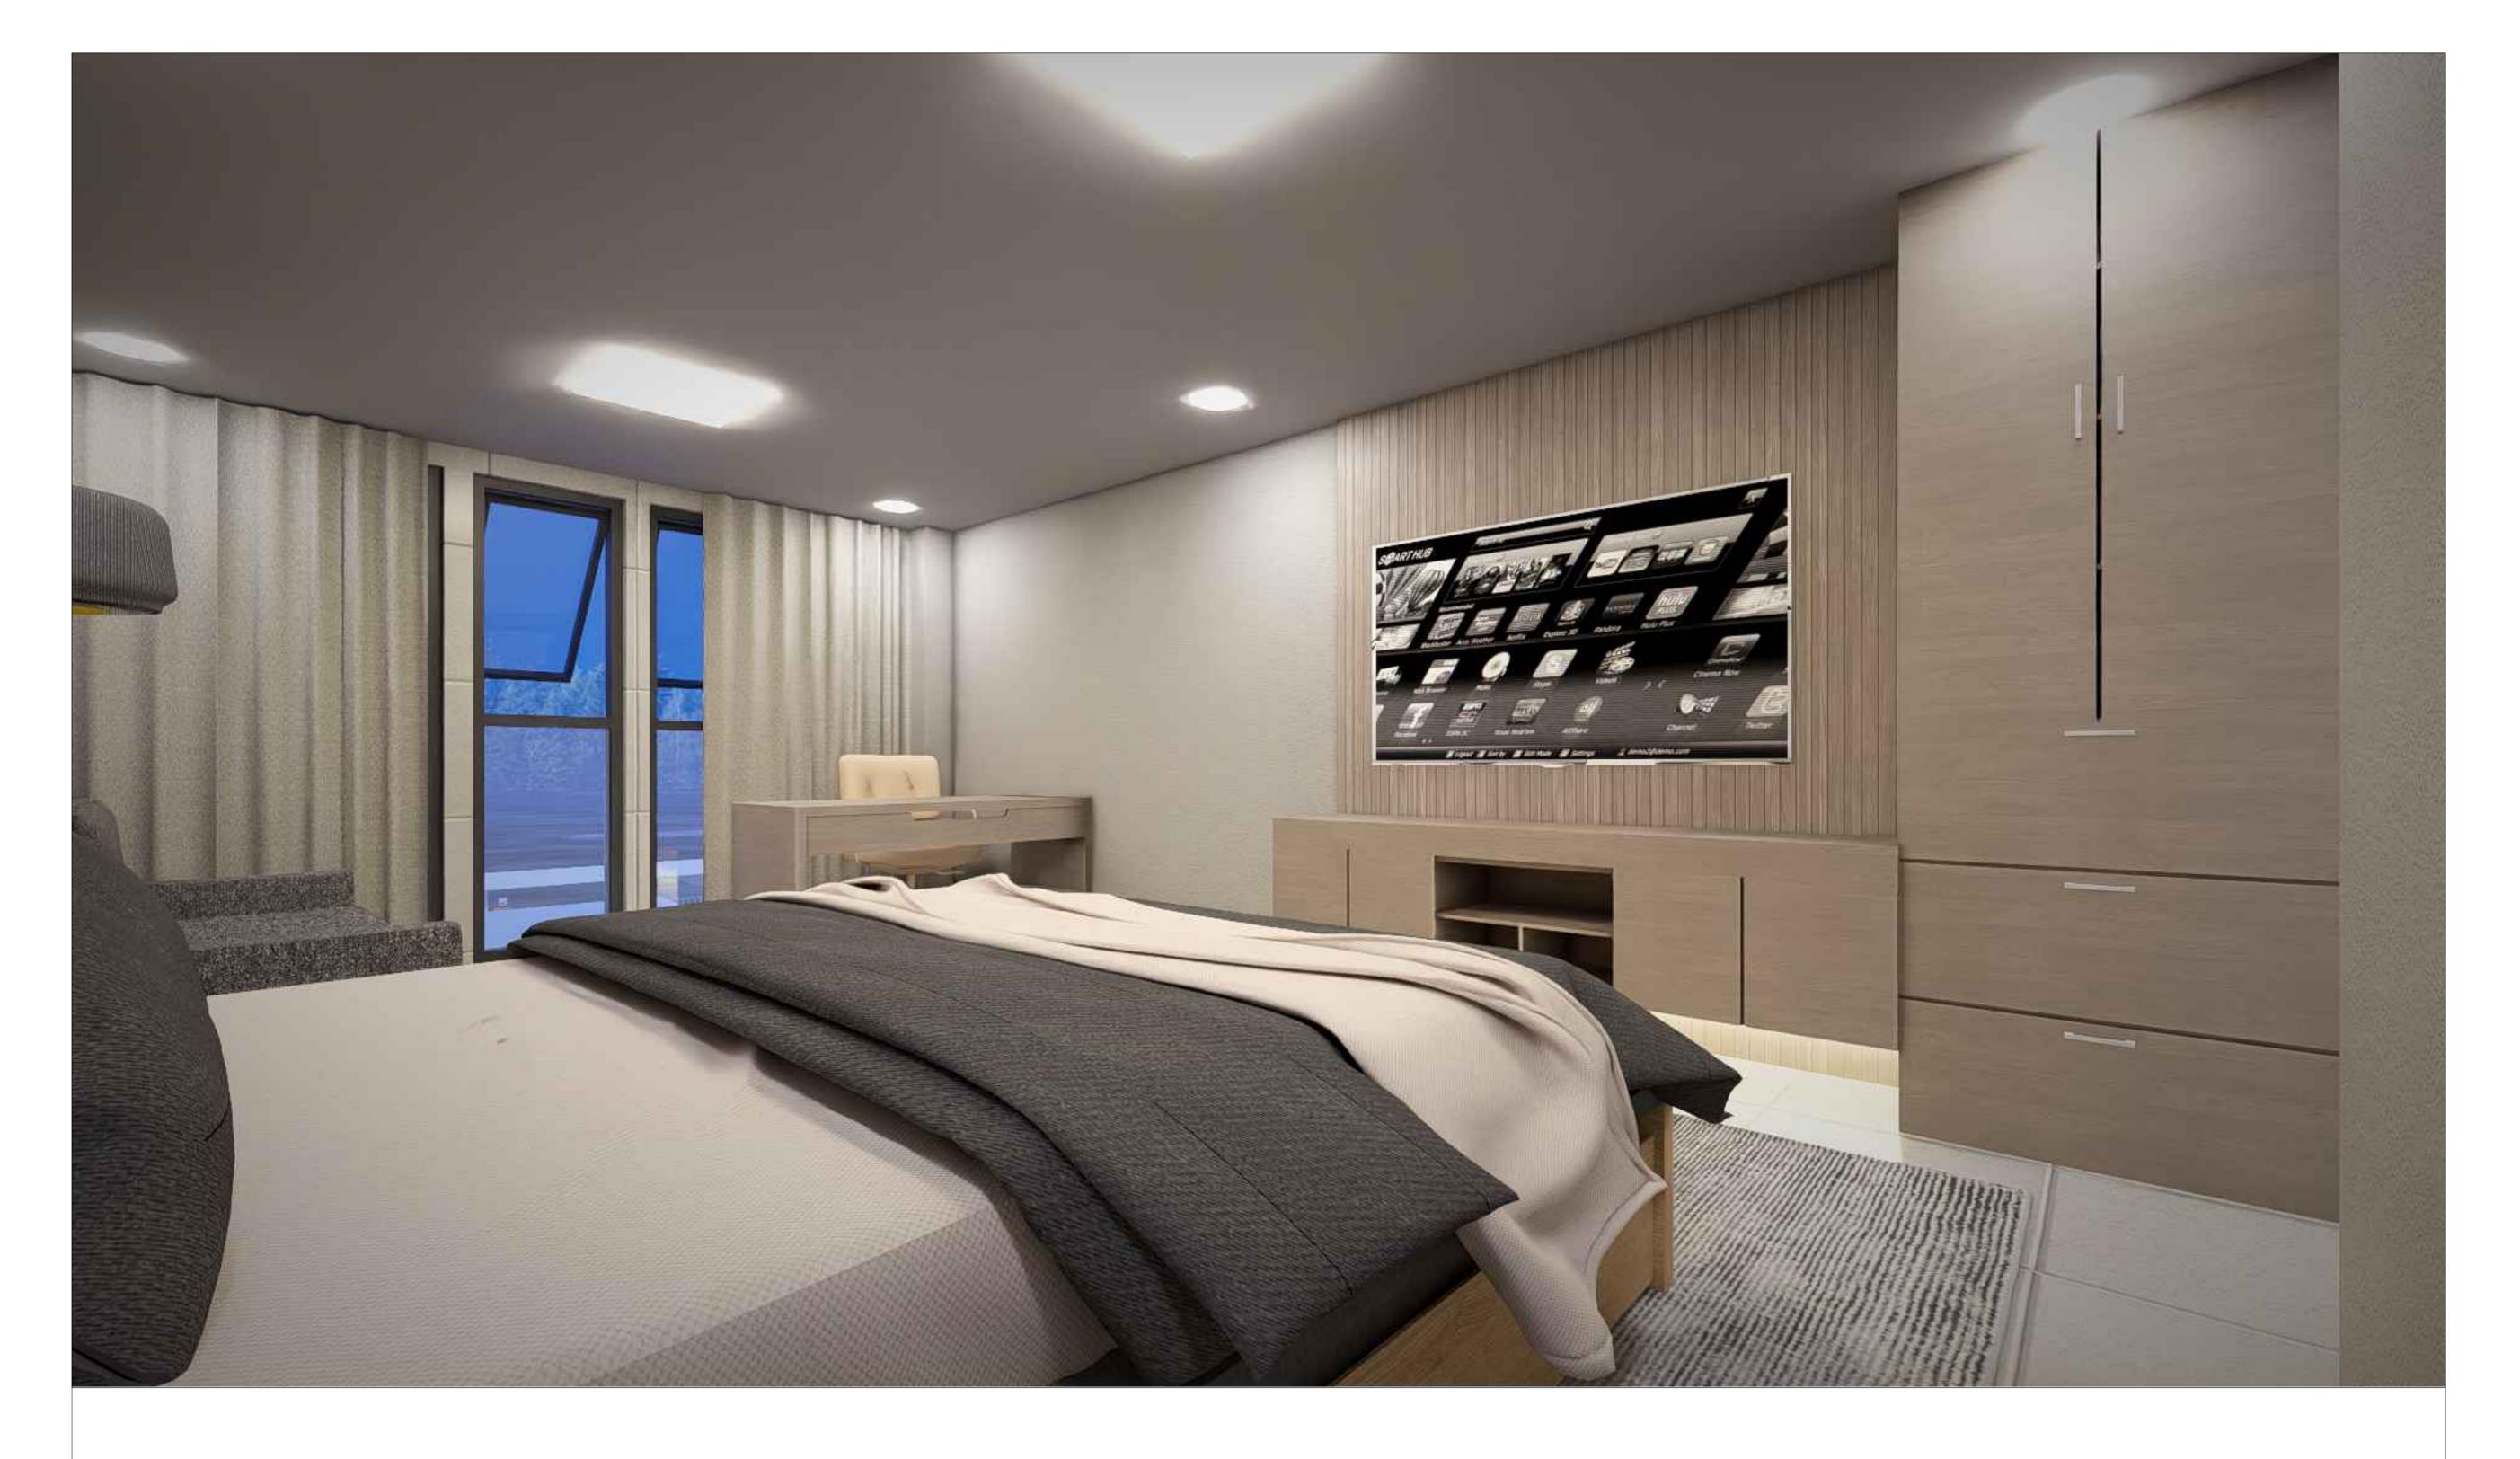

P E R S P E C T I V E

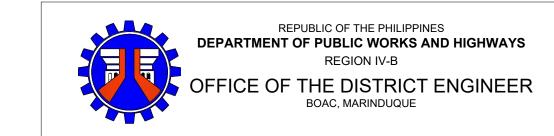

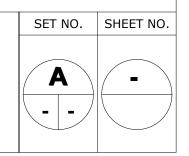



P E R S P E C T I V E

